DESIGNNTENT

DRAWINGS

NIRPC Unified Trail Wayfinding

August 2016



Northwestern Indiana Regional Planning Commision (NIRPC) 6100 Southport Road Portage, Indiana 46368

Contact: Mitch Barloga, AICP hone: 219.763.6060 x133 ax: 219.762.1653

The purpose of these drawings is to illustrate design intent. Drawings are not for construction. Written dimensions on these drawings have precedence over scaled dimensions.

The further development and engineering of these drawings shall be submitted as shop drawings to the Project Owner. Contractors shall verify and be responsible for all final quality, dimensions, materials and conditions on the job.

Project owner shall be notified of any variations from the dimensions and conditions shown by these drawings prior to the execution of any work, including changes to graphic designs or typography.

Drawing scale shown on plans is for full size plans only. Alta shall not be responsible for scale discrepancies caused by reduced or enlarged drawings.

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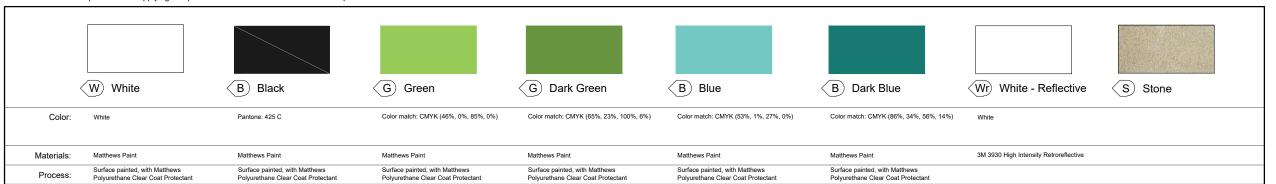


Alta Planning + Design

800 S Broadway, 2nd Floor Front Baltimore, MD 21231 ph: 443.218.8165

MATERIALS PALETTE

Contractor shall be responsible for supplying samples for all colors and materials within the palette.



TYPOGRAPHY

Fabricator is responsible for acquiring project related fonts.

Aa Bb Cc Dd Ee Ff Gg Hh Ii Jj Kk Ll Mm Nn Oo Pp Qq Rr Ss Tt Uu Vv Ww Xx Yy Zz 1234567890

Aa Bb Cc Dd Ee Ff Gg Hh Ii Jj Kk Ll Mm Nn Oo Pp Qq Rr Ss Tt Uu Vv Ww Xx Yy Zz 1234567890

ARTWORK

All artwork illustrated on this page shall be provided by Project Owner as electronic vector art.




Northwest Indiana Greenways & Blueways Logo



Calumet Trail Logo



Dunes Kankakee Trail Logo

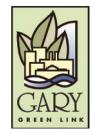

Gary Green Link Logo



Chesapeake and Ohio Greenway Logo



Oak Savannah Trail Logo



matching all colors and materials as specified and are required to provide color and material sample to the Project Owner for approval.

Contractor is responsible for

All painted surfaces to receive UV and Anti-Graffitti coating. All retroreflective material to receive UV/Anti-Graffiti overlaminate. or owner approved equal.

No substitute typefaces will be accepted. Set kerning tracks to visually approximate sign drawings. Kerning shown may vary from exact kerning used to create sign drawings. Refer to specific applications for type sizes and leading requirements.



Praire Grass Silhouette

Destination Travel Distance & Times



American Discovery Trail Logo

Typical Arrow



The Marquette Greenway Logo



Veterans Memorial Parkway Logo



Prarie Duneland Trail Logo



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- Hardware: All exposed hardware shall be tamper proof fasteners.
- All exposed edges painted to match
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- Messages shown in these drawings are for general reference only. Refer to message schedules for actual required messages.

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NIRPC Unified Trail Wayfinding

08 August 2016

DOCUMENT ISSUE

Graphic Standards

SHEET TITLE













WELCOME SIGN

VEHICULAR TRAILHEAD MAP KIOSK

PEDESTRIAN DIRECTIONAL PEDESTRIAN REGULATORY

MILE MARKER



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NIRPC Unified Trail Wayfinding

PROJECT


■ 08 August 2016


DOCUMENT ISSUE

System Overview


SHEET TITLE


3

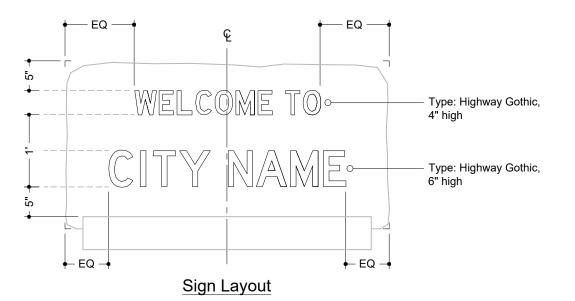

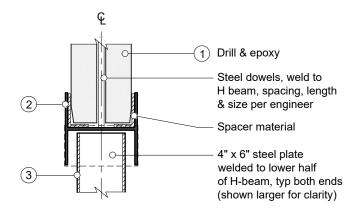



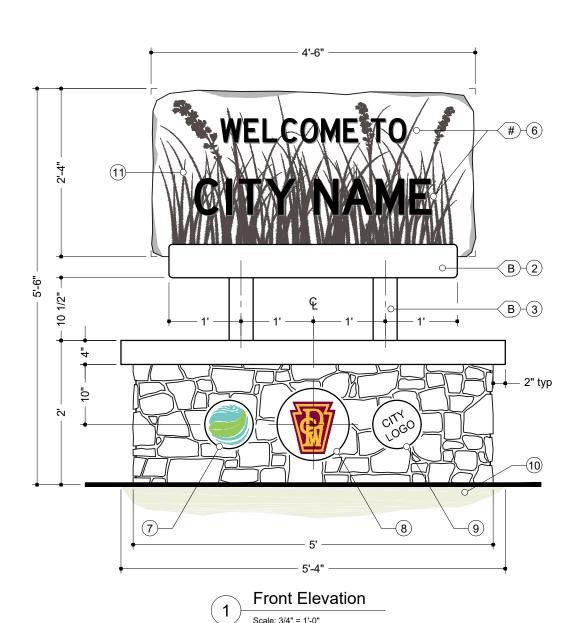

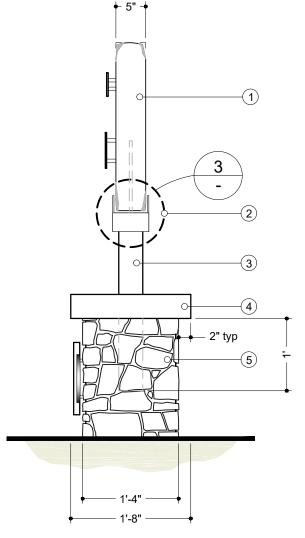

Side Elevation

Scale: 3/4" = 1'-0"

1. LIMESTONE SIGN

4'-6" L x 2'-4" W x 5" thick
MATERIAL: Indiana limestone
ASTM C568, Type II, Medium density limstone

2. STEEL HEADER

Structural steel H beam, W 6 X15 lb (5.99" x .230" web x 5.99"). 1/2" fillet on all corners

3. SUPPORT POST

Square A500 steel tube, 4 x 4 x 3/8" wall. Embedded into monument wall and welded to steel header

4. LIMESTONE CAP

Smooth top and bottom, rock face sides. SIZE: 5'-4" L x 1'-8" W x 4" H

5. MONUMENT WALL

SIZE: 5-0" L x 1'-4" W x 1'-8" H Limestone natural stone veneer, depth 1-1/4" nominal (3/4" to 1-1/2"), color to match sign FABRICATION: Standard masonary construction

6. LETTERING

1/2" thick aluminum letters, pin-mounted 1/2" from face of sign

7. GREENWAYS & BLUEWAYS LOGO

MATERIAL: 8" dia x 1/4" thick aluminum FABRICATION PROCESS: Router Cut EDGES: Routed, finished smooth FASTENER: Pin mounted GRAPHICS/TEXT: digitally printed

8. TRAIL LOGO

MATERIAL: 12" dia x 1/4" thick aluminum FABRICATION PROCESS: Router Cut EDGES: Routed, finished smooth FASTENER: Pin mounted GRAPHICS/TEXT: digitally printed

9. CITY LOGO

MATERIAL: 8" dia x 1/4" thk. aluminum FABRICATION PROCESS: Router Cut EDGES: Routed, finished smooth FASTENER: Pin mounted GRAPHICS/TEXT: digitally printed

10. CONCRETE FOOTING

Concrete footing to engineer's specifications

11. ENGRAVING

Sandblasted 'Prairie Grass' silhouette



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NIRPC Unified Trail Wayfinding

PROJECT


08 August 2016


DOCUMENT ISSUE

Welcome Sign

SHEET TITLE

4

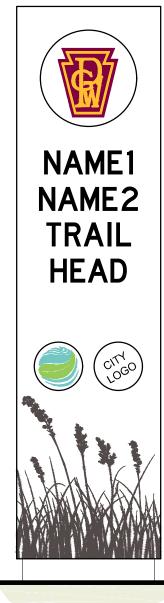

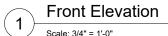



Rear Elevation

KEY NOTES

1. ALUMINUM SLEEVE & FRAME

MATERIAL: 1/8" thick aluminum
Fabricated alumimum sheet sign face and
back, fully welded and fabricated sides with all
edges and corners neatly finished
FRAME: Fabricated aluminum channel internal
structure to engineer's specification. Frame to
be set inside perimeter of sign sleeve

2. TRAIL LOGO

MATERIAL: 12" dia x 1/4" thick aluminum FABRICATION PROCESS: Router Cut EDGES: Routed, finished smooth FASTENER: adhesive GRAPHICS/TEXT: digitally printed

3. RAISED LETTERING

MATERIAL: 1/2" thick aluminum EDGES: Routed, finished smooth FASTENER: adhesive

4. GREENWAYS & BLUEWAYS LOGO

MATERIAL: 8" dia x 1/4" thick aluminum FABRICATION PROCESS: Router Cut EDGES: Routed, finished smooth FASTENER: adhesive GRAPHICS/TEXT: digitally printed

5. CITY LOGO

MATERIAL: 8" dia x 1/4" thick aluminum FABRICATION PROCESS: Router Cut EDGES: Routed, finished smooth FASTENER: adhesive GRAPHICS/TEXT: digitally printed

6. DIGITAL PRINT

Digitally printed 'Praire Grass' silhouette and stone texture (not shown)

7. CONCRETE FOOTING

Concrete footing to engineer's specifications. Conceal hold down bolts within sign structure



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NIRPC Unified Trail Wayfinding

PROJECT

08 August 2016

DOCUMENT ISSUE

Vehicular Trailhead Sign

SHEFT TITLE

5

SHEET NUMBER

le: 3/4" = 1'-0"

GRAPHICS/TEXT: digitally printed

2. GREENWAYS & BLUEWAYS LOGO MATERIAL: 6" dia x 1/4" thk. aluminum FABRICATION PROCESS: Router Cut EDGES: Routed, finished smooth

FASTENER: adhesive GRAPHICS/TEXT: digitally printed

3. CITY LOGO

MATERIAL: 6" dia x 1/4" thk. aluminum FABRICATION PROCESS: Router Cut EDGES: Routed, finished smooth FASTENER: adhesive GRAPHICS/TEXT: digitally printed

4. ALUMINUM SLEEVE & FRAME

MATERIAL: 1/8" thick aluminum
Fabricated alumimum sheet sign face and
back, fully welded and fabricated sides with all
edges and corners neatly finished
FRAME: Fabricated aluminum channel internal
structure to engineer's specification. Frame to
be set inside perimeter of sign sleeve

5. MAP PANEL:

MATERIAL: Non-glare clear acrylic panel, high pressure laminate map panel.
ARTWORK: Directory map shown for reference only. Map with all associated texts and pictograms to be provided in digital format. FASTENER: (6) six stainless steel Ø1-1/2" x 1" length stand-offs, tamper-proof

6. LOCATION PANEL

MATERIAL: 1/8" thick aluminum EDGES: Routed, finished smooth FASTENER: adhesive GRAPHICS/TEXT: digitally printed

7. DIGITAL PRINT

Digitally printed 'Praire Grass' silhouette and stone texture (not shown)

8. CONCRETE FOOTING

Concrete footing to engineer's specifications. Conceal hold down bolts within sign structure

9. LOGO TOP PANEL

MATERIAL: 1/8" thick aluminum FASTENER: welded



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NIRPC Unified Trail Wayfinding

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PROJECT

CLIENT

08 August 2016

DOCUMENT ISSUE


Map Kiosk

SHEET TITL

6

SHEET NUMBER

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Front Elevation

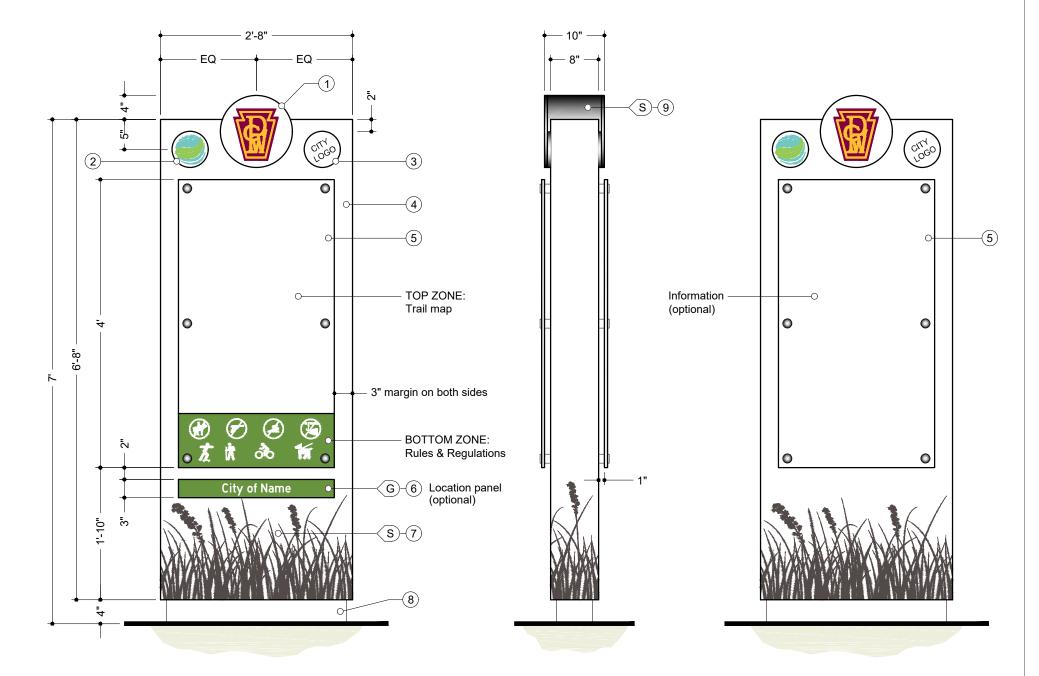

Rear Elevation

Scale: 3/4" = 1'-0"

1. ALUMINUM SLEEVE & FRAME

2. **DESTINATION PANEL**

FASTENER: adhesive

FASTENER: adhesive

FASTENER: adhesive

FASTENER: adhesive

FASTENER: adhesive

FASTENER: adhesive

stone texture (not shown)

9. CONCRETE FOOTING

6. TRAIL LOGO

7. CITY LOGO

8. DIGITAL PRINT

4. WELCOME PANEL

3. LOCATION PANEL

Panel wraps around sleeve

Panel wraps around sleeve

Panel wraps around sleeve

MATERIAL: 1/8" thick aluminum

EDGES: Routed, finished smooth

GRAPHICS/TEXT: digitally printed

MATERIAL: 1/8" thick aluminum

EDGES: Routed, finished smooth

GRAPHICS/TEXT: digitally printed

5. GREENWAYS & BLUEWAYS LOGO

GRAPHICS/TEXT: digitally printed

MATERIAL: 4" dia x 1/4" thk. aluminum

FABRICATION PROCESS: Router Cut EDGES: Routed, finished smooth

MATERIAL: 4" dia x 1/4" thk. aluminum

FABRICATION PROCESS: Router Cut

MATERIAL: 4" dia x 1/4" thk. aluminum

FABRICATION PROCESS: Router Cut EDGES: Routed, finished smooth

Digitally printed 'Praire Grass' silhouette and

Concrete footing to engineer's specifications. Conceal hold down bolts within sign structure

GRAPHICS/TEXT: digitally printed

EDGES: Routed, finished smooth

GRAPHICS/TEXT: screen printed

FABRICATION PROCESS: Router cut

FABRICATION PROCESS: Router cut

MATERIAL: 1/8" thick aluminum FABRICATION PROCESS: Router cut

EDGES: Routed, finished smooth

GRAPHICS/TEXT: digitally printed

MATERIAL: 1/8" thick aluminum

edges and corners neatly finished

be set inside perimeter of sign sleeve

Fabricated alumimum sheet sign face and

back, fully welded and fabricated sides with all

FRAME: Fabricated aluminum channel internal

structure to engineer's specification. Frame to

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Northwestern Indiana Regional Planning Commission

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NIRPC Unified Trail Wayfinding

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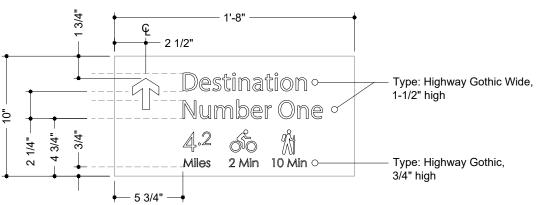
08 August 2016

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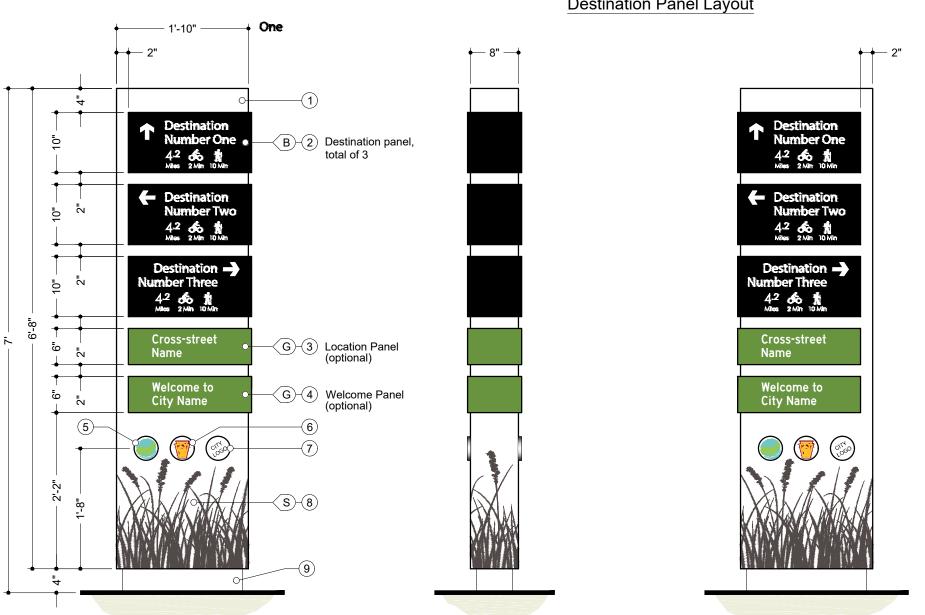
Pedestrian Directional Sign

A -----

SHEET NUMBER



Destination Panel Layout



signs wrapped around


Right Side Elevation


Rear Elevation Scale: 3/4" = 1'-0"


Front Elevation

Scale: 3/4" = 1'-0"


Note: Left side similiar but w/o

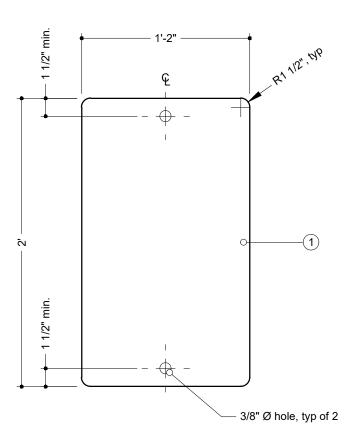


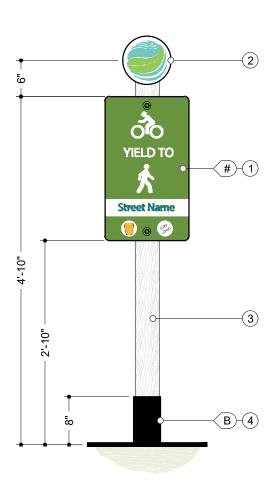

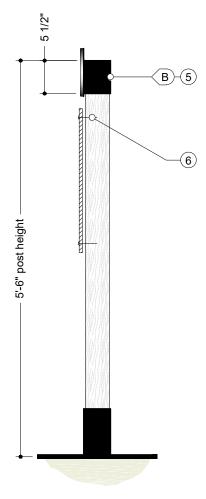

Sign Layout Scale: 1 1/2" = 1'-0"

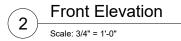

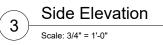

alta Alta Planning + Design 800 S Broadway, Baltimore, MD 21231 ph: 443.218.8165

1. SIGN PANEL

MATERIAL: 1/8" thick aluminum FABRICATION PROCESS: Router cut EDGES: Routed, finished smooth FASTENER: adhesive

GRAPHICS/TEXT: digitally printed

2. GREENWAYS & BLUEWAYS LOGO MATERIAL: 8" dia x 1/4" thk. aluminum FABRICATION PROCESS: Router Cut EDGES: Routed, finished smooth FASTENER: welded to post cap

3. WOOD POST

MATERIAL: 4" x 4" pressure treated wood INSTALLATION: 30" min. bury or surface mount per engineer's specifications

4. POST BRACKET

MATERIAL: steel, design by engineer FABRICATION PROCESS: welded FASTENER: Per engineer's specifications

5. POST CAP

MATERIAL: 1/8" thick aluminum Fabricated alumimum sheet top, fully welded and fabricated sides with all edges and corners neatly finished

FASTENER: mechanically fasten to wood post

6. SIGN FASTENERS

Per engineer's specifications

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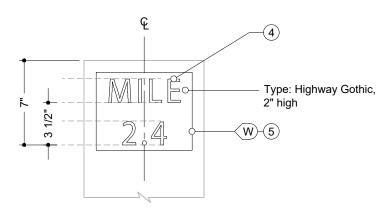
PROJECT


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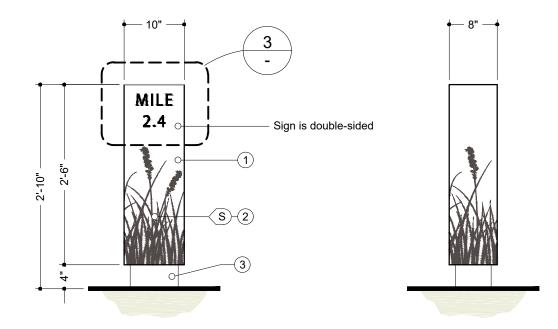
DOCUMENT ISSUE


Pedestrian Regulatory Sign • ------


8





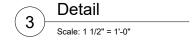

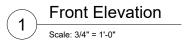

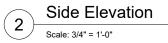

KEY NOTES

1. ALUMINUM SLEEVE & FRAME

MATERIAL: 1/8" thick aluminum
Fabricated alumimum sheet sign face and
back, fully welded and fabricated sides with all
edges and corners neatly finished
FRAME: Fabricated aluminum channel internal
structure to engineer's specification. Frame to

structure to engineer's specification. Frame to be set inside perimeter of sign sleeve

2. DIGITAL PRINT

Digitally printed 'Praire Grass' silhouette and stone texture (not shown)

3. CONCRETE FOOTING

Concrete footing to engineer's specifications. Conceal hold down bolts within sign structure

4. CUT-OUT TEXT

Text and numbers cut out of aluminum sleeve. EDGES: Routed, finished smooth

5. BACK PANEL

MATERIAL: 1/8" thick aluminum FASTENER: welded to sleeve



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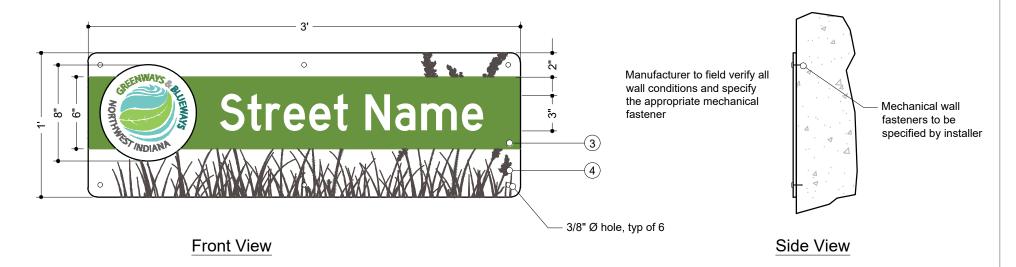
08 August 2016

DOCUMENT ISSUE

Mile Marker Post


SHEET TITLE

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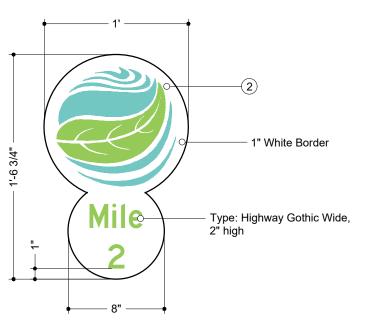


Trail Underpass Sign

Scale: 1 1/2" = 1'-0"



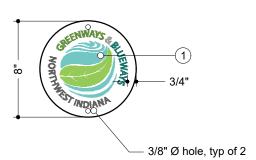



Pavement Marking

Scale: 1 1/2" = 1'-0"

1. GREENWAYS & BLUEWAYS LOGO

MATERIAL: 1/4" thick aluminum
FABRICATION PROCESS: router cut
EDGES: routed, finished smooth
FASTENER: per engineer's specifications
GRAPHICS/TEXT: digitally printed

2. PAVEMENT MARKING

MATERIAL: Preformed thermoplastic

3. UNDERPASS SIGN

Final size of sign dependant on sign placement and at the discretion of the engineer to ensure legibility for trail users.

MATERIAL: 4 thick aluminum

MATERIAL: 4" thick aluminum
FABRICATION PROCESS: router cut
EDGES: routed, finished smooth
FASTENER: per engineer's specifications
GRAPHICS/TEXT: digitally printed

4. DIGITAL PRINT

Digitally printed 'Prairie Grass' silhouette and stone texture (not shown)



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Mile Marker Post

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