PROJECT DESIGNATION 1006017 CONTRACT BRIDGE FILE R-35164

INDIANA DEPARTMENT OF TRANSPORTATION

ENGINEERING PLANS FOR PROPOSED TRAIL AT NORTHSIDE BUSINESS PARK

PORTAGE TOWNSHIP, PORTER COUNTY, IN

P.E. N/A R/W

N/A

CONST.

CITY OF PORTAGE BOARD OF PUBLIC WORKS AND SAFETY

James E. Snyder, Mayor

Larry Smock, Member


TOWNSHIP 37 N, RANGE 7 W, SECTION 36 TOWNSHIP 36 N, RANGE 7 W, SECTION 1 SOUTH SHORE R.R. NORFOLK SOUTHERN ROUTE 12 SHEPHERD DR. END TRAIL CONSTRUCTION END TRAIL CONSTRUCTION BURNS WATERWAY STA 42+54 STA 55+03 BEGIN TRAIL CONSTRUCTION END TRAIL CONSTRUCTION STA 50+00 STA 105+13 BEGIN TRAIL CONSTRUCTION AMERIPLEX DRIVE STA 80+05 BEGIN TRAIL CONSTRUCTION END TRAIL CONSTRUCTION STA 72+10 STA 60+00 ROUTE 20 EAGLE AVE. CARDINAL AVE.

OCATION MAP

3-2500 PHONE 22/2012 DATE	
DATE	

PHONE: 219.513.2500 9200 CALUMET AVENUE SUITE N501 MUNSTER, IN 46321

TRAFFIC DATA A.A.D.T. V.P.D. A.A.D.T. V.P.D. V.P.H. DIRECTIONAL DISTRIBUTION % % D.H.V. % A.A.D.T. DESIGN DATA DESIGN SPEED 20 mph
TRAIL CONSTRUCTION PROJECT DESIGN CRITERIA FUNCTIONAL CLASSIFICATION RURAL/URBAN TERRAIN LEVEL ACCESS CONTROL

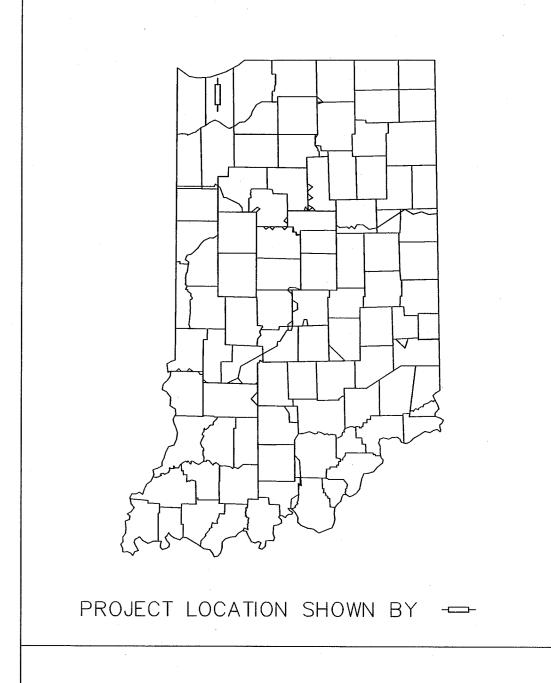

PROJECT LENGTH: 6,212 LF **MAXIMUM GRADE:** 3.89% MINIMUM GRADE: 0.29% LONGITUDE: 41.467943 N LATITUDE: 87.061543 W

> FINAL TRACINGS SUBMITTAL JUNE 7, 2012



[INDIANA DEPARTMENT OF TRANSPORTATION STANDARD SPECIFICATIONS DATED 2012 TO BE USED WITH THESE SET OF PLANS

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	REVISIONS	
DAT	SHEET NO.	

FEDERAL HIGHWAY ADMINISTRATION U.S. DEPT. OF TRANSPORTATION APPROVED:

DIVISION ADMINISTRATOR

BEGIN TRAIL CONSTRUCTION STA 23+25

SHORT ELLIOTT HENDRICKSON, INC. (219) 513-2500 PHONE 05/22/2012 APPROVED FOR LETTING:

- 1. THE CONTRACTOR SHALL PROVIDE FULL DEPTH SAW CUTS WHERE EXISTING PAVEMENT, CONCRETE OR ASPHALT IS TO BE REMOVED. THE CONTRACTOR SHALL PROVIDE ADEQUATE COMPACTED MATERIAL/GRAVEL AT SAW CUT EDGE TO SHORE UP AND PREVENT THE DEGRADATION OF THE EXISTING PAVEMENT TO REMAIN. DAMAGE TO EXISTING PAVEMENT WILL BE REPAIRED AT THE CONTRACTOR'S EXPENSE.
- 2. THE CONTRACTOR SHALL PLACE AND MAINTAIN A 6" GRAVEL BASE AT ALL PROPOSED ENTRANCES TO THE CONSTRUCTION SITE, PRIOR TO DEMOLITION.
- 3. EROSION CONTROL PROVISIONS SHALL BE IN PLACE PRIOR TO ALL OPERATIONS. THE CONTRACTOR SHALL FOLLOW THE CITY'S REQUIREMENTS FOR THE PROJECT AND PRACTICES OUTLINED IN THE "INDIANA HANDBOOK FOR EROSION CONTROL IN DEVELOPING AREAS" REQUIRED FOR THE PREVENTION OF SOIL EROSION AND SEDIMENTATION WITHIN AND DOWNSTREAM OF THE CONSTRUCTION SITE. SAID PRACTICES AND REQUIREMENTS SHALL REMAIN IN PLACE FOR THE DURATION OF THE PROJECT.
- 4. CONTRACTOR SHALL COORDINATE WITH THE CITY OF PORTAGE RELATIVE TO ALL WORK TO BE PERFORMED WITHIN THE CITY OF PORTAGE PUBLIC R.O.W. CONTRACTOR SHALL PROVIDE ALL NECESSARY TRAFFIC CONTROL MEASURES WITHIN PUBLIC R.O.W. AS REQUIRED.
- 5. ALL SIGNS AND PAVEMENT MARKINGS SHALL CONFORM TO INDIANA MANUAL OF UNIFORM TRAFFIC CONTROL DEVICES (IMUTCD), LATEST EDITION. AND INDIANA DEPARTMENT OF TRANSPORTATION STANDARD SPECIFICATIONS AND STANDARD DRAWINGS, LATEST EDITION. ANY SIGNS DAMAGED BY CONSTRUCTION SHALL BE REPLACED AT THE EXPENSE OF THE CONTRACTOR.
- 6. UTILITIES SHOWN ON PLANS ARE APPROXIMATE IN LOCATION AND ARE FOR INFORMATIONAL PURPOSES ONLY AND MAY NOT BE ALL INCLUSIVE. IT IS THE CONTRACTOR'S RESPONSIBILITY TO CONTACT ALL UTILITY COMPANIES WHETHER IDENTIFIED BELOW AND LOCATE ALL UTILITIES PRIOR TO CONSTRUCTION. SHOULD A CONFLICT EXIST, THE CONTRACTOR SHALL IMMEDIATELY CONTACT THE ENGINEER.
- 7. THE CONTRACTOR SHALL CONFORM TO INDIANA DEPARTMENT OF TRANSPORTATION STANDARD SPECIFICATION YEAR 2012, FOR ALL WORK TO BE PERFORMED, UNLESS OTHERWISE SPECIFIED OR NOTED.
- 8. MAINTENANCE OF TRAFFIC DURING CONSTRUCTION SHALL BE PROVIDED FOR ALL PUBLIC RIGHT-OF-WAYS IN ACCORDANCE WITH INDOT STANDARD DRAWINGS AND SPECIFICATIONS. REFER TO STANDARD DRAWING NO. E 801-TCTL-07, E 801-TCLC-12, E 801-TCSN-01, E 801-TCSN-02, E 801-TCSN-01, E 801-TCSN-05, E 801-TCSN-11, E 801-TCSN-12, E 801-TCSN-13, E 801-TCDV-01 AND E 801-TCDV-02 FOR DETAILS.

REVISIONS				
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- TACK COAT SHALL BE APPLIED TO ALL HMA OR CONCRETE PAVEMENT BEFORE PLACEMENT
 OF ANY HMA MIXTURES IN ACCORDANCE WITH INDOT STANDARD SPECIFICATION SECTION 406.
- 10. CONTRACTOR SHALL RESTORE ALL DRIVES AND PAVEMENT TRUE TO HORIZONTAL AND VERTICAL LINES. THE SECTION REMOVED SHALL BE REPLACED TO ITS ORIGINAL CONDITION WHERE INDICATED ON THE PLANS OR BETTER OR AS STATED BY THESE PLANS AND SPECIFICATIONS. ANY DRIVE OR PAVING OUTSIDE THE CONSTRUCTION AREA DAMAGED BY CONSTRUCTION PRACTICES SHALL BE REPAIRED BY THE CONTRACTOR AT NO COST TO THE OWNER.
- 11. WHEN EXCAVATING NEAR UTILITIES, CONTRACTOR SHALL BE RESPONSIBLE FOR SUPPORTING, BRACING OR SHORING AS REQUIRED TO PREVENT DAMAGE TO THE UTILITIES.
- 12. CONTRACTOR SHALL RESTORE ALL AFFECTED SITE CONDITIONS TO THEIR ORIGINAL CONDITION OR BETTER AFTER COMPLETION OF THE WORK. GRASS REQUIRING REPLACEMENT THROUGHOUT THE PROJECT SHALL BE SEEDED PER THE SPECIFICATIONS. ANY DITCH AFFECTED BY THE CONSTRUCTION SHALL BE RE-ESTABLISHED TO ITS ORIGINAL LINE AND GRADE.
- 13. CONTRACTOR SHALL BE RESPONSIBLE FOR ANY DEWATERING. WATER REMOVED BY DEWATERING EQUIPMENT SHALL NOT BE DISPOSED OF INTO SANITARY OR STORM SEWERS WITHOUT WRITTEN APPROVAL BY THE CITY, BOARD OF PUBLIC WORKS.
- 14. WHERE SANITARY MANHOLES ARE LOCATED OUTSIDE OF PAVED AREAS. CONTRACTOR SHALL GRADE AROUND EACH CASTING SO THAT SURFACE WATER SHALL NOT DRAIN INTO OR OVER THE STRUCTURE.
- 15. THE CONTRACTOR SHALL BE RESPONSIBLE FOR THE HEALTH AND SAFETY OF HIS EMPLOYEES AND THE SUBCONTRACTORS PER OSHA REGULATIONS AND ANY OTHER ORGANIZATION HAVING JURISDICTION.
- 16. CONTRACTOR SHALL VISIT THE SITE PRIOR TO SUBMITTING A BID FOR WORK. BY SUBMITTING A BID, THE CONTRACTOR INDICATES THAT HE HAS VISITED THE SITE AND IS AWARE OF ALL EXISTING CONDITIONS.
- 17. NO OPEN TRENCHES WILL BE ALLOWED IN THE EVENING AFTER DAILY CONSTRUCTION OPERATIONS HAVE FINISHED, EXCEPT IN THE AREA OF THE TRENCHING BOX. CONTRACTOR TO PROVIDE CONSTRUCTION FENCING AND NECESSARY WARNING SIGNAGE AROUND TRENCHING BOX AREA FOR PUBLIC SAFETY.

UTILITIES

AMERITECH 302 SOUTH EAST STREET CROWN POINT, INDIANA 46307 219.662.4400	CITY OF PORTAGE ENGINEERING 6070 CENTRAL AVENUE PORTAGE, INDIANA 46368 219.762.4204
NIPSCO BEN SIELSKI 1460 EAST 15TH AVENUE GARY, INDIANA 46402 219.886.5596	INDIANA AMERICAN WATER COMPANY DAVE CLARK 1650 MICHIGAN STREET GARY, IN 46401 219.880.2386
FRONTIER ALLISON BUCHANAN 2401 CHICAGO STREET VALPARAISO, INDIANA 46383 219.531.9237	COMCAST RICK WALSTRA 17 WASHINGTON STREET VALPARAISO, IN 46383 219.462.9990
BP PIPELINES (NORTH AMERICA) INC. NICK SCHILLING 150 W WARRENVILLE ROAD NAPERVILLE, IL 60563 630.536.2172	


- 18. CONTRACTOR SHALL NOTIFY THE CITY OF PORTAGE ENGINEER'S OFFICE AND PUBLIC WORKS OFFICE 48 HOURS PRIOR TO THE INSTALLATION OF THE CONNECTION TO THE EXISTING STRUCTURE/PIPING.
- 19. THE CONTRACTOR SHALL CLEAR AND GRUB ALL NON-PAVEMENT AREAS LOCATED WITHIN THE CONSTRUCTION LIMITS IN ACCORDANCE WITH THE SPECIFICATIONS INCLUDING THE REMOVAL OF ALL TREES OF ALL DIAMETERS, SHRUBS, BUSHES AND MISCELLANEOUS DEBRIS NOT CALLED OUT TO BE PROTECTED ON THE PLANS.
- 20. CONTACT THE ENGINEERING DEPARTMENT FOR SANITARY SEWER, ROADWAY LIGHTING, TRAFFIC SIGNAL AND STORM SEWER INFORMATION.
- 21. CONTRACTOR SHALL MAINTAIN ALL ROADWAY LIGHTING AND TRAFFIC SIGNALS INSTALLED UNDER THIS CONTRACT UNTIL FINAL ACCEPTANCE. RESPONSE TO MAINTENANCE CALLS SHALL BE MADE WITHIN TWO HOURS OR LESS, SEVEN DAYS A WEEK, TWENTY-FOUR HOURS PER DAY.
- 22. CONTRACTOR SHALL PERFORM ALL WORK WITHIN REASONABLE WORK HOURS (7:00 AM TO 7:00 PM) MONDAY THROUGH SATURDAY. CONTRACTOR SHALL NOT WORK ON HOLIDAYS IDENTIFIED IN INDOT SPECIFICATION SECTION 101.23. DEVIATIONS IN WORK SCHEDULE SHALL BE APPROVED IN WRITING BY THE CITY ENGINEER.
- 23. MAINTAIN ROADWAY SIGNAGE DURING CONSTRUCTION.
- 24. ACCESS TO ALL RESIDENCES AND COMMERCIAL FACILITIES SHALL BE MAINTAINED AT ALL TIMES.
- 25. MAINTAIN TRAFFIC CONTROL AND MAINTENANCE OF TRAFFIC MEASURES AT ALL TIMES.
- 26. FOR ADDITIONAL MAINTENANCE OF TRAFFIC, SEE SPECIFICATION SECTION 02200.
- 27. ALL RADII DIMENSIONS ARE FROM BACK OF CURB UNLESS OTHERWISE NOTED.
- 28. CONTRACTOR SHALL VERIFY ALL BENCHMARK ELEVATIONS WITH A CLOSED LEVEL CIRCUIT PRIOR TO CONSTRUCTION. ANY DISCREPANCIES SHALL BE REPORTED TO THE OWNER PRIOR TO START OF CONSTRUCTION.
- 29. CONTRACTOR SHALL PROVIDE TO THE CITY, AS-BUILT DRAWINGS SHOWING ALL DEVIATIONS FROM PLAN INCLUDING BUT NOT LIMITED TO LOCATION, ELEVATION, COLOR OR TYPE. IF A PARTICULAR SHEET OR PLAN HAS NO DEVIATION, CONTRACTOR SHALL SUBMIT THE PLAN AND LABEL "NO DEVIATION FROM PLAN." ALL AS-BUILTS SHALL BE SIGNED AND STAMPED BY THE CONTRACTOR.

SHEET INDEX				
SHEET NO.	DESIGNATION			
1	TITLE SHEET			
2	INDEX & GENERAL NOTES			
3-4	TYPICAL CROSS SECTIONS & DETAILS			
5	OVERALL PLAN			
6	SHEET LAYOUT PLAN			
7-16	PLAN & PROFILES			
17-18	SIGNAGE & STRIPING PLANS			
19	TRAFFIC SIGNAL PLAN			
20-23	LANDSCAPING PLANS			
24-25	EROSION CONTROL PLANS			
26-41	CROSS SECTIONS			





RECOMMENDED FOR APPROVAL	Muchiel Foll DESIGN ENGINEER		05/22/2012 DATE	
DESIGNED:	NM	DRAWN:	JS	
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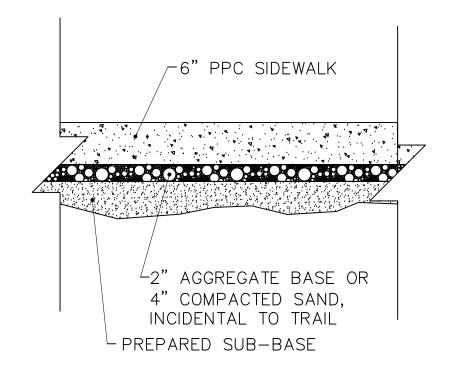


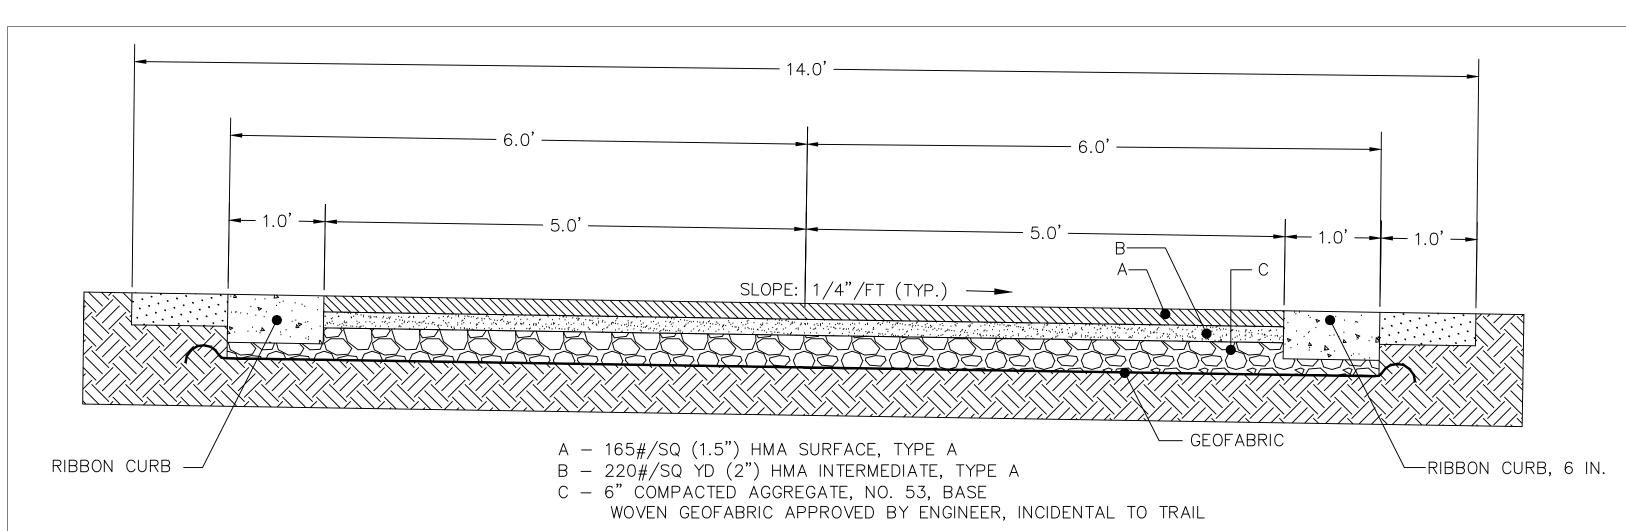ASPHALT TRAIL TYPICAL SECTION


STA. 10+55 - 43+52.22 - LINE A STA. 60+00 - 61+50.00 - LINE B STA. 65+28.84 - 72+45.13 - LINE B STA. 50+00 - 55+58.40 - LINE D

CURVE DATA TABLE


NUMBER	DEFLECTION ANGLE	TANGENT	RADIUS	ARC LENGTH
C7	82°12'58"	26.18	30.00	43.05
C8	94°59'09"	136.38	125.00	207.23
C9	48°22'49"	134.76	300.00	253.32
C10	46°34'27"	236.72	550.00	447.08
C11	25°11'26"	11.17	50.00	21.98
C12	25°05'37"	11.13	50.00	21.90
C13	33°01'30"	14.82	50.00	28.82
C14	32°55'13"	14.77	50.00	28.73
C15	20°36'04"	9.10	50.07	18.00
C16	38°21'14"	17.46	50.20	33.61
C17	16°51'19"	11.11	75.00	22.06
C18	16°28'52"	10.86	75.00	21.57
C19	09°05'25"	23.85	300.00	47.60
C20	09°05'25"	23.85	300.00	47.60
C21	29°12'46"	13.03	50.00	25.49
C22	35°33'17"	160.31	500.00	310.27
C23	129°41'28"	170.36	80.00	181.08
C24	31°17'49"	28.01	100.00	54.62
C25	29°41'30"	26.51	100.00	51.82
C26	50°56'54"	83.37	175.00	155.61
C27	117°15'38"	328.04	200.00	409.32
C28	09°07'29"	39.90	500.00	79.63
C29	14°44'24"	64.67	500.00	128.63
C30	108°03'24"	172.23	125.00	235.74
C31	41°27'29"	151.38	400.00	289.43
C32	54°47'39"	51.83	100.00	95.63
C33	88°35'18"	97.57	100.00	154.62
C34	46°43'14"	64.79	150.00	122.31
C35	26°44'11"	71.29	300.00	139.99
C36	18°08'36"	47.90	300.00	95.00
C37	65°35'43"	96.66	150.00	171.73



TYPICAL CONCRETE SIDEWALK SECTION

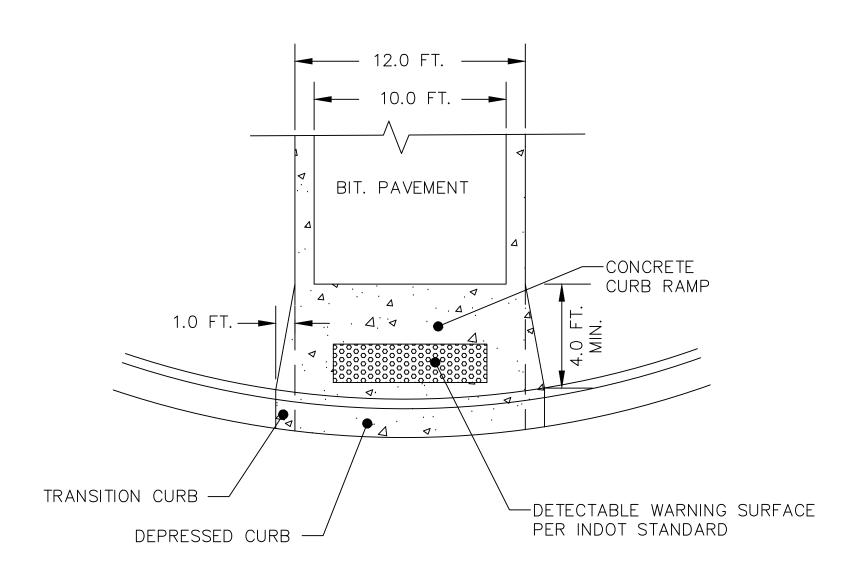


TYPICAL CURB RAMP

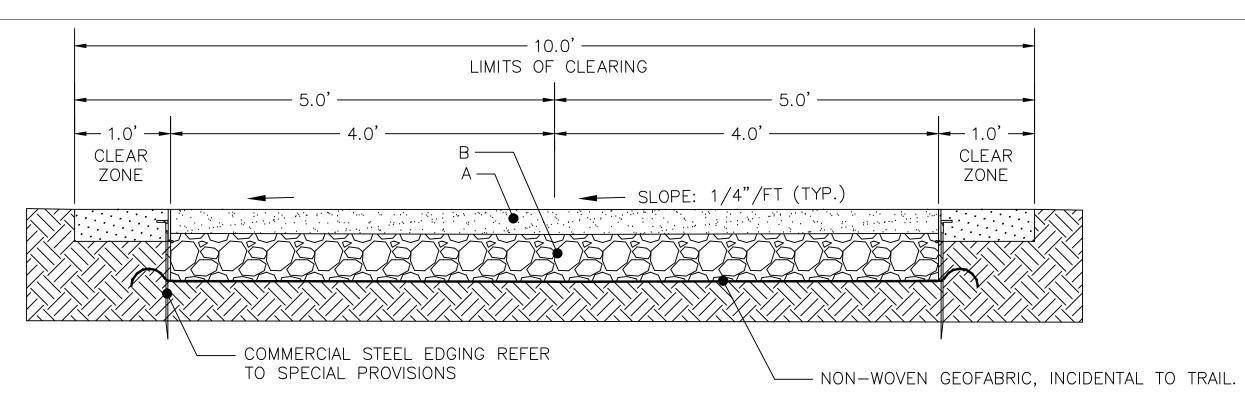


A - 3" COMPACTED LIMESTONE SURFACE B - 6" COMPACTED AGGREGATE, NO. 53, BASE

LIMESTONE TRAIL TYPE "A" TYPICAL SECTION STA. 80+05 - 96+13.44 - LINE C

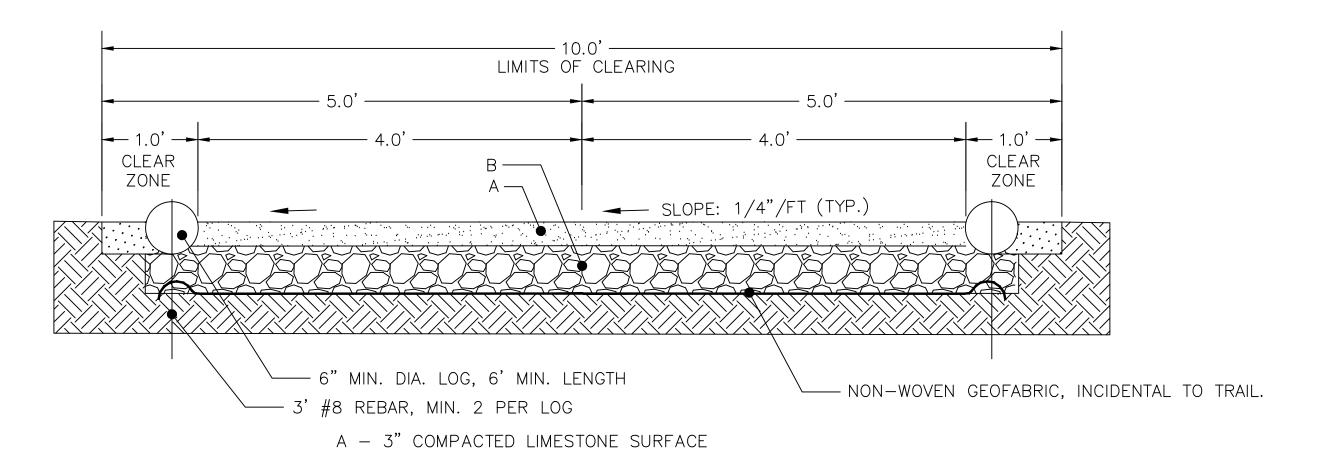

LIMESTONE TRAIL TYPE "B" TYPICAL SECTION STA. 96+13.44 - 104+74.11 - LINE C

B - 6" COMPACTED AGGREGATE, NO. 53, BASE

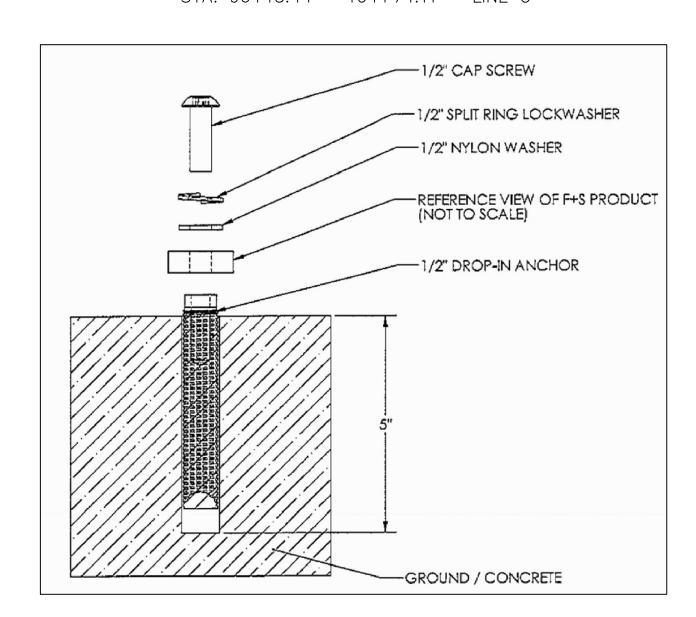


NOTE:

FOR BENCH & TRASH RECEPTACLE TYPE REFER TO SPECIAL PROVISIONS.

BENCH & TRASH RECEPTACLE MOUNTING CONNECTION



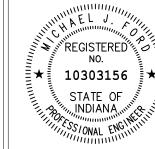



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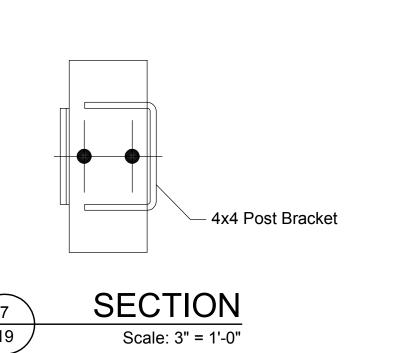
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TYPICAL SECTIONS & DETAILS		3	of	41
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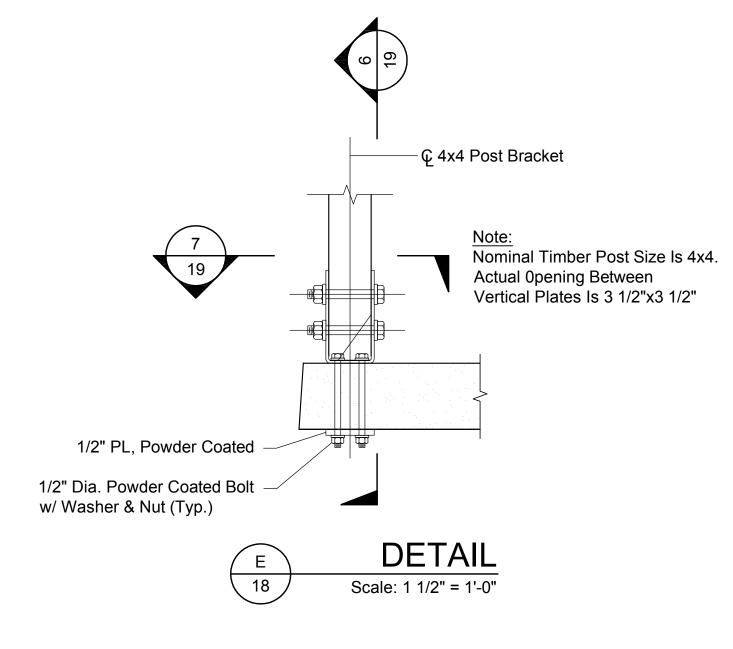
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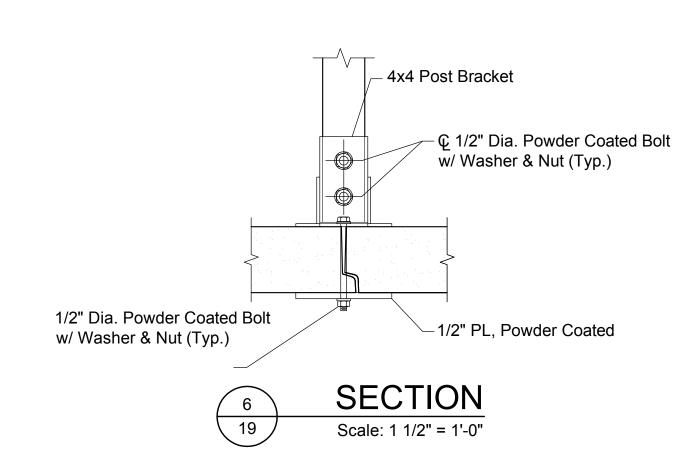
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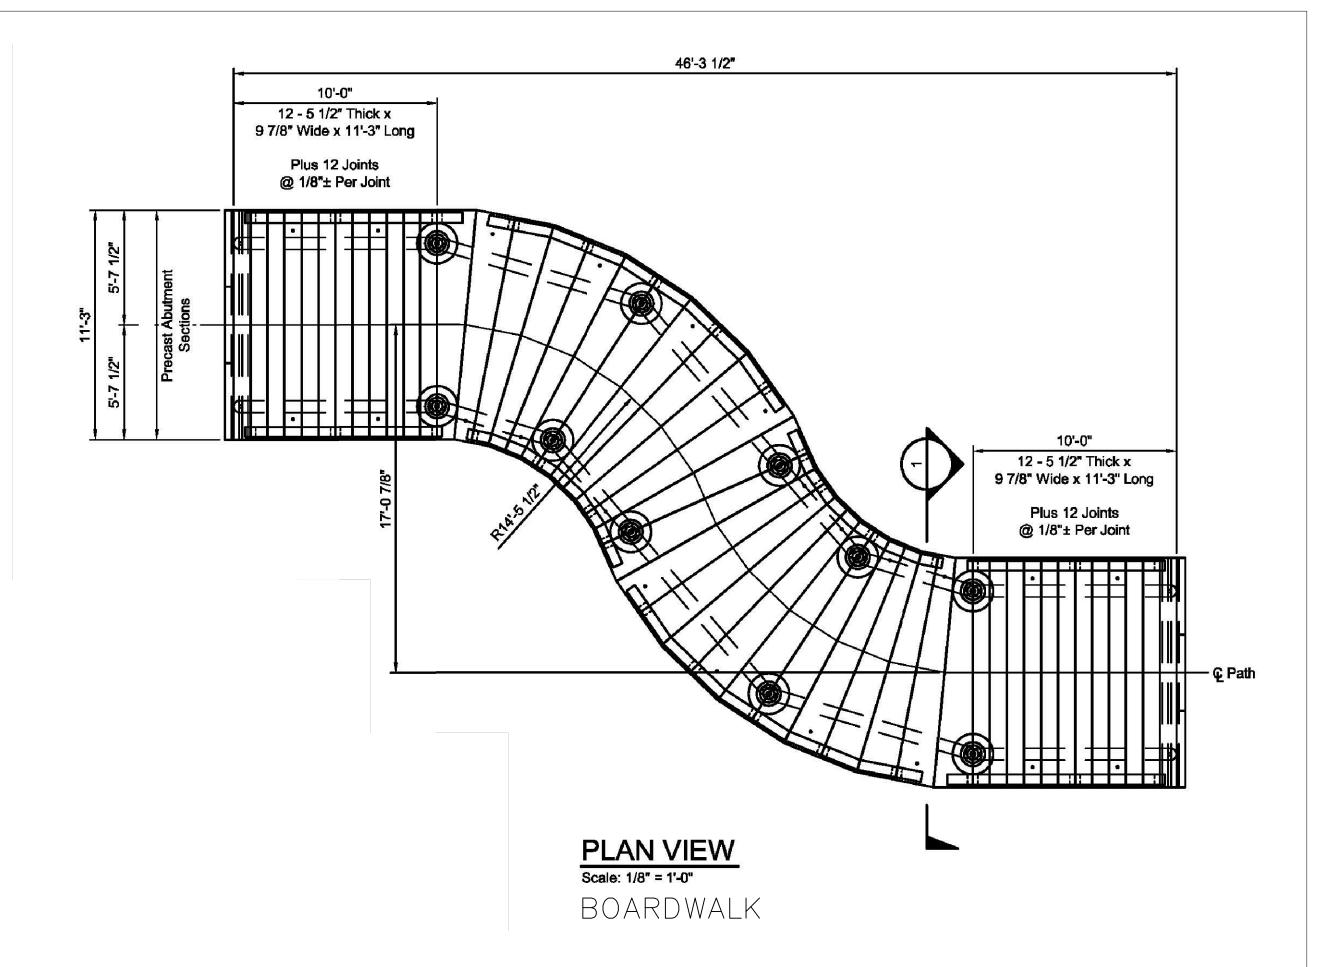









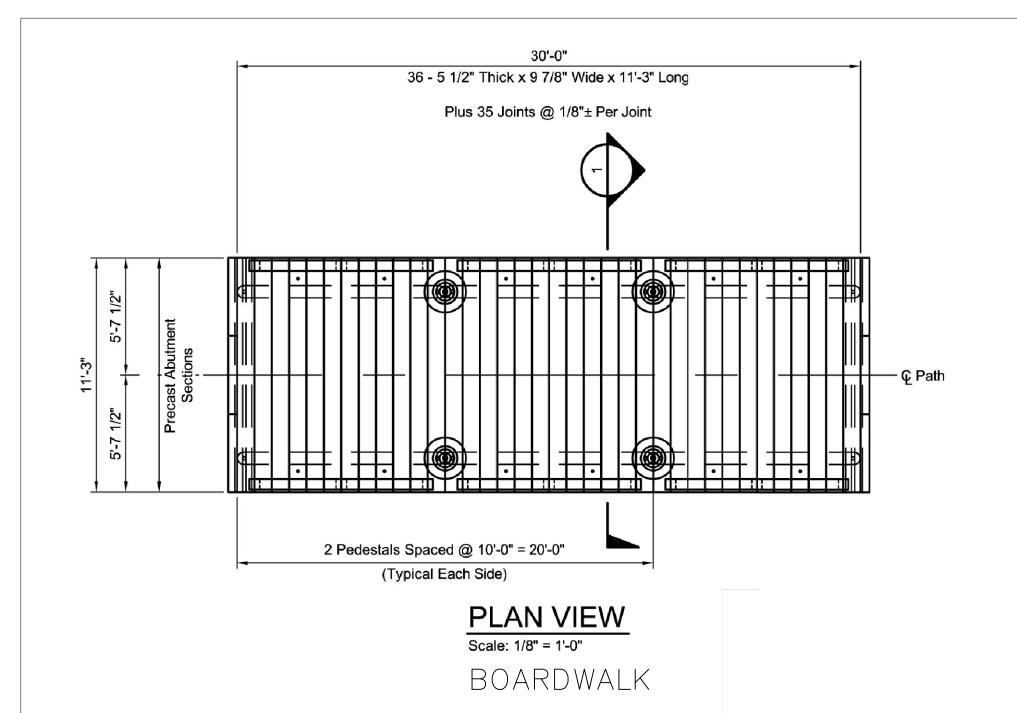

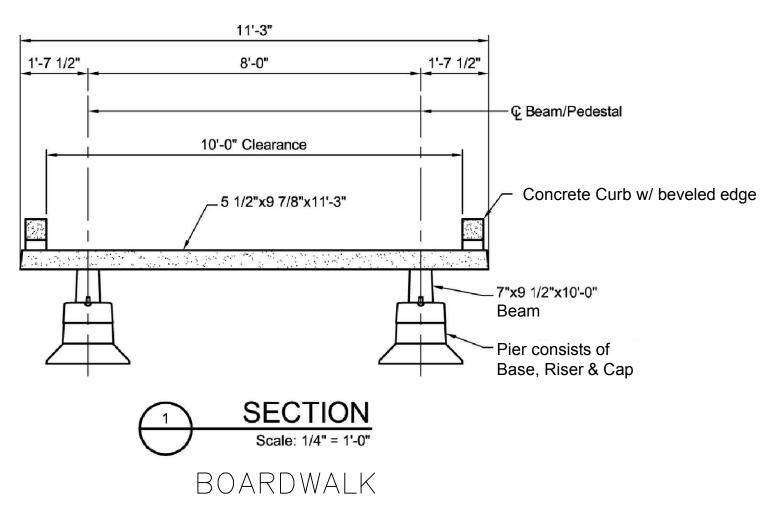


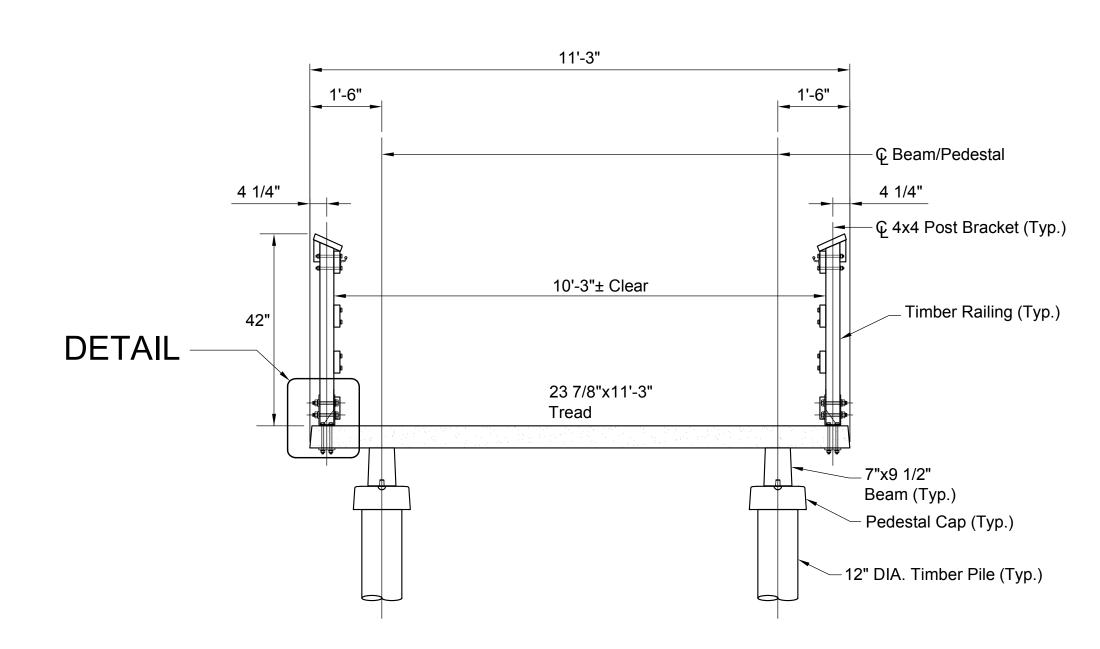


BOARDWALK WITH RAIL SECTION

(REFER TO DETAIL 2/23 FOR LOCATION)

PHONE: 219.513.2500 9200 CALUMET AVENUE SUITE N501 MUNSTER, IN 46321

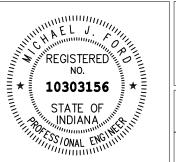

					HORIZONTAL SCALE	BRIDGE FILE	
RECOMMENDED	4			INDIANA DEPARTMENT	N/A		
FOR APPROVAL	Muchael Ford	05/22/2012		OF TRANSPORTATION	VERTICAL SCALE	DESIGNATION	
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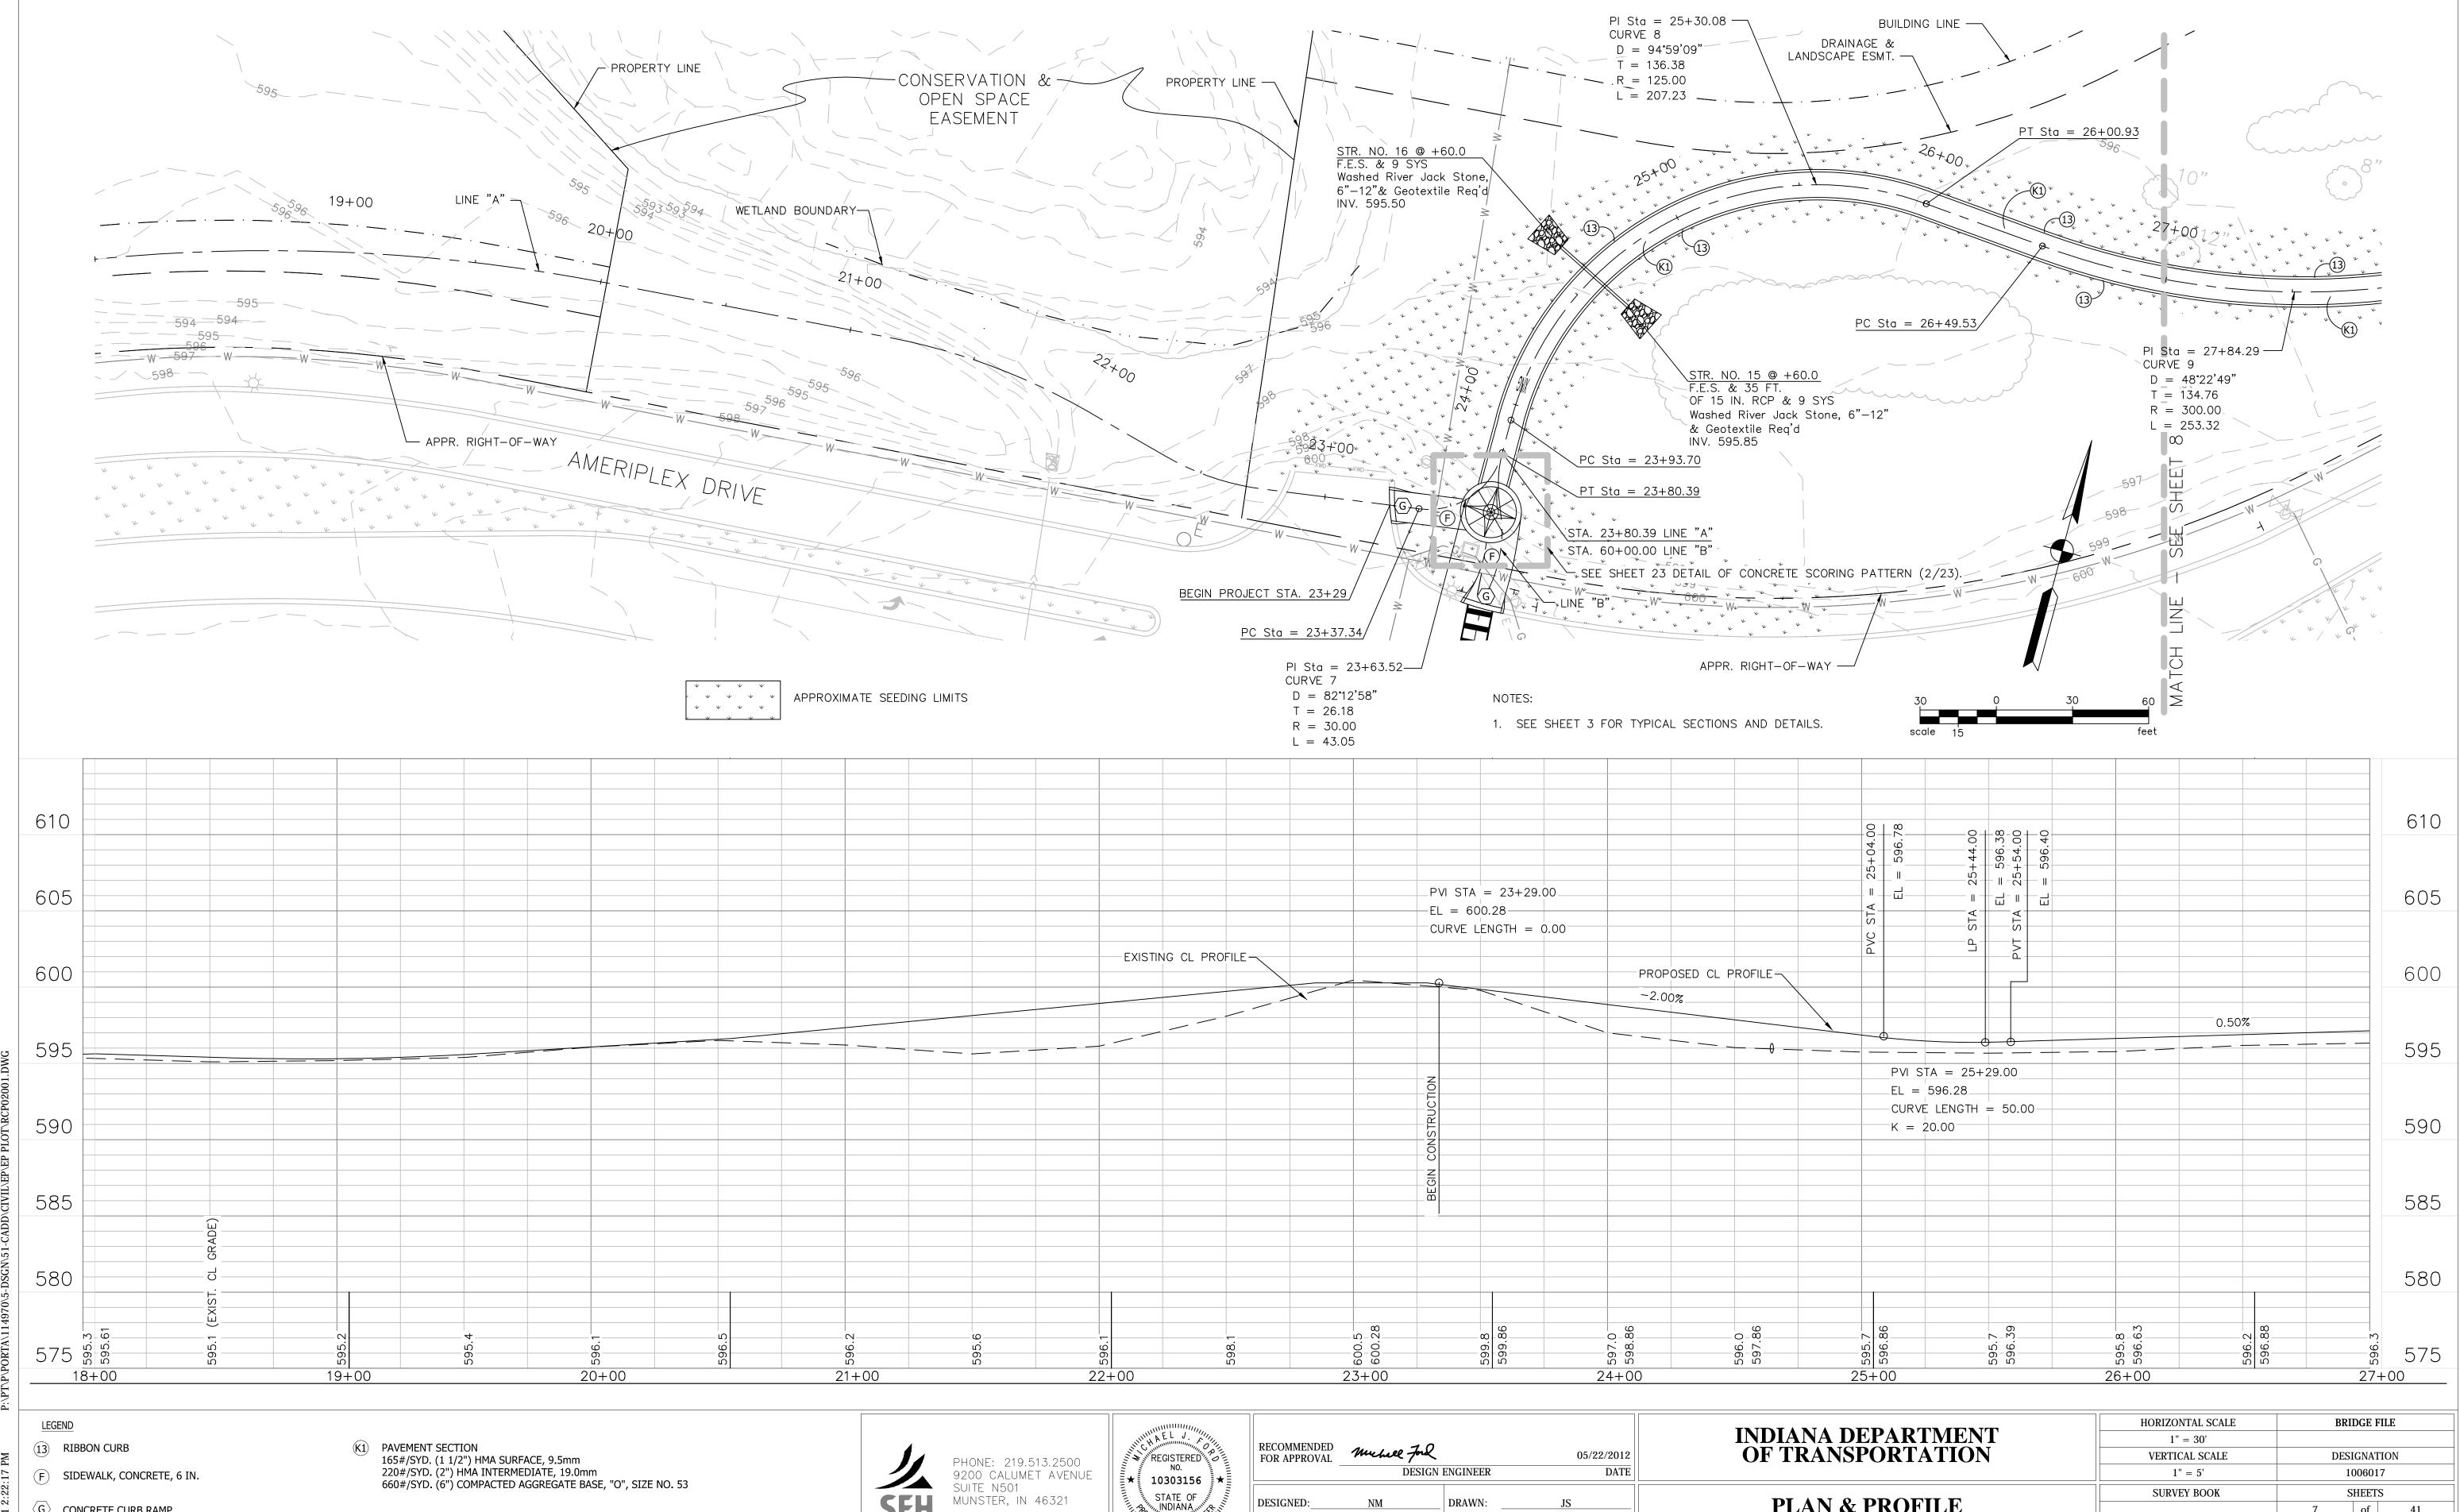


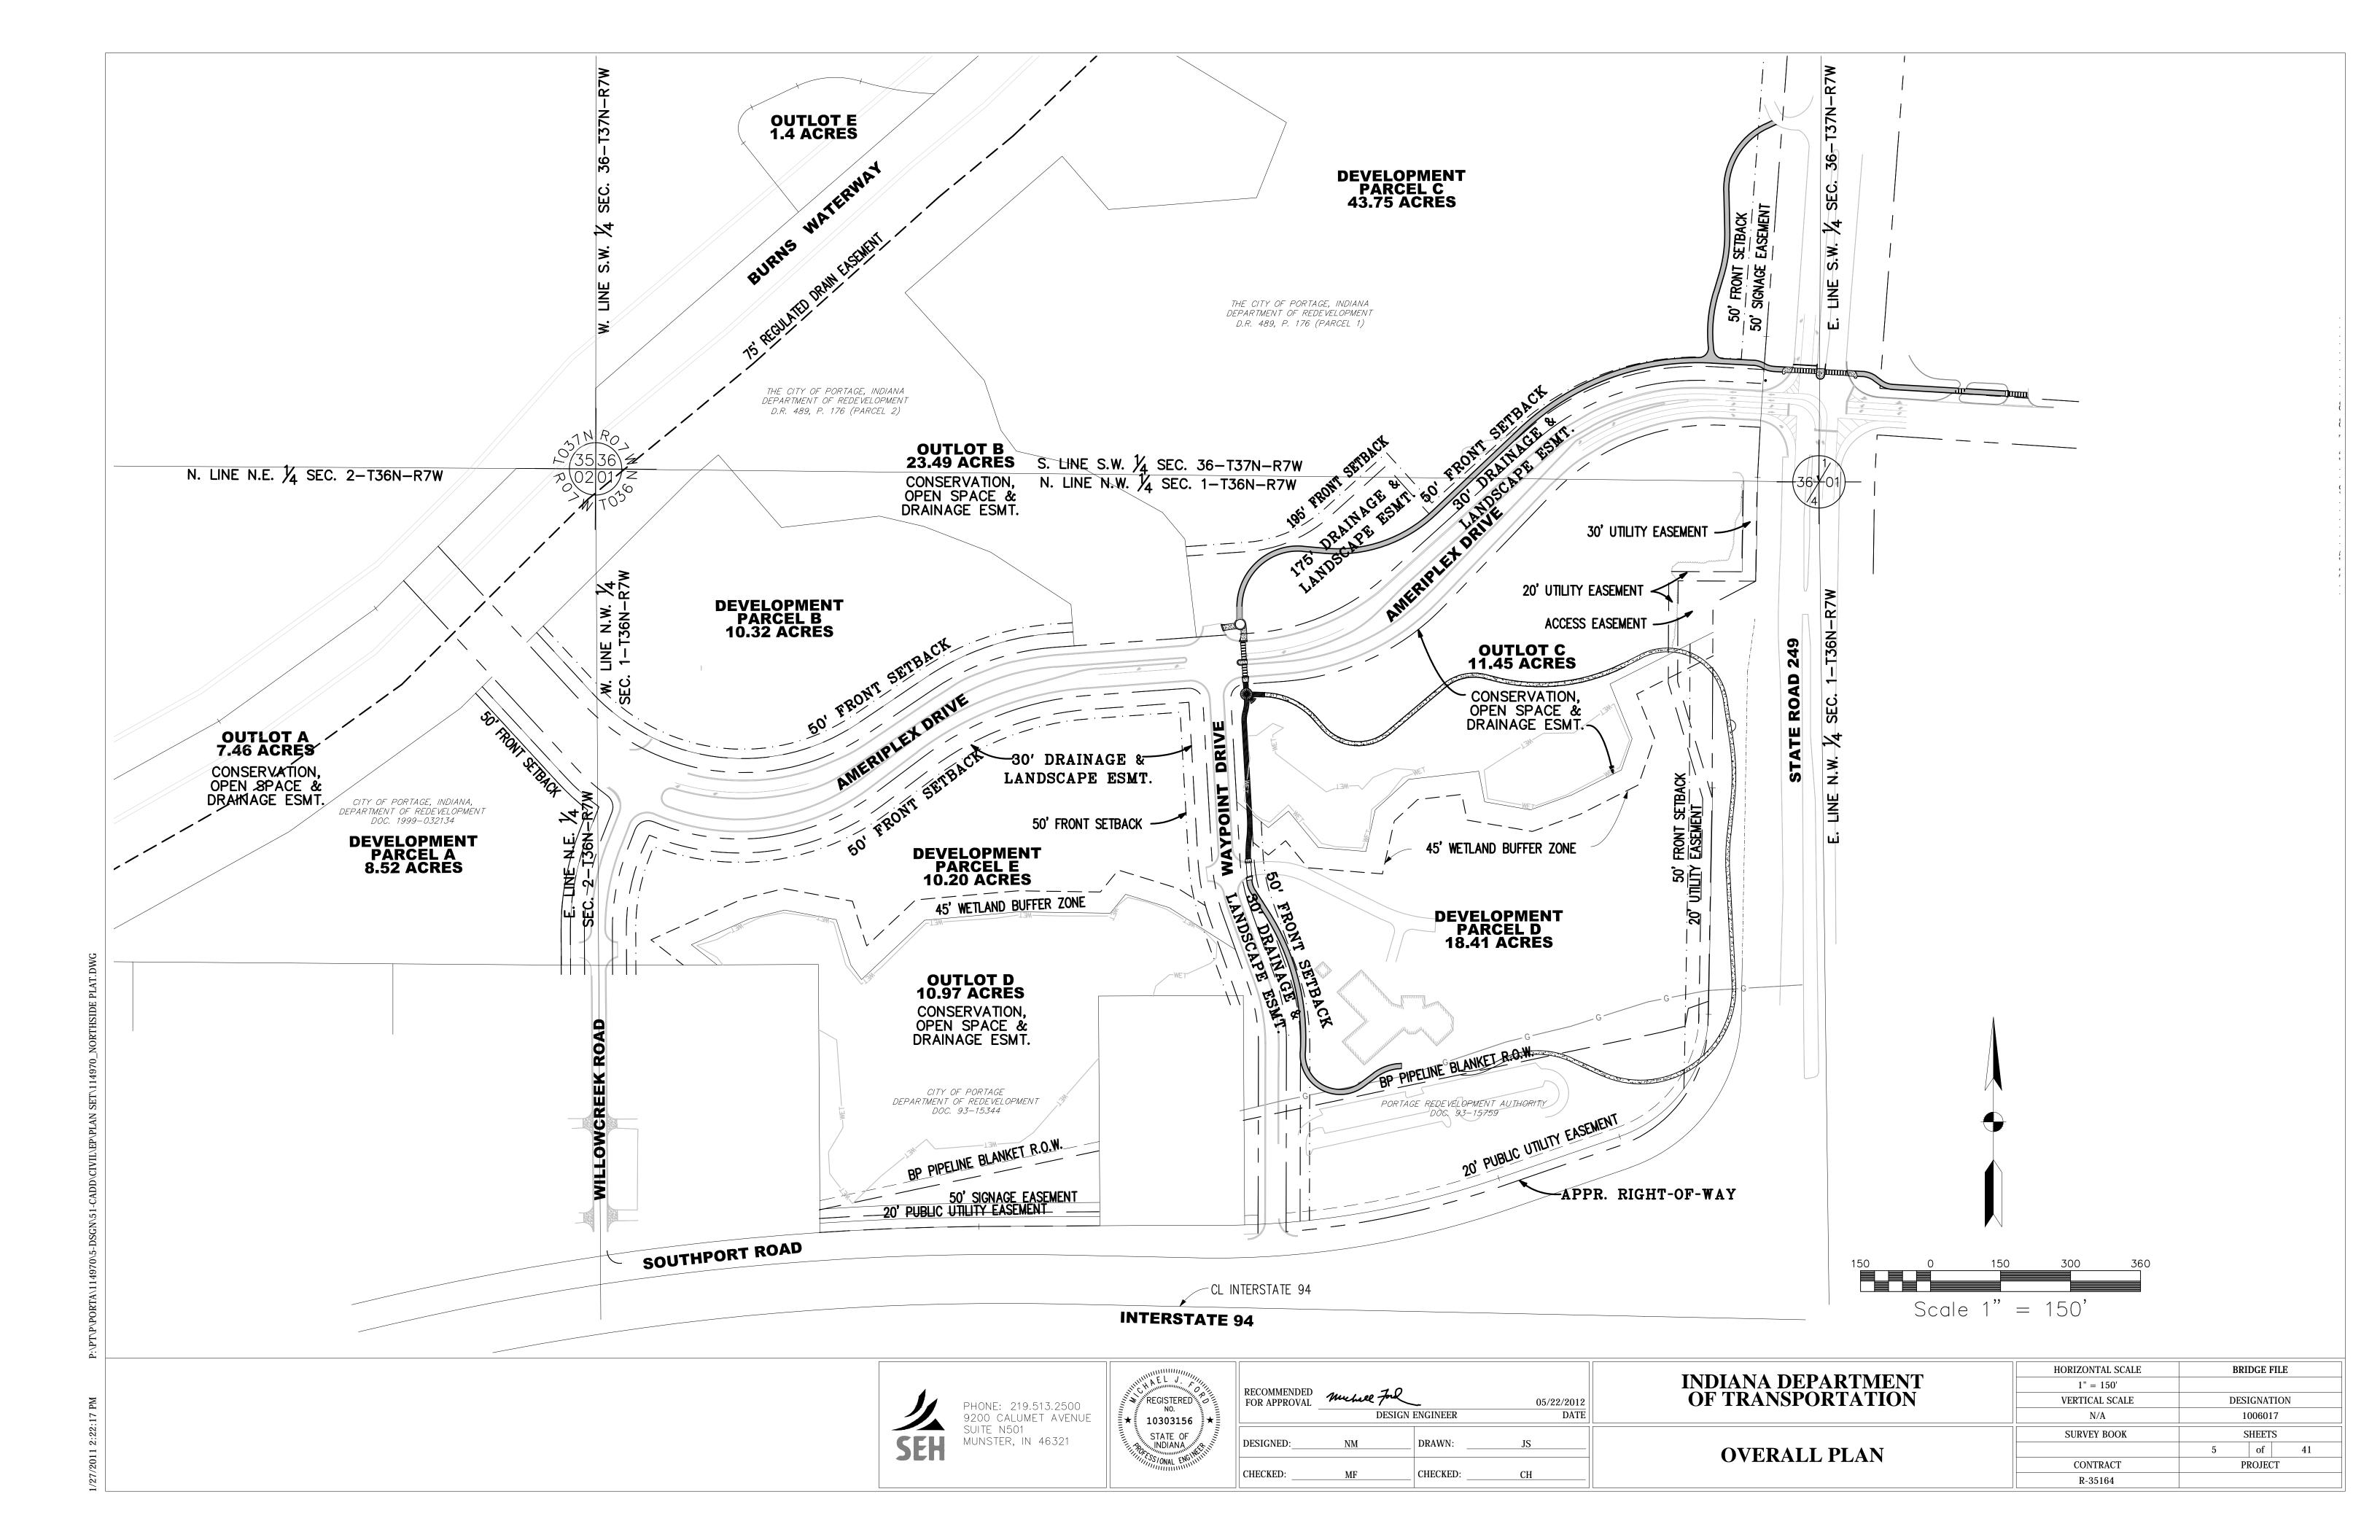



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	HORIZONTAL SCALE	BRIDGE FILE			
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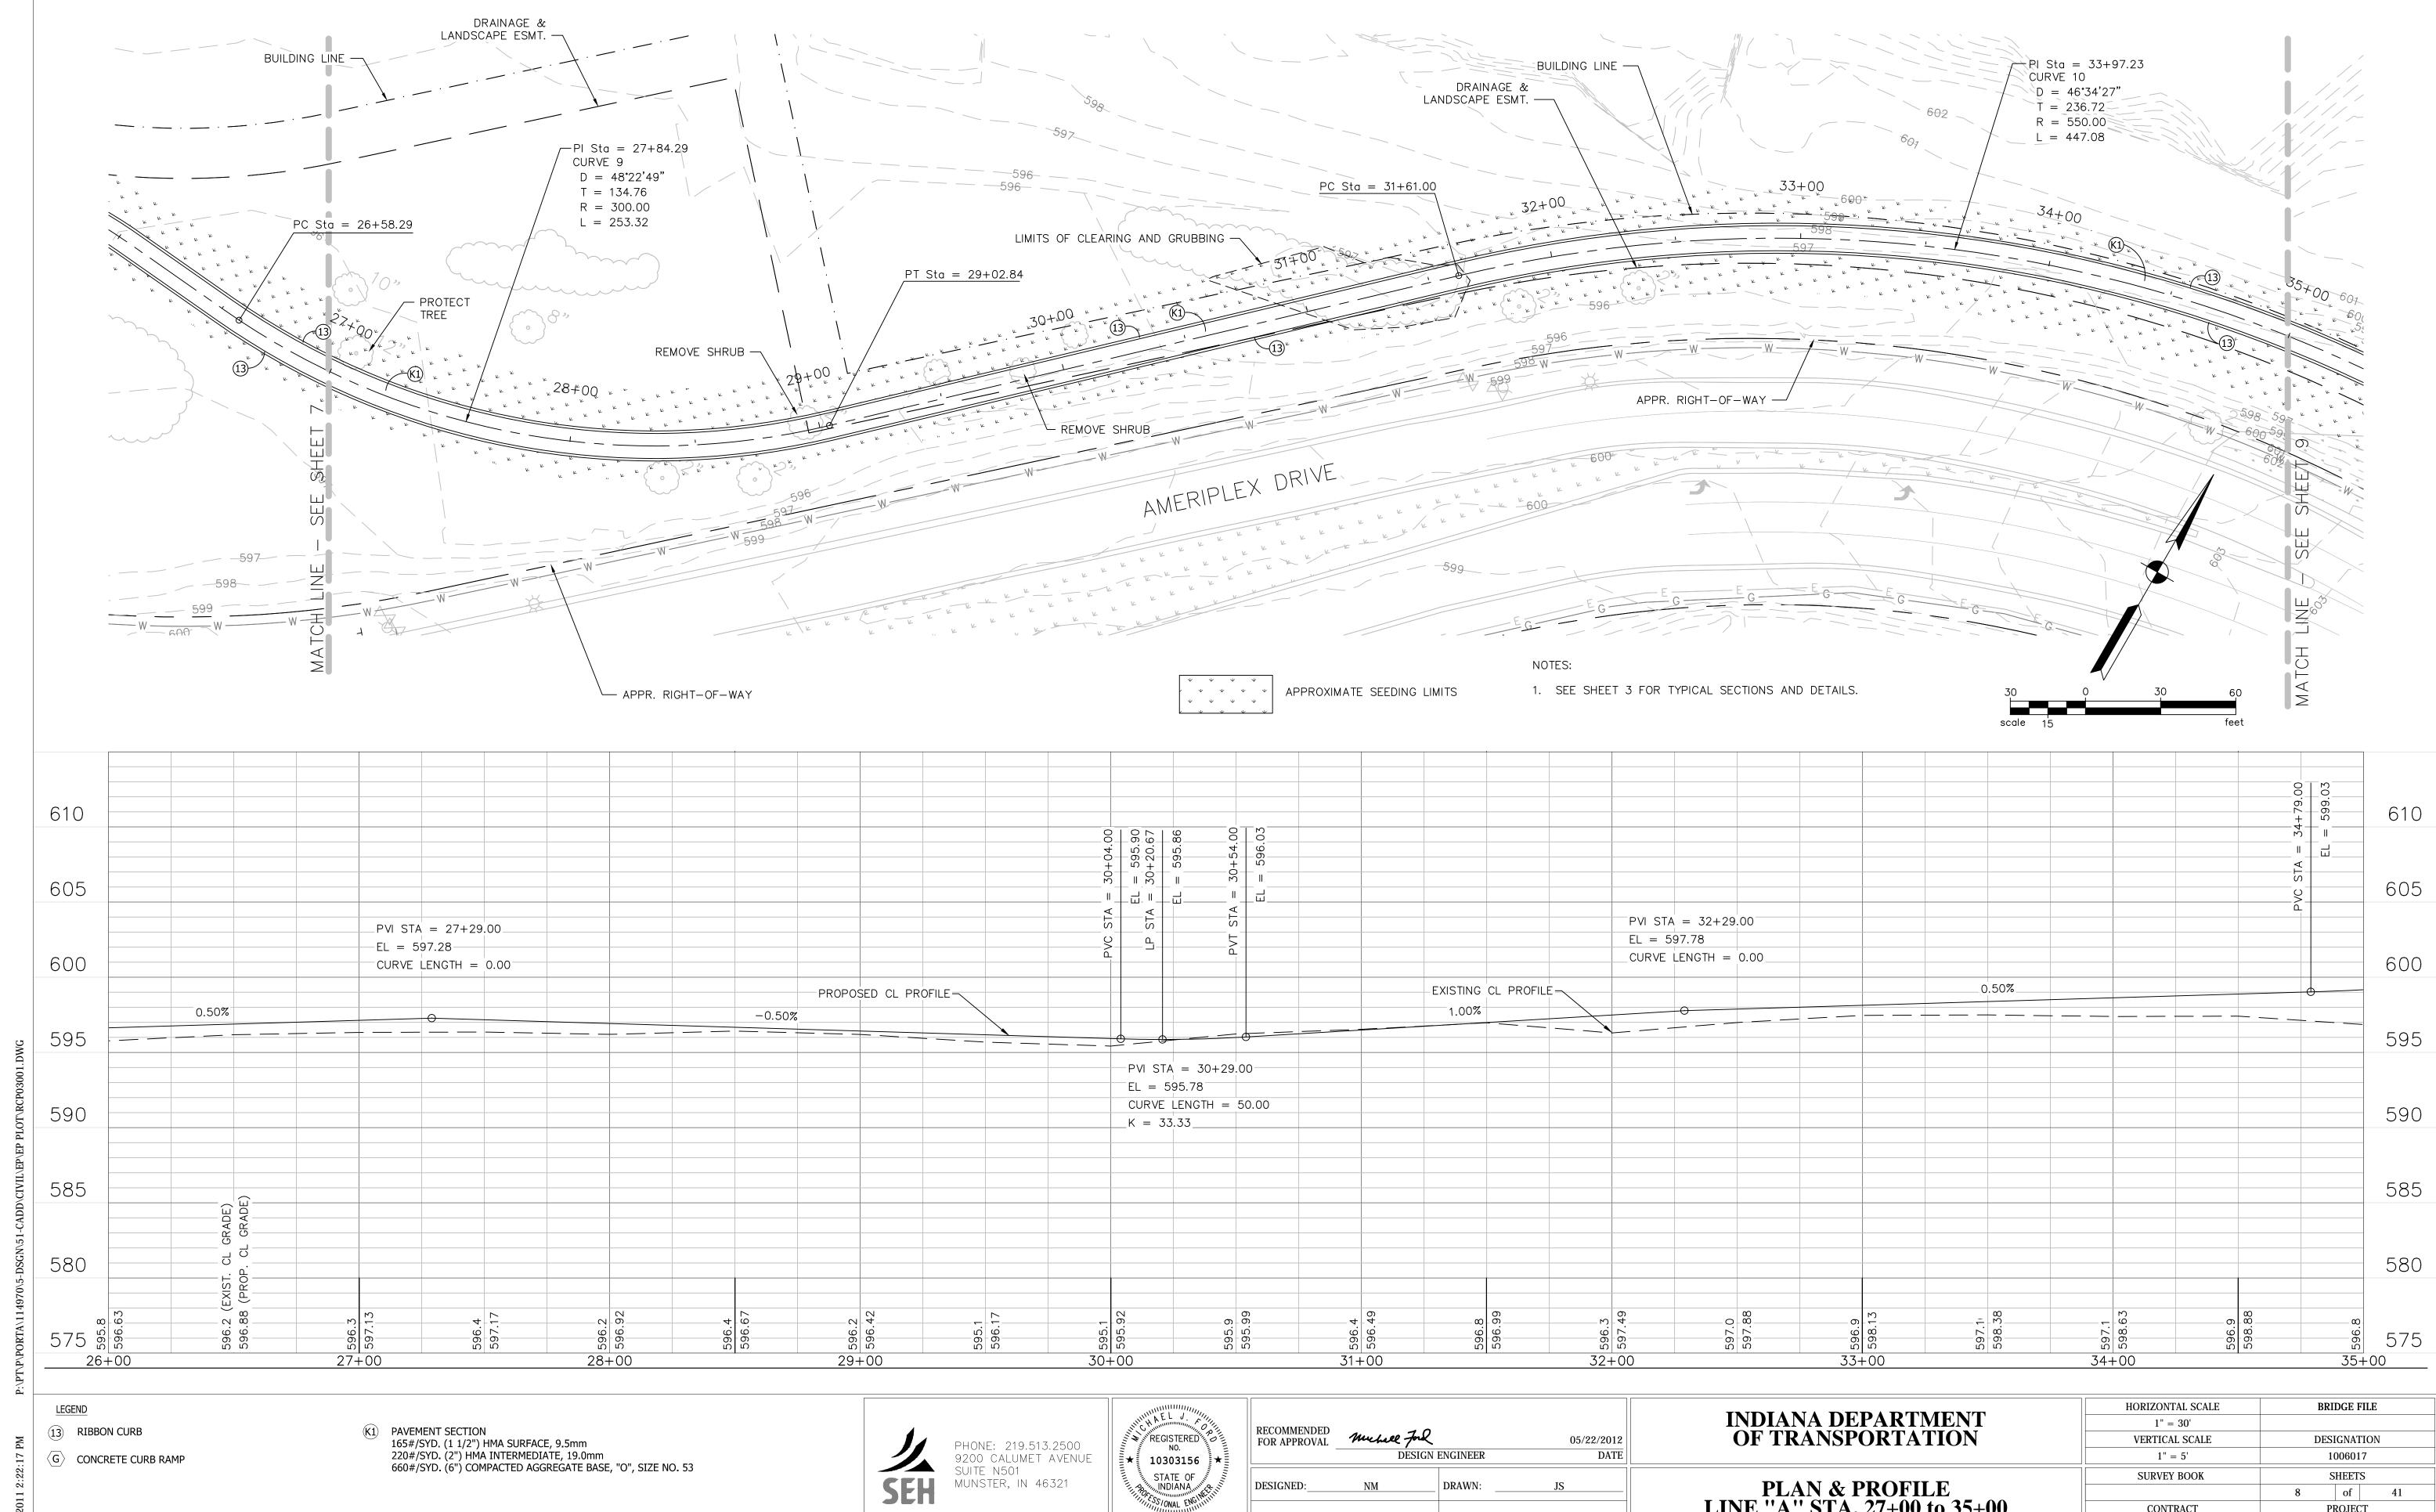
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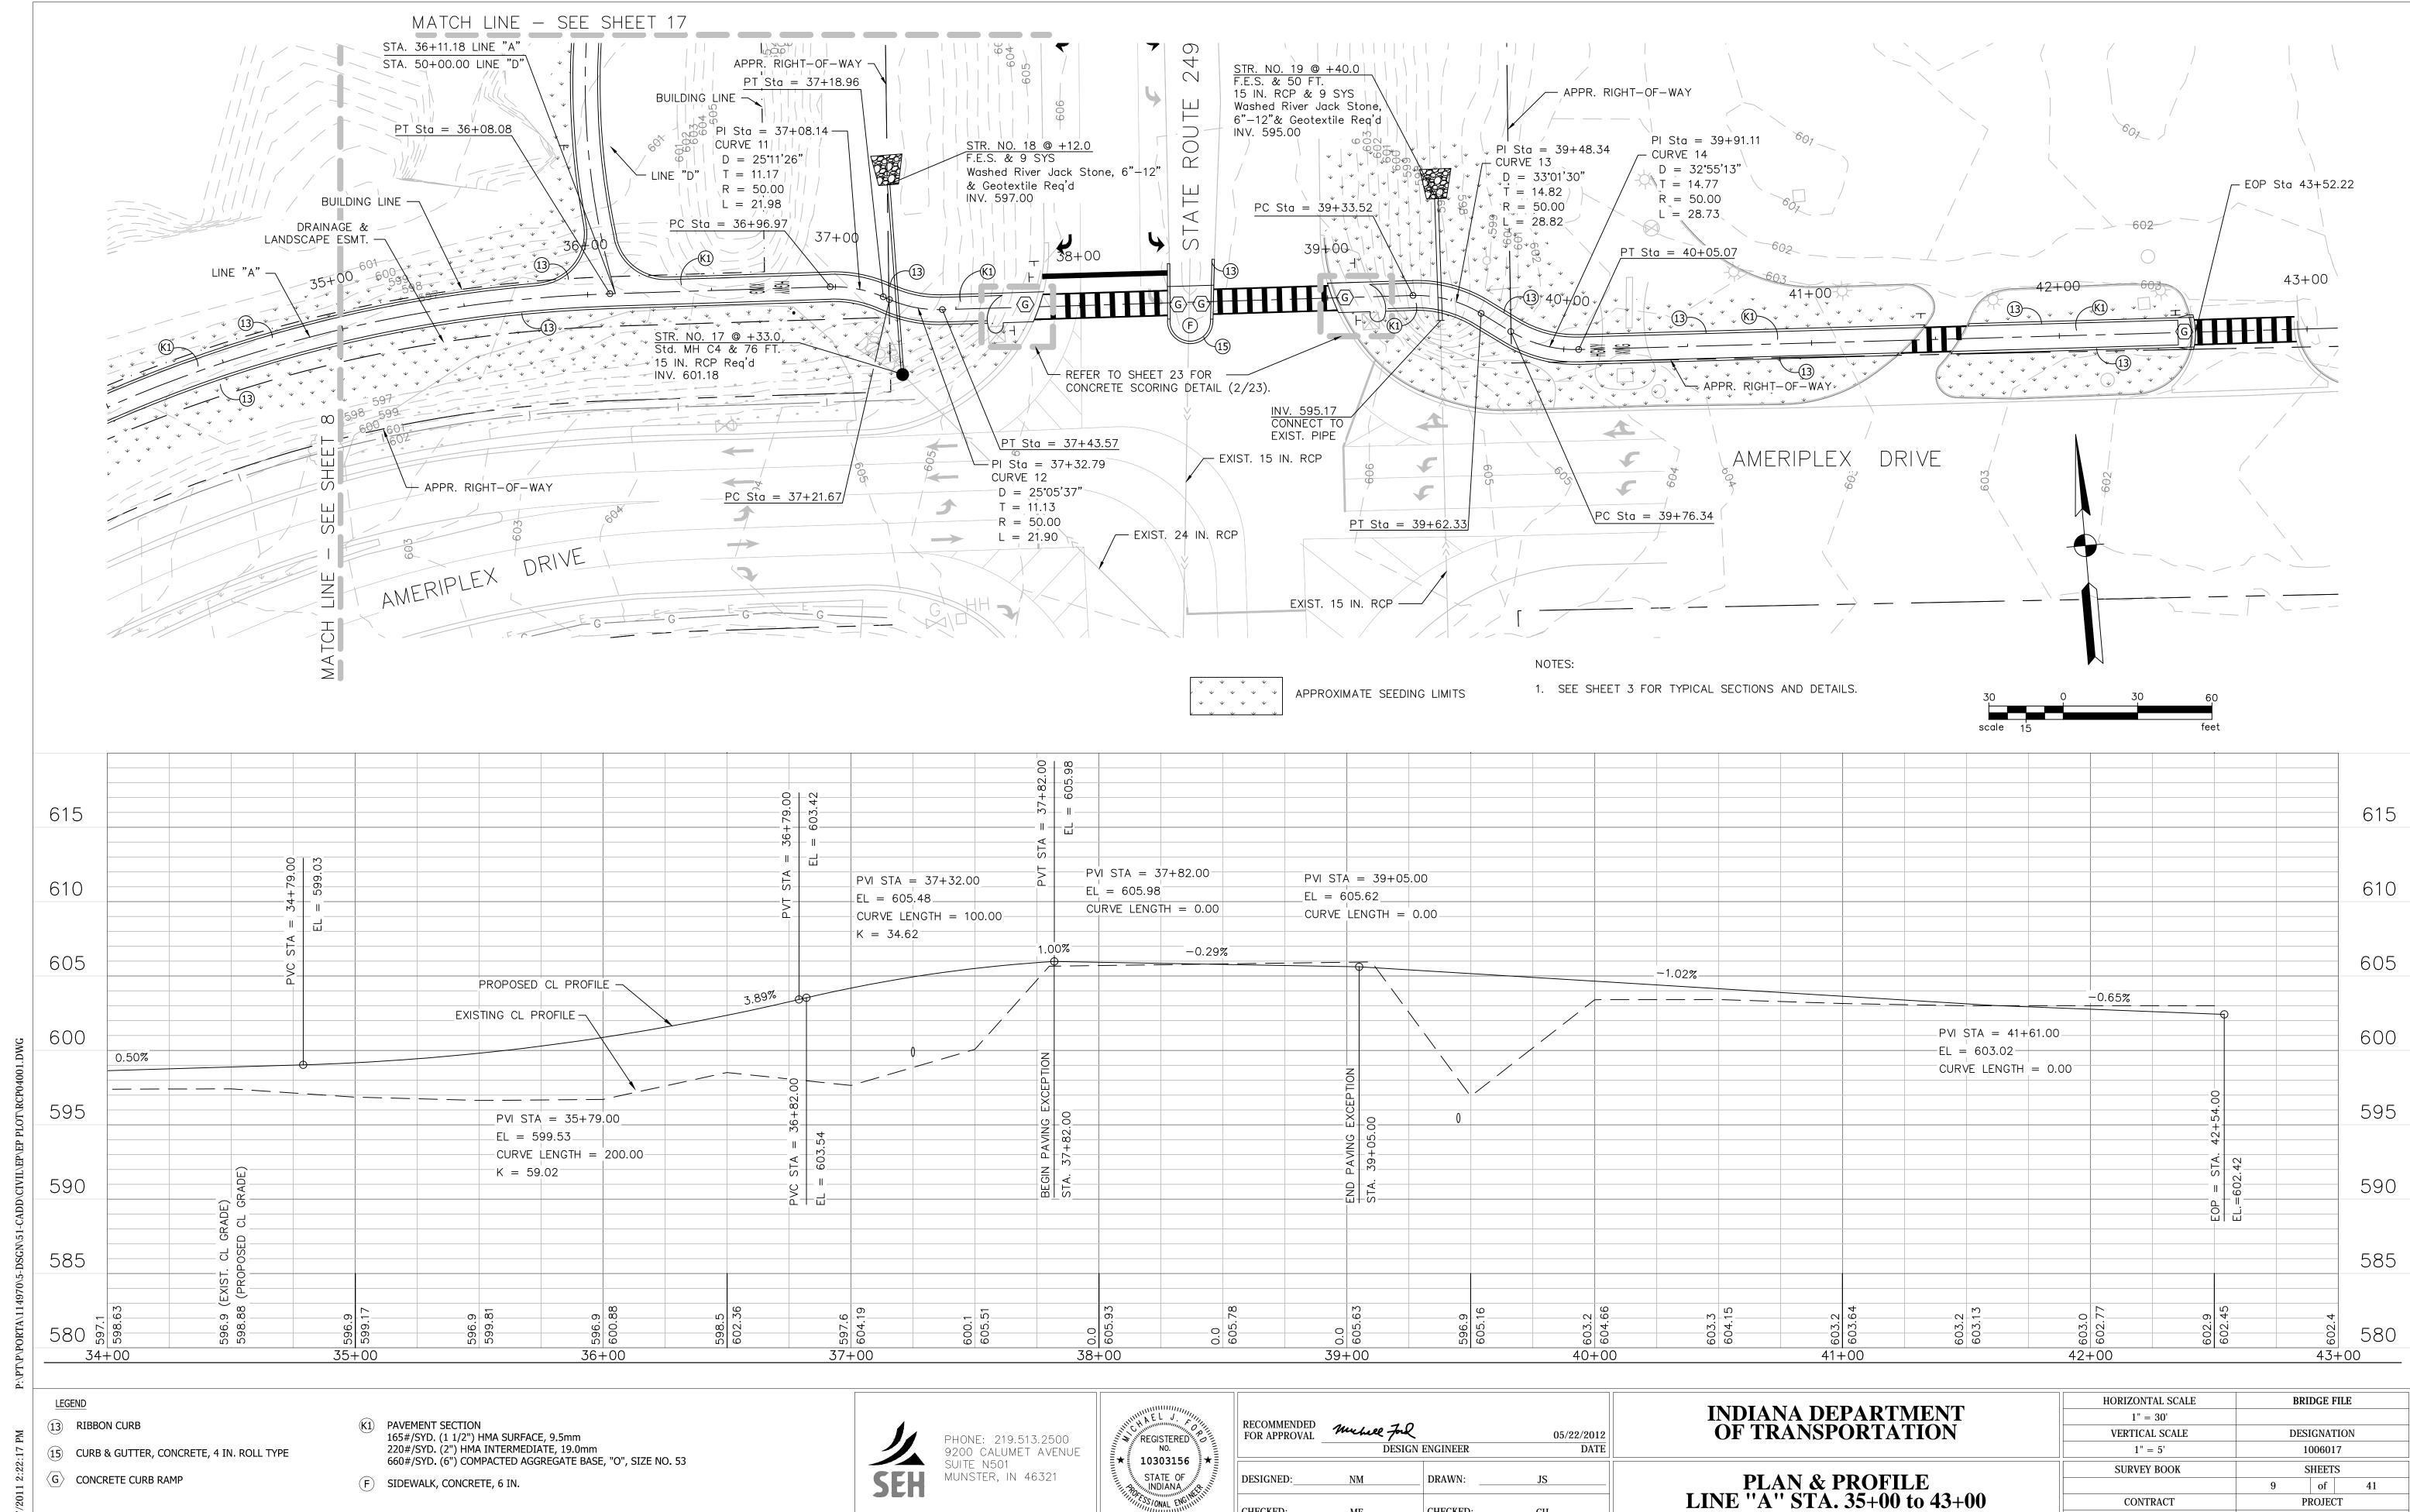
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PLAN & PROFILE LINE "A" STA. 27+00 to 35+00

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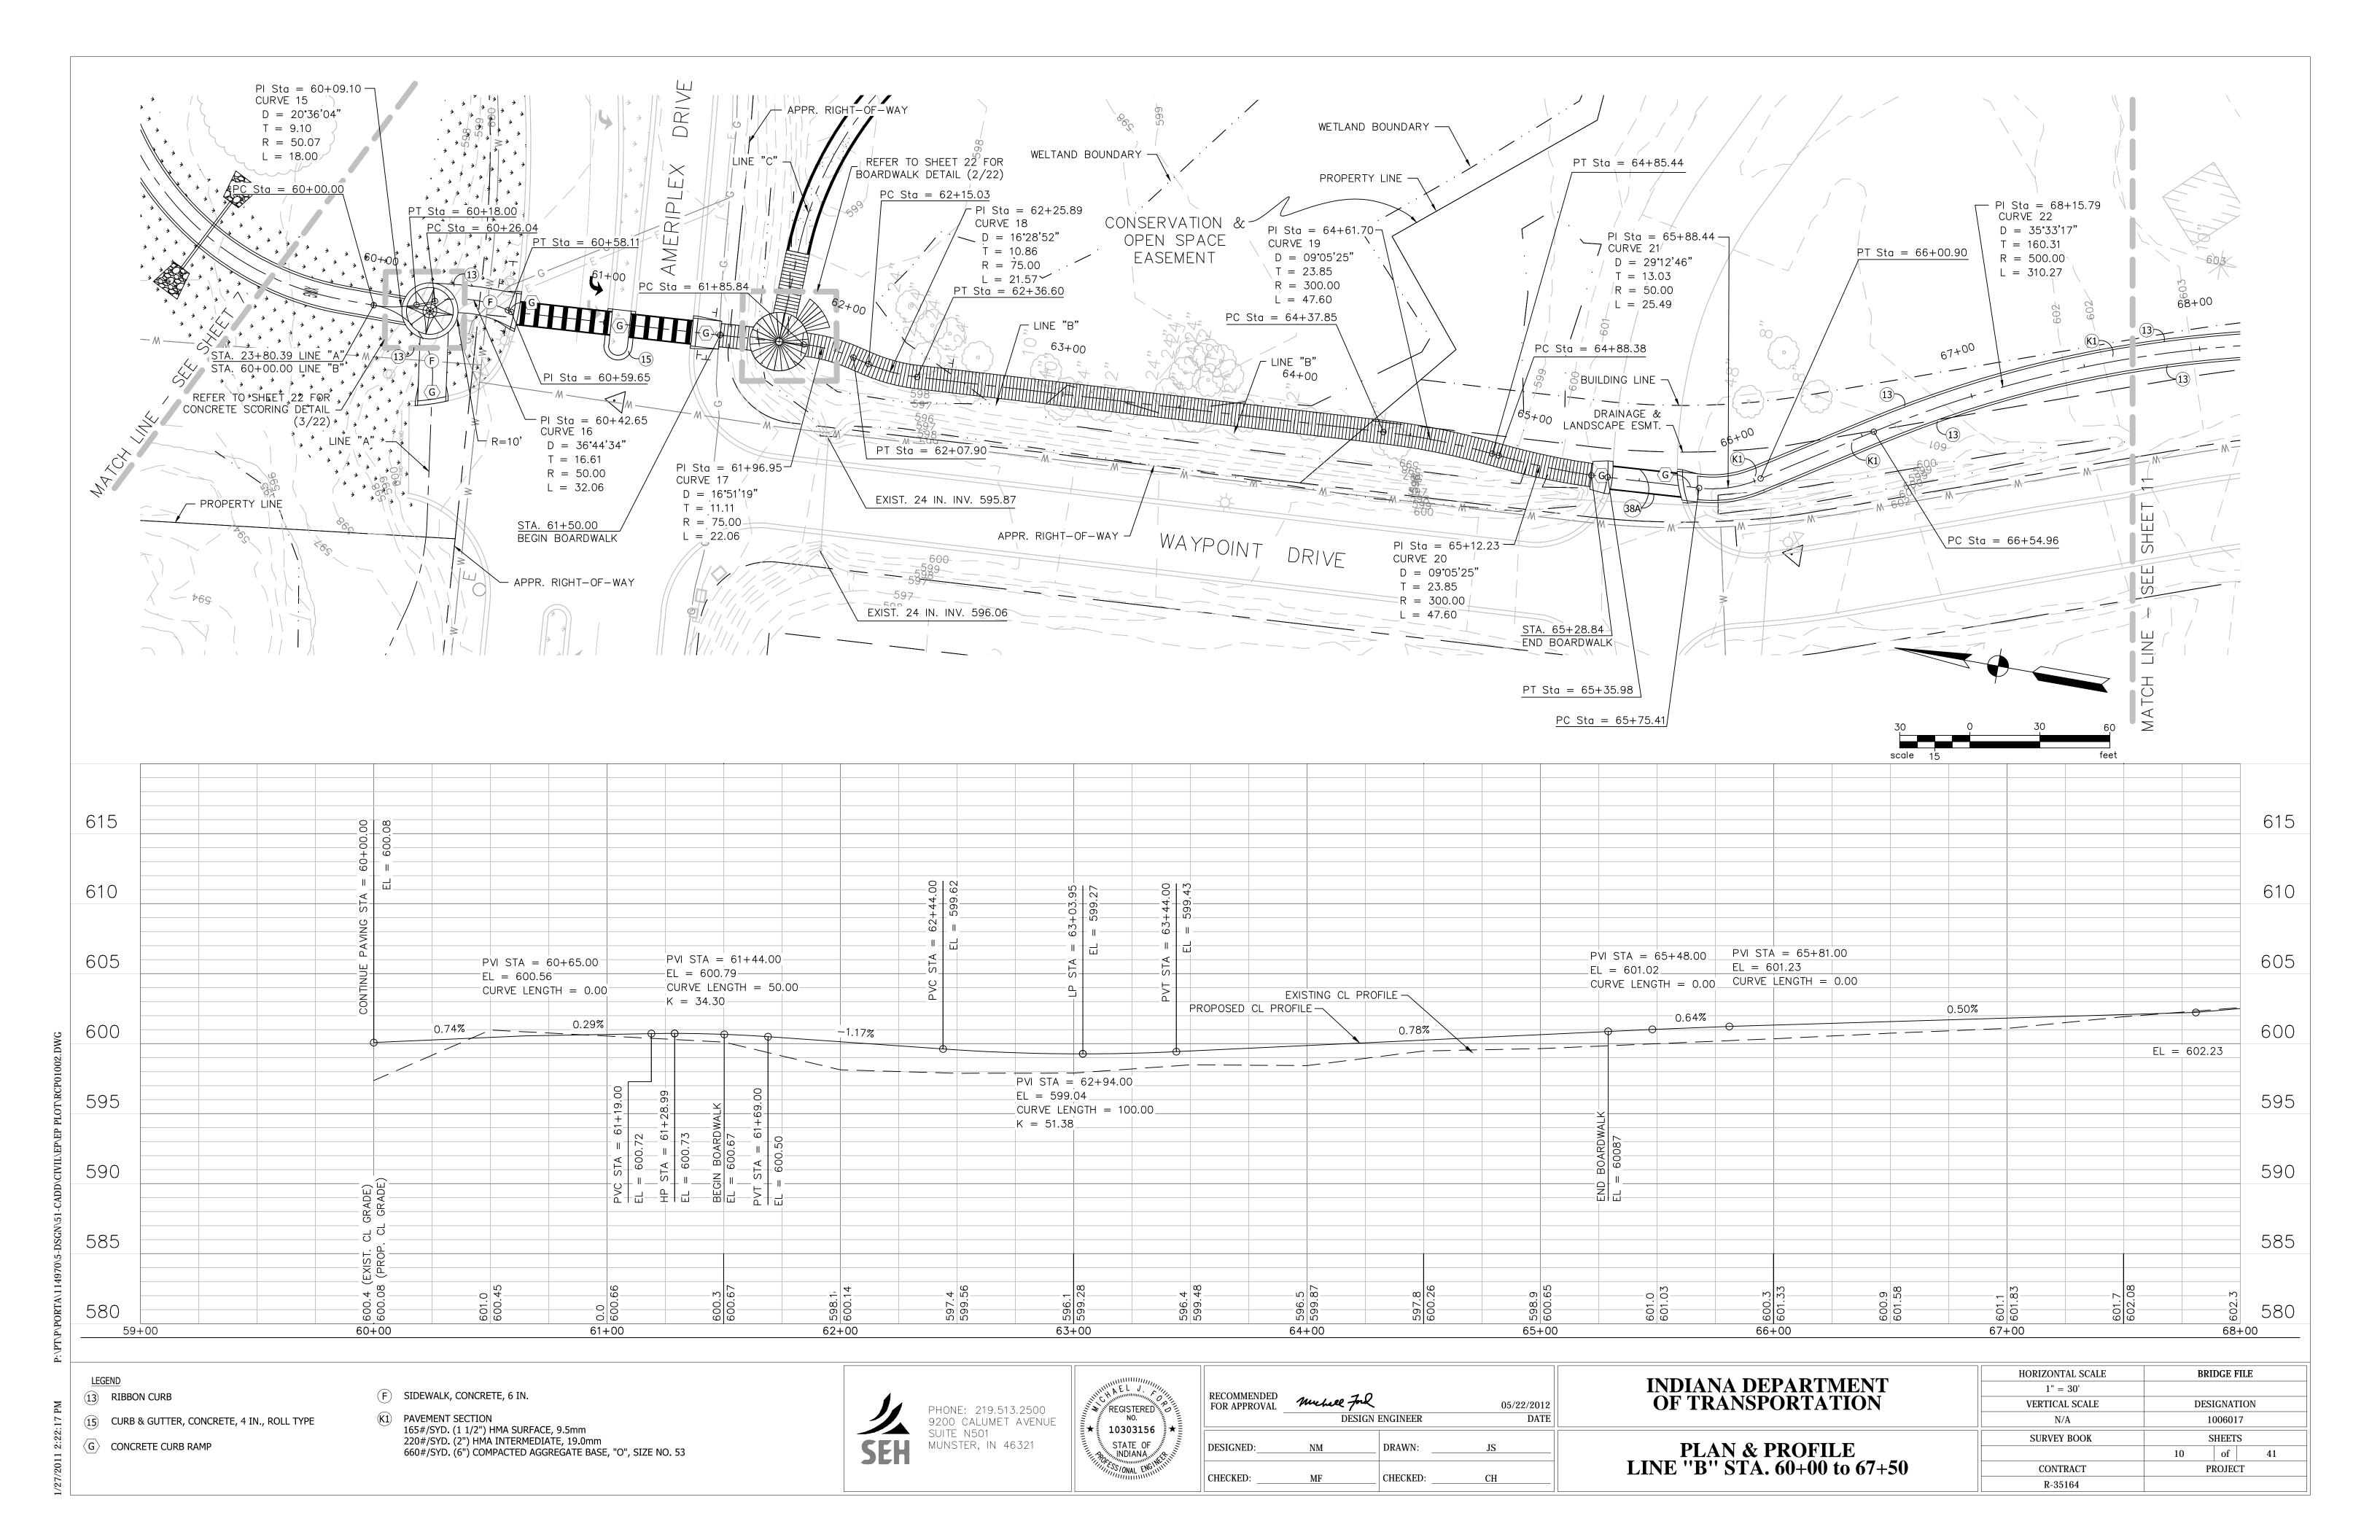



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PLAN & PROFILE LINE "B" STA. 67+50 to 73+00


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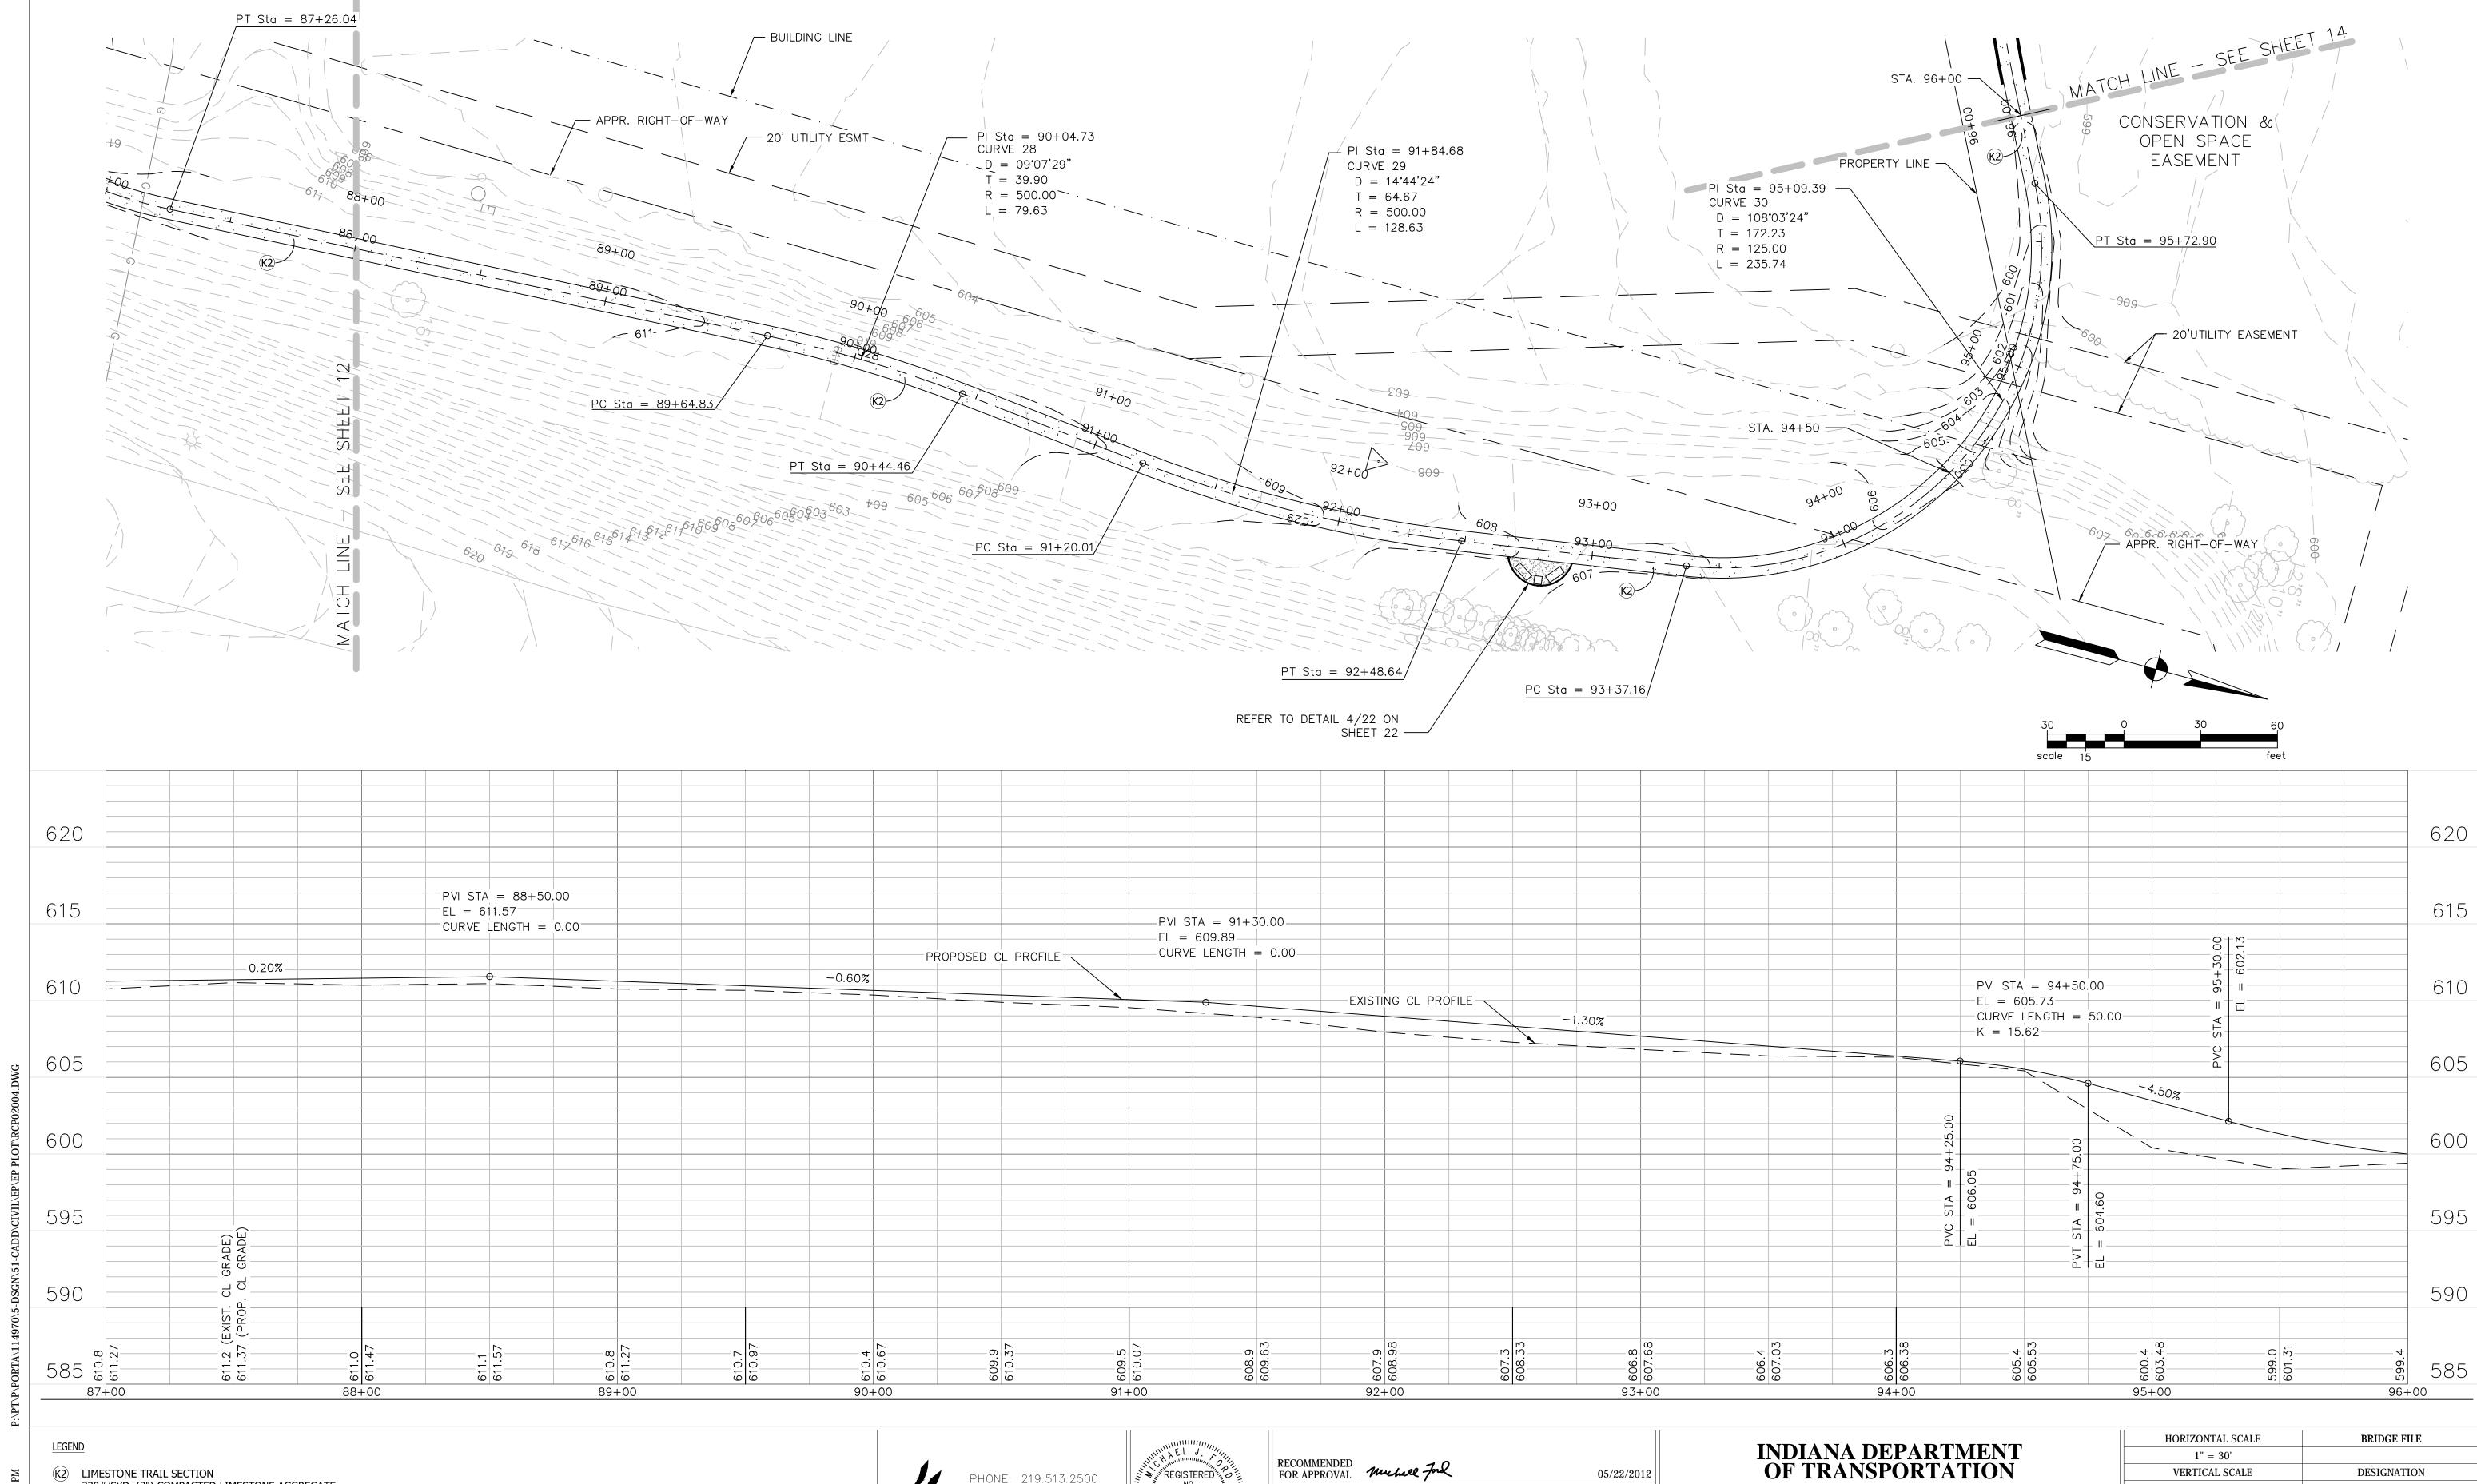
PLAN & PROFILE LINE "C" STA. 80+00 to 88+00

SHEETS

of

PROJECT
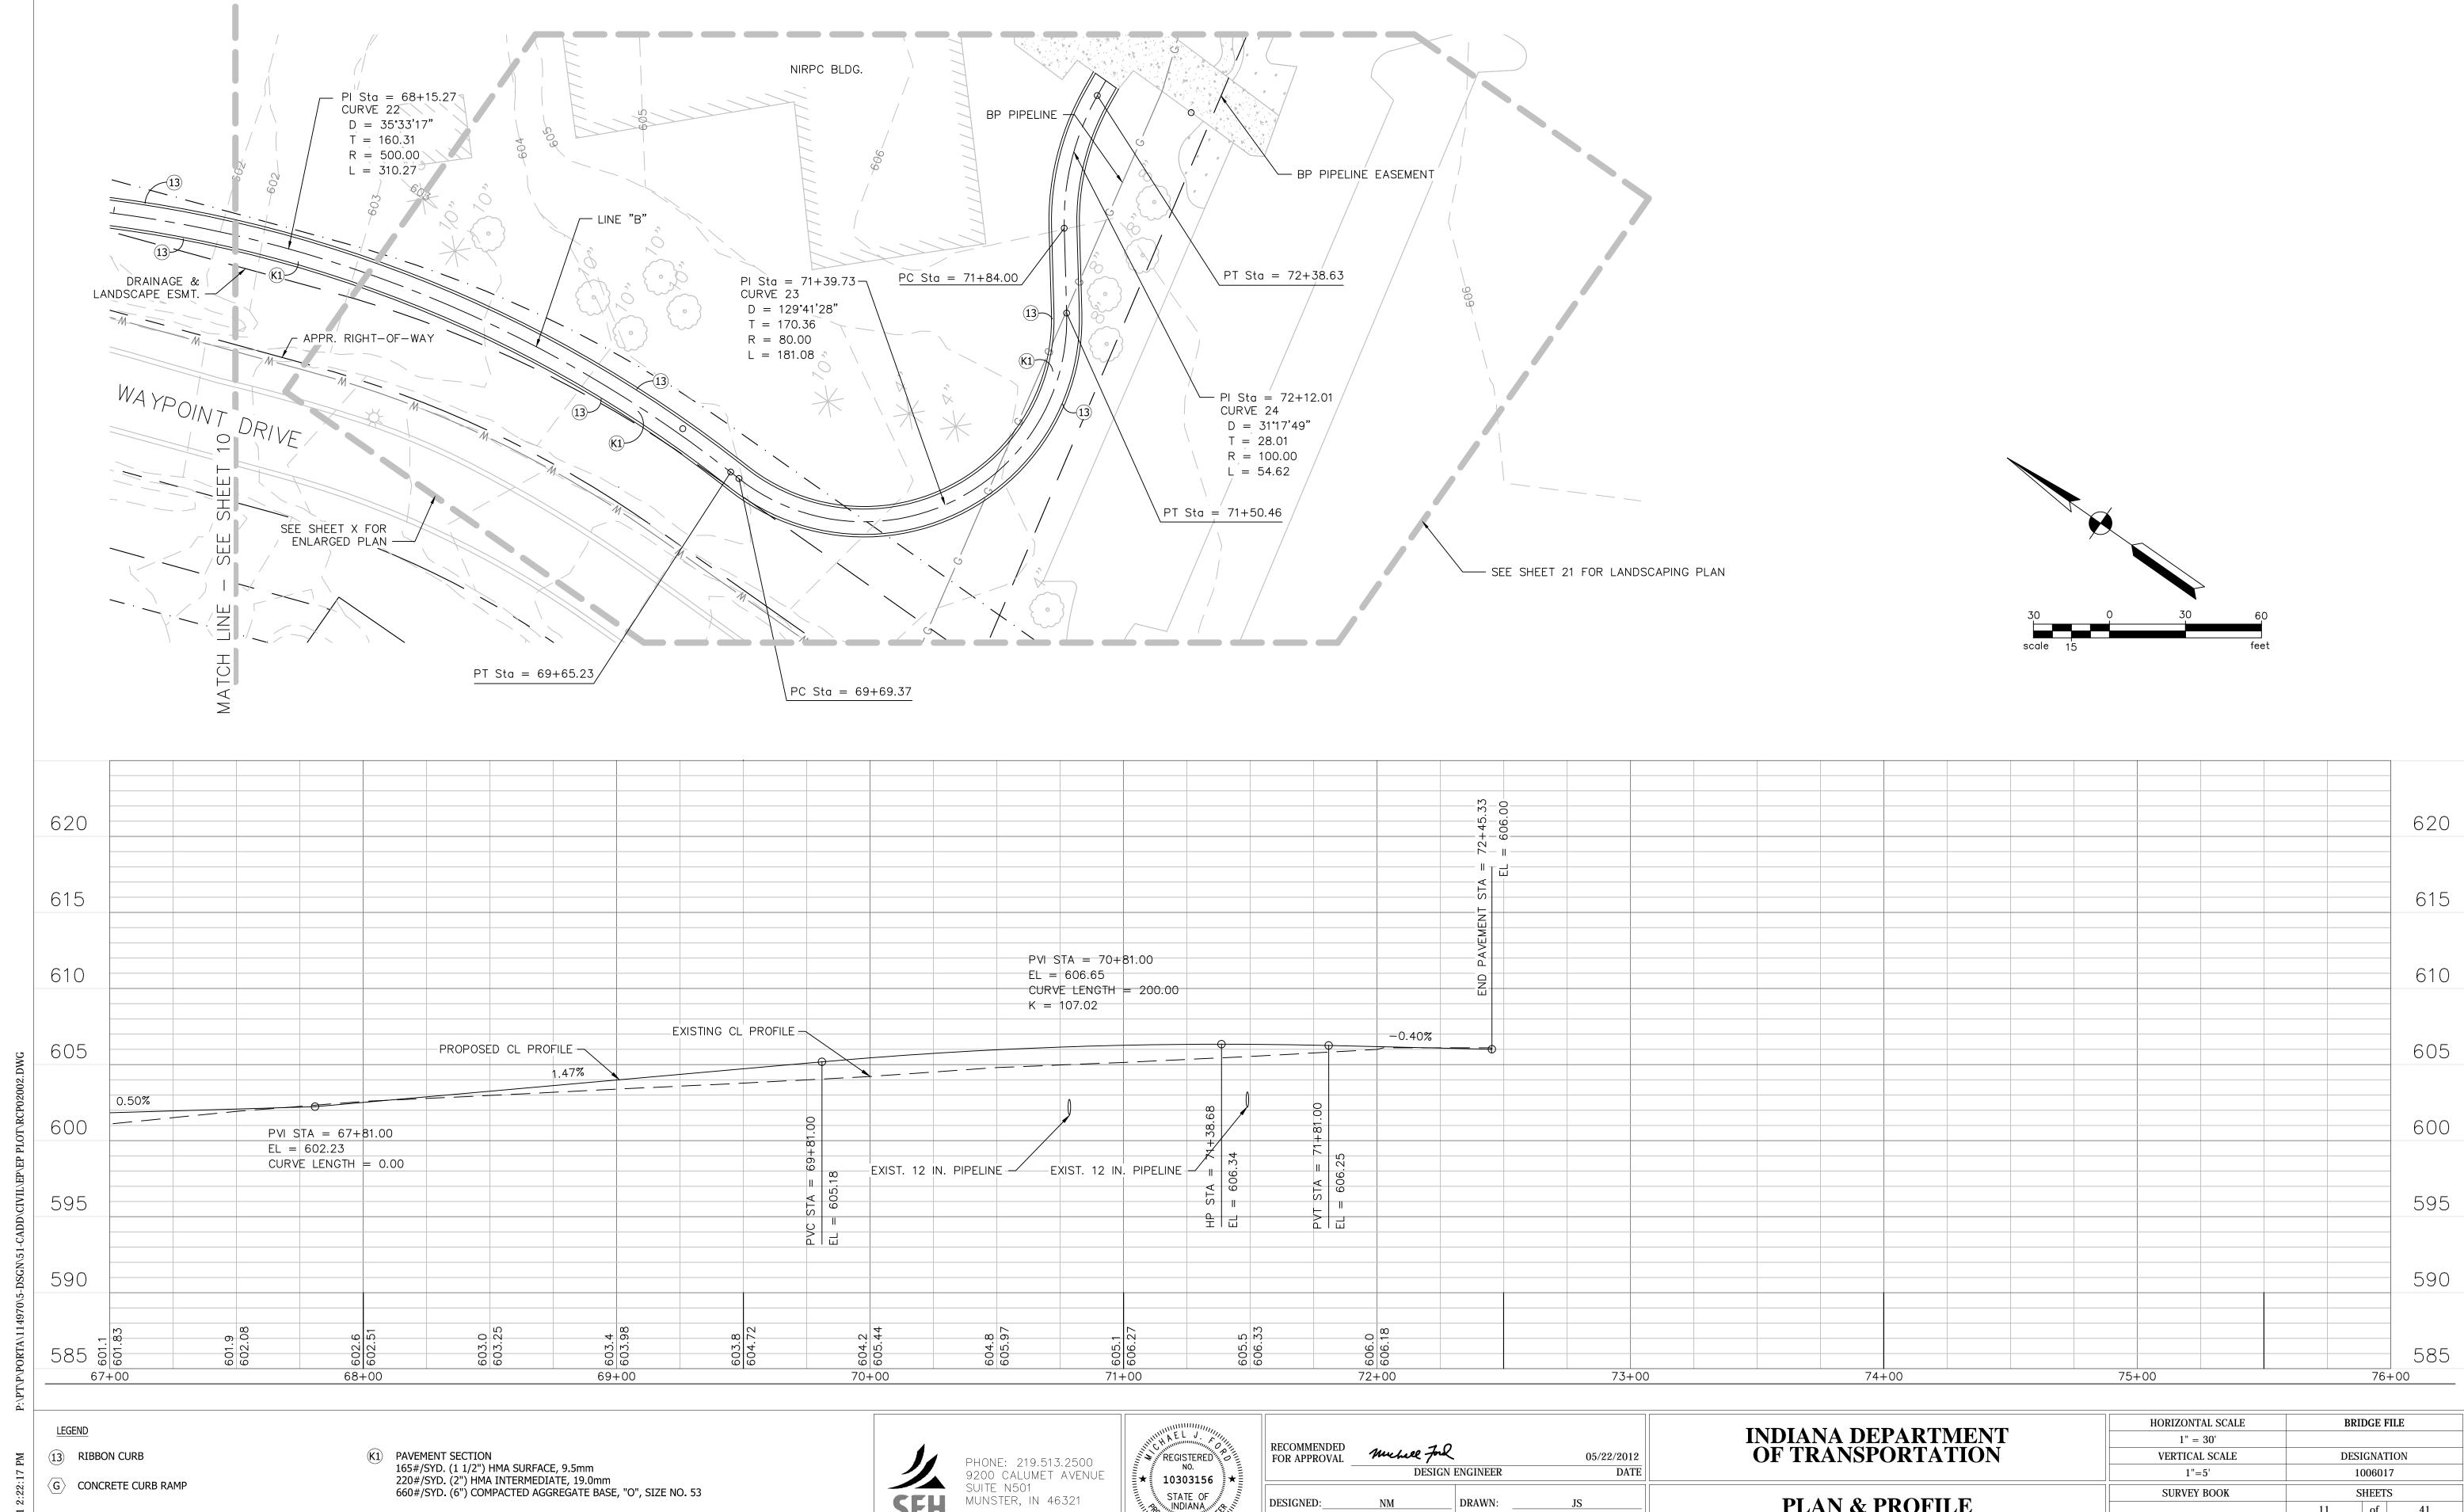
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LIMESTONE TRAIL SECTION
330#/SYD. (3") COMPACTED LIMESTONE AGGREGATE
660#/SYD. (6") COMPACTED AGGREGATE BASE, "O", SIZE NO. 53

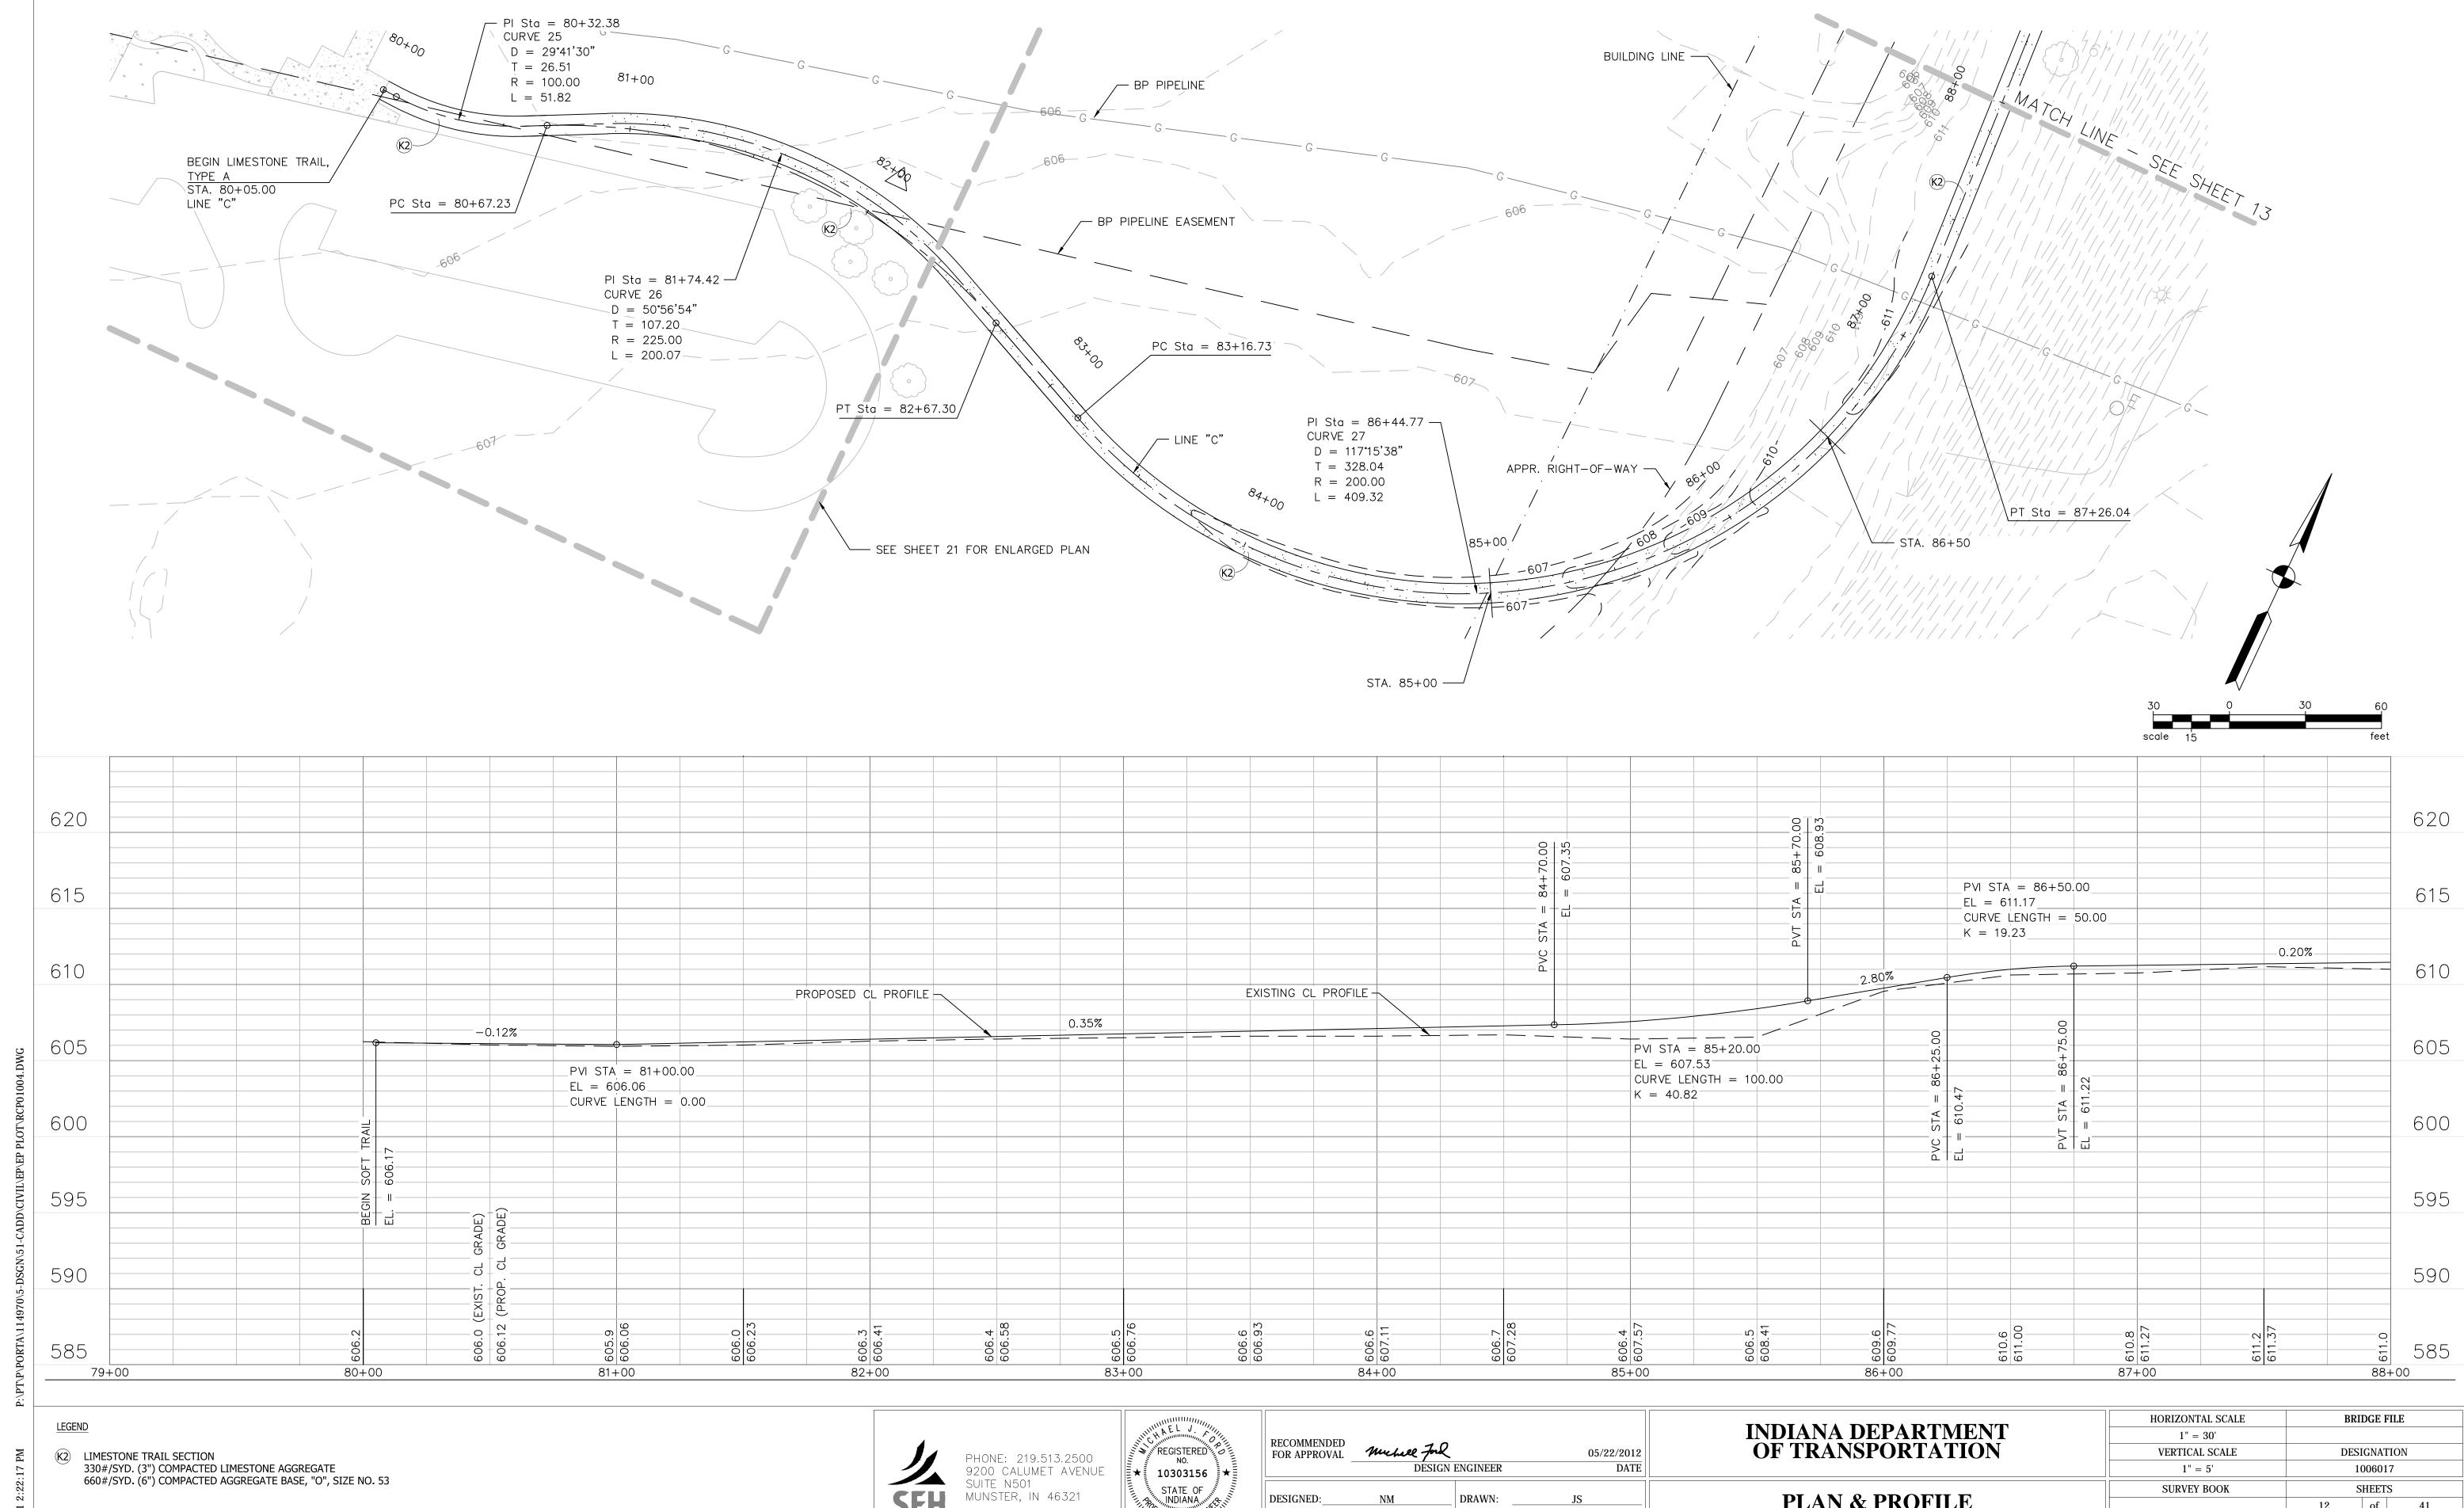PHONE: 219.513.2500
9200 CALUMET AVENUE
SUITE N501
MUNSTER, IN 46321


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INDIANA DEPARTMENT	1" = 30'				
OF TRANSPORTATION	VERTICAL SCALE	DESIGNATION			
	1" = 5'	1006017			
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PLAN & PROFILE		13	of		41
LINE "C" STA. 88+00 to 96+00	CONTRACT	PROJECT			
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SURVEY BOOK

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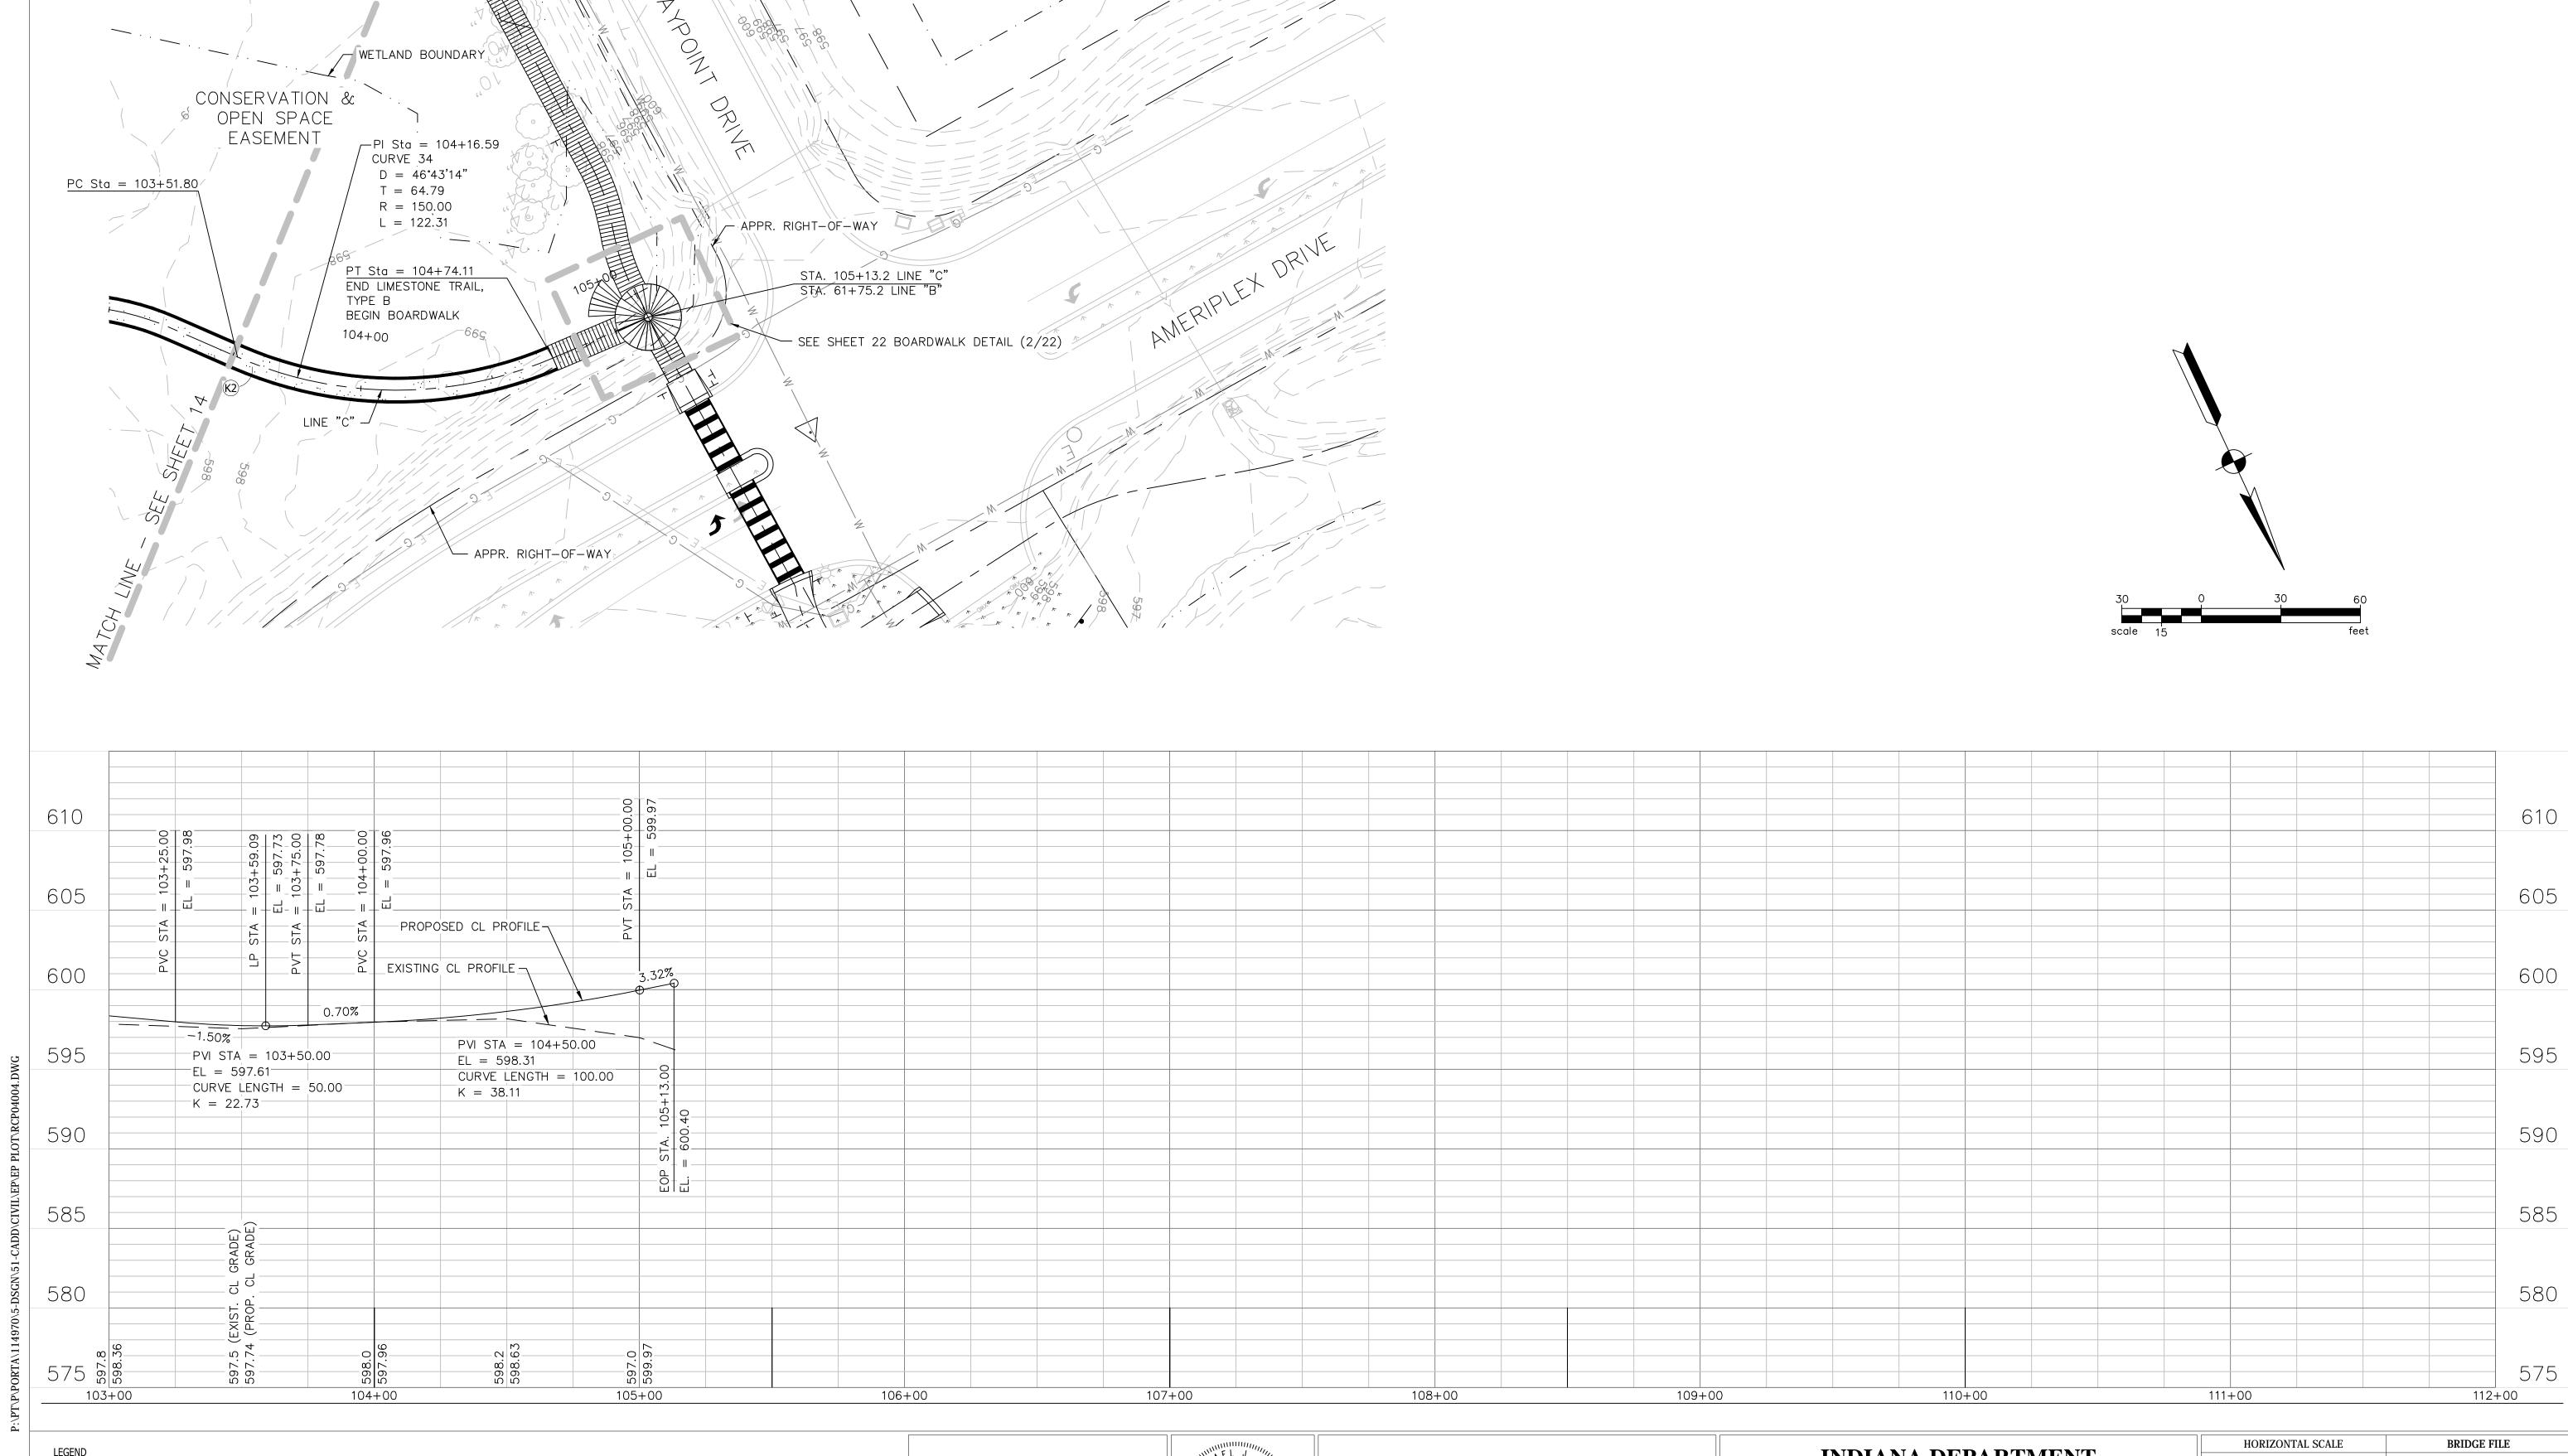
PLAN & PROFILE LINE "C" STA. 96+00 to 103+50

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LIMESTONE TRAIL SECTION
330#/SYD. (3") COMPACTED LIMESTONE AGGREGATE
660#/SYD. (6") COMPACTED AGGREGATE BASE, "O", SIZE NO. 53

PHONE: 219.513.2500
9200 CALUMET AVENUE
SUITE N501
MUNSTER, IN 46321

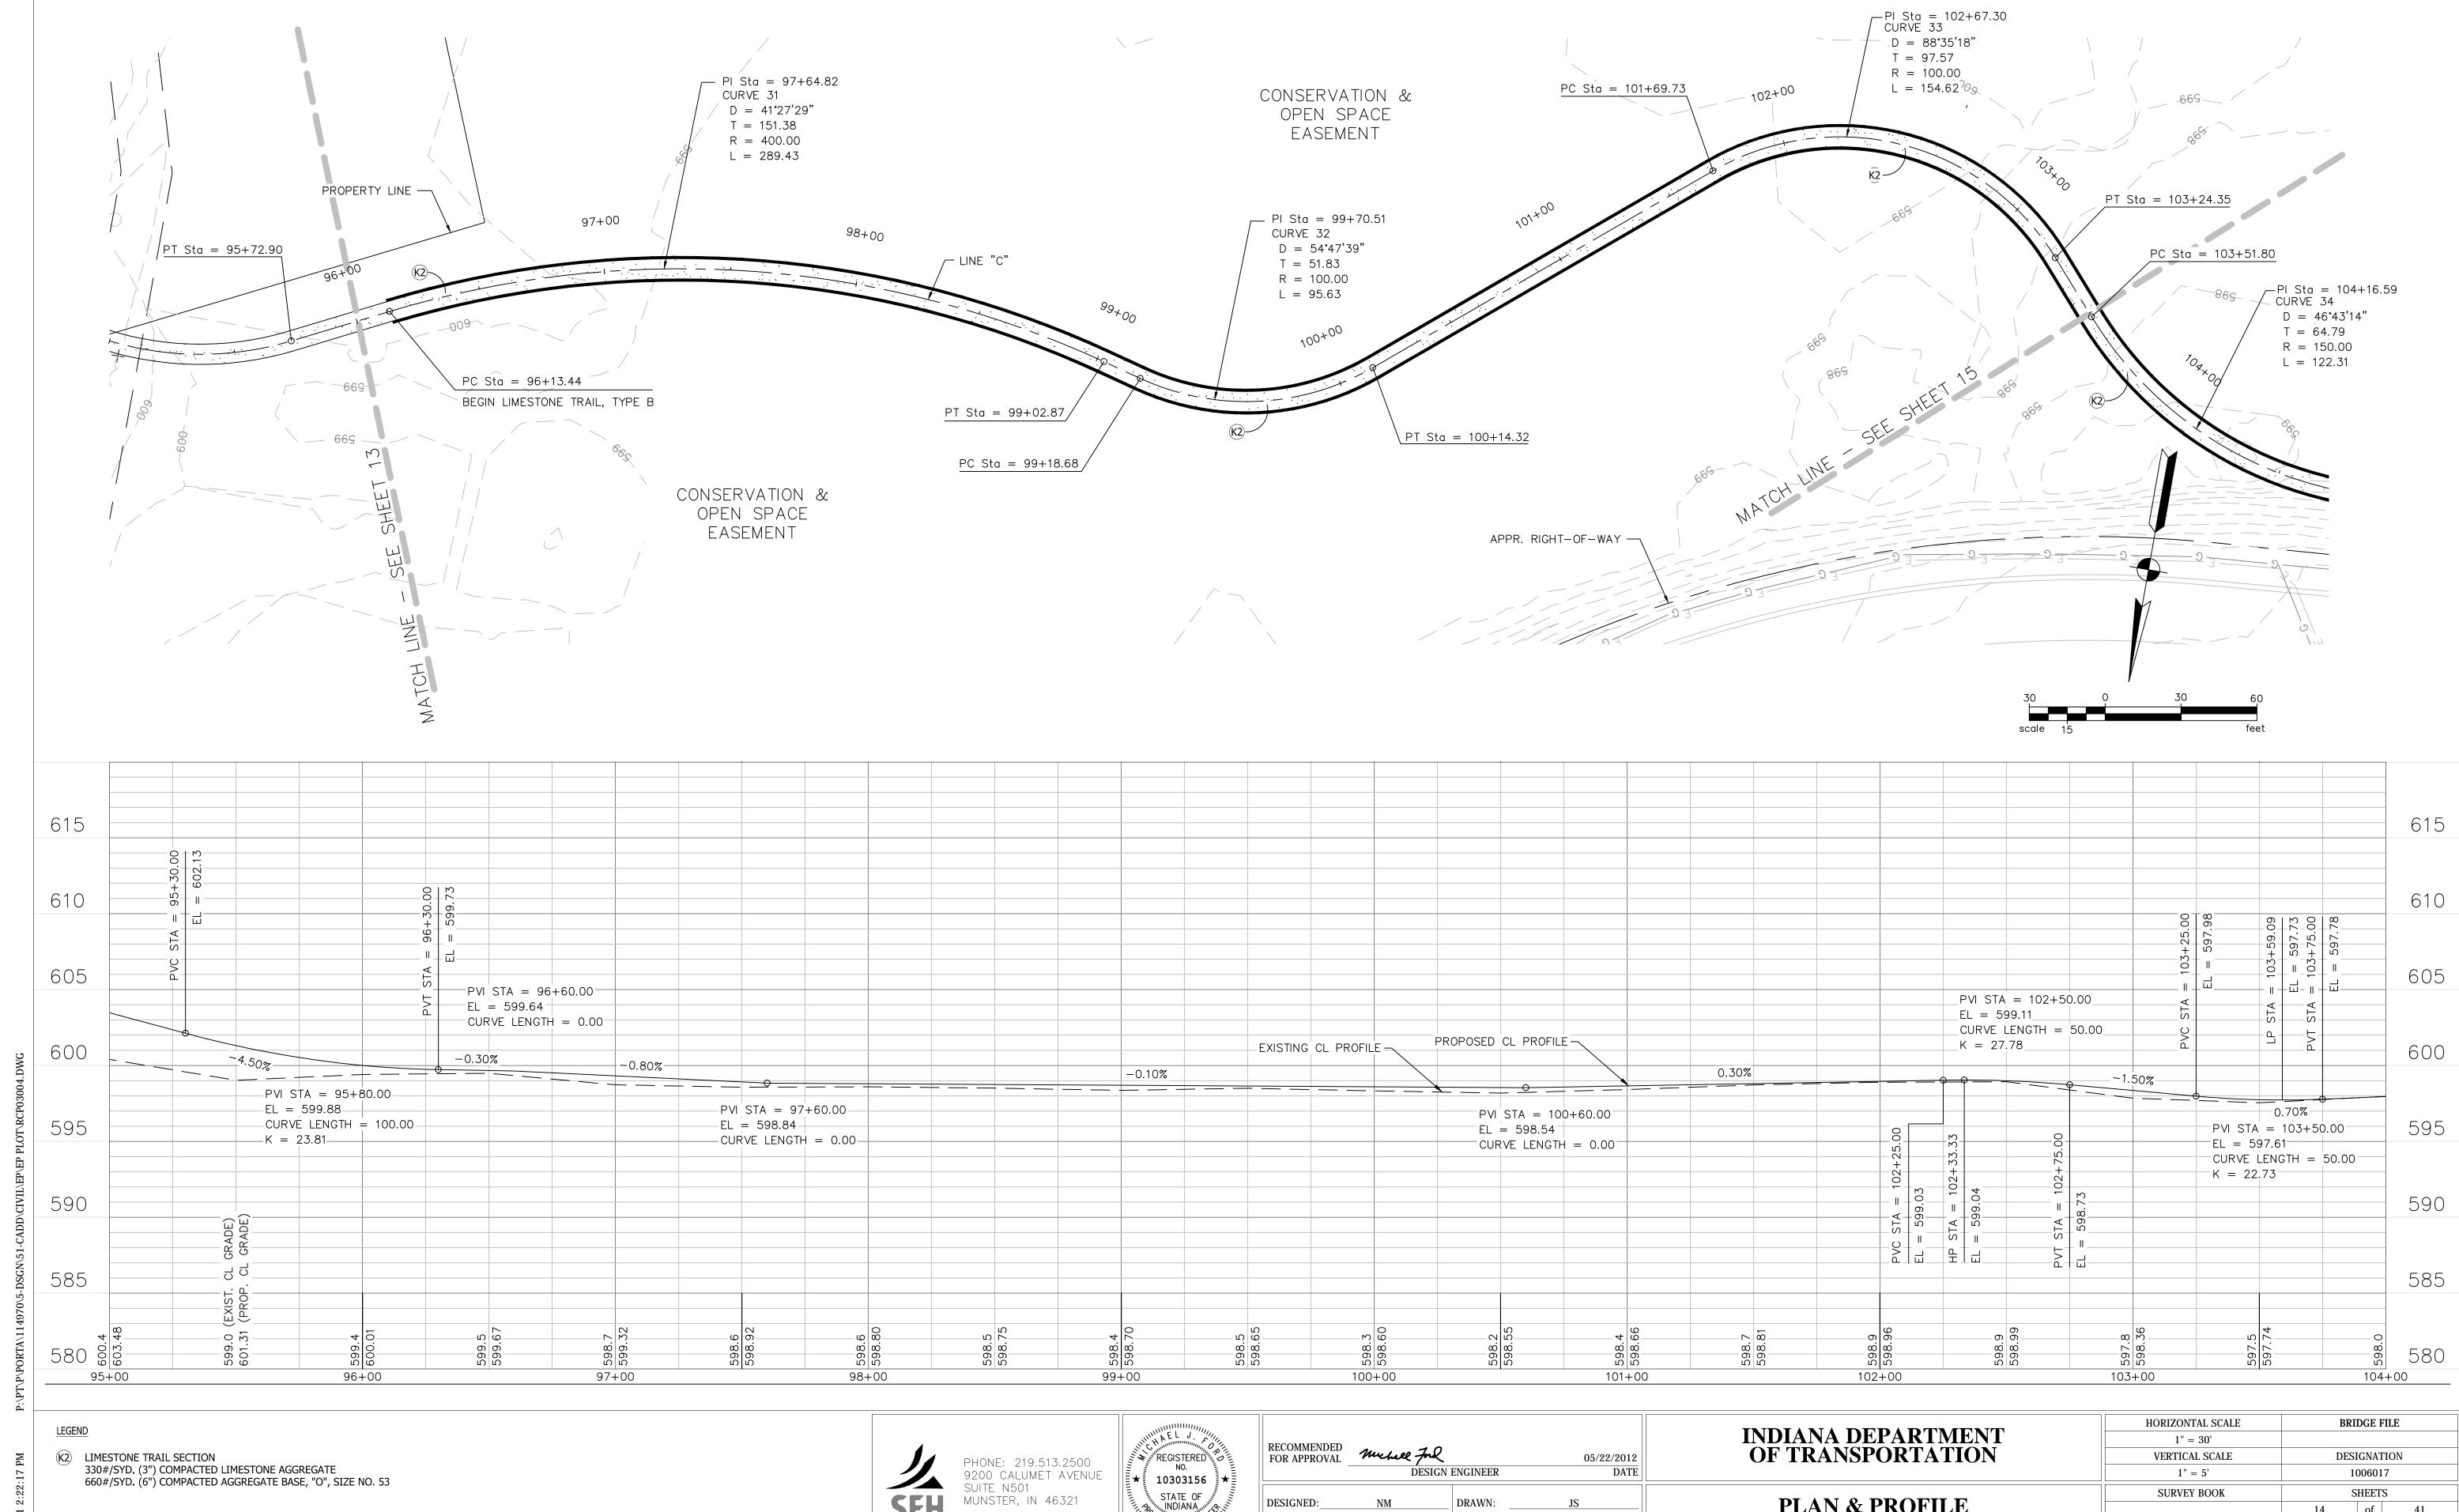


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INDIANA DEPARTMENT OF TRANSPORTATION

PLAN & PROFILE LINE "C" STA. 103+50 to 105+13

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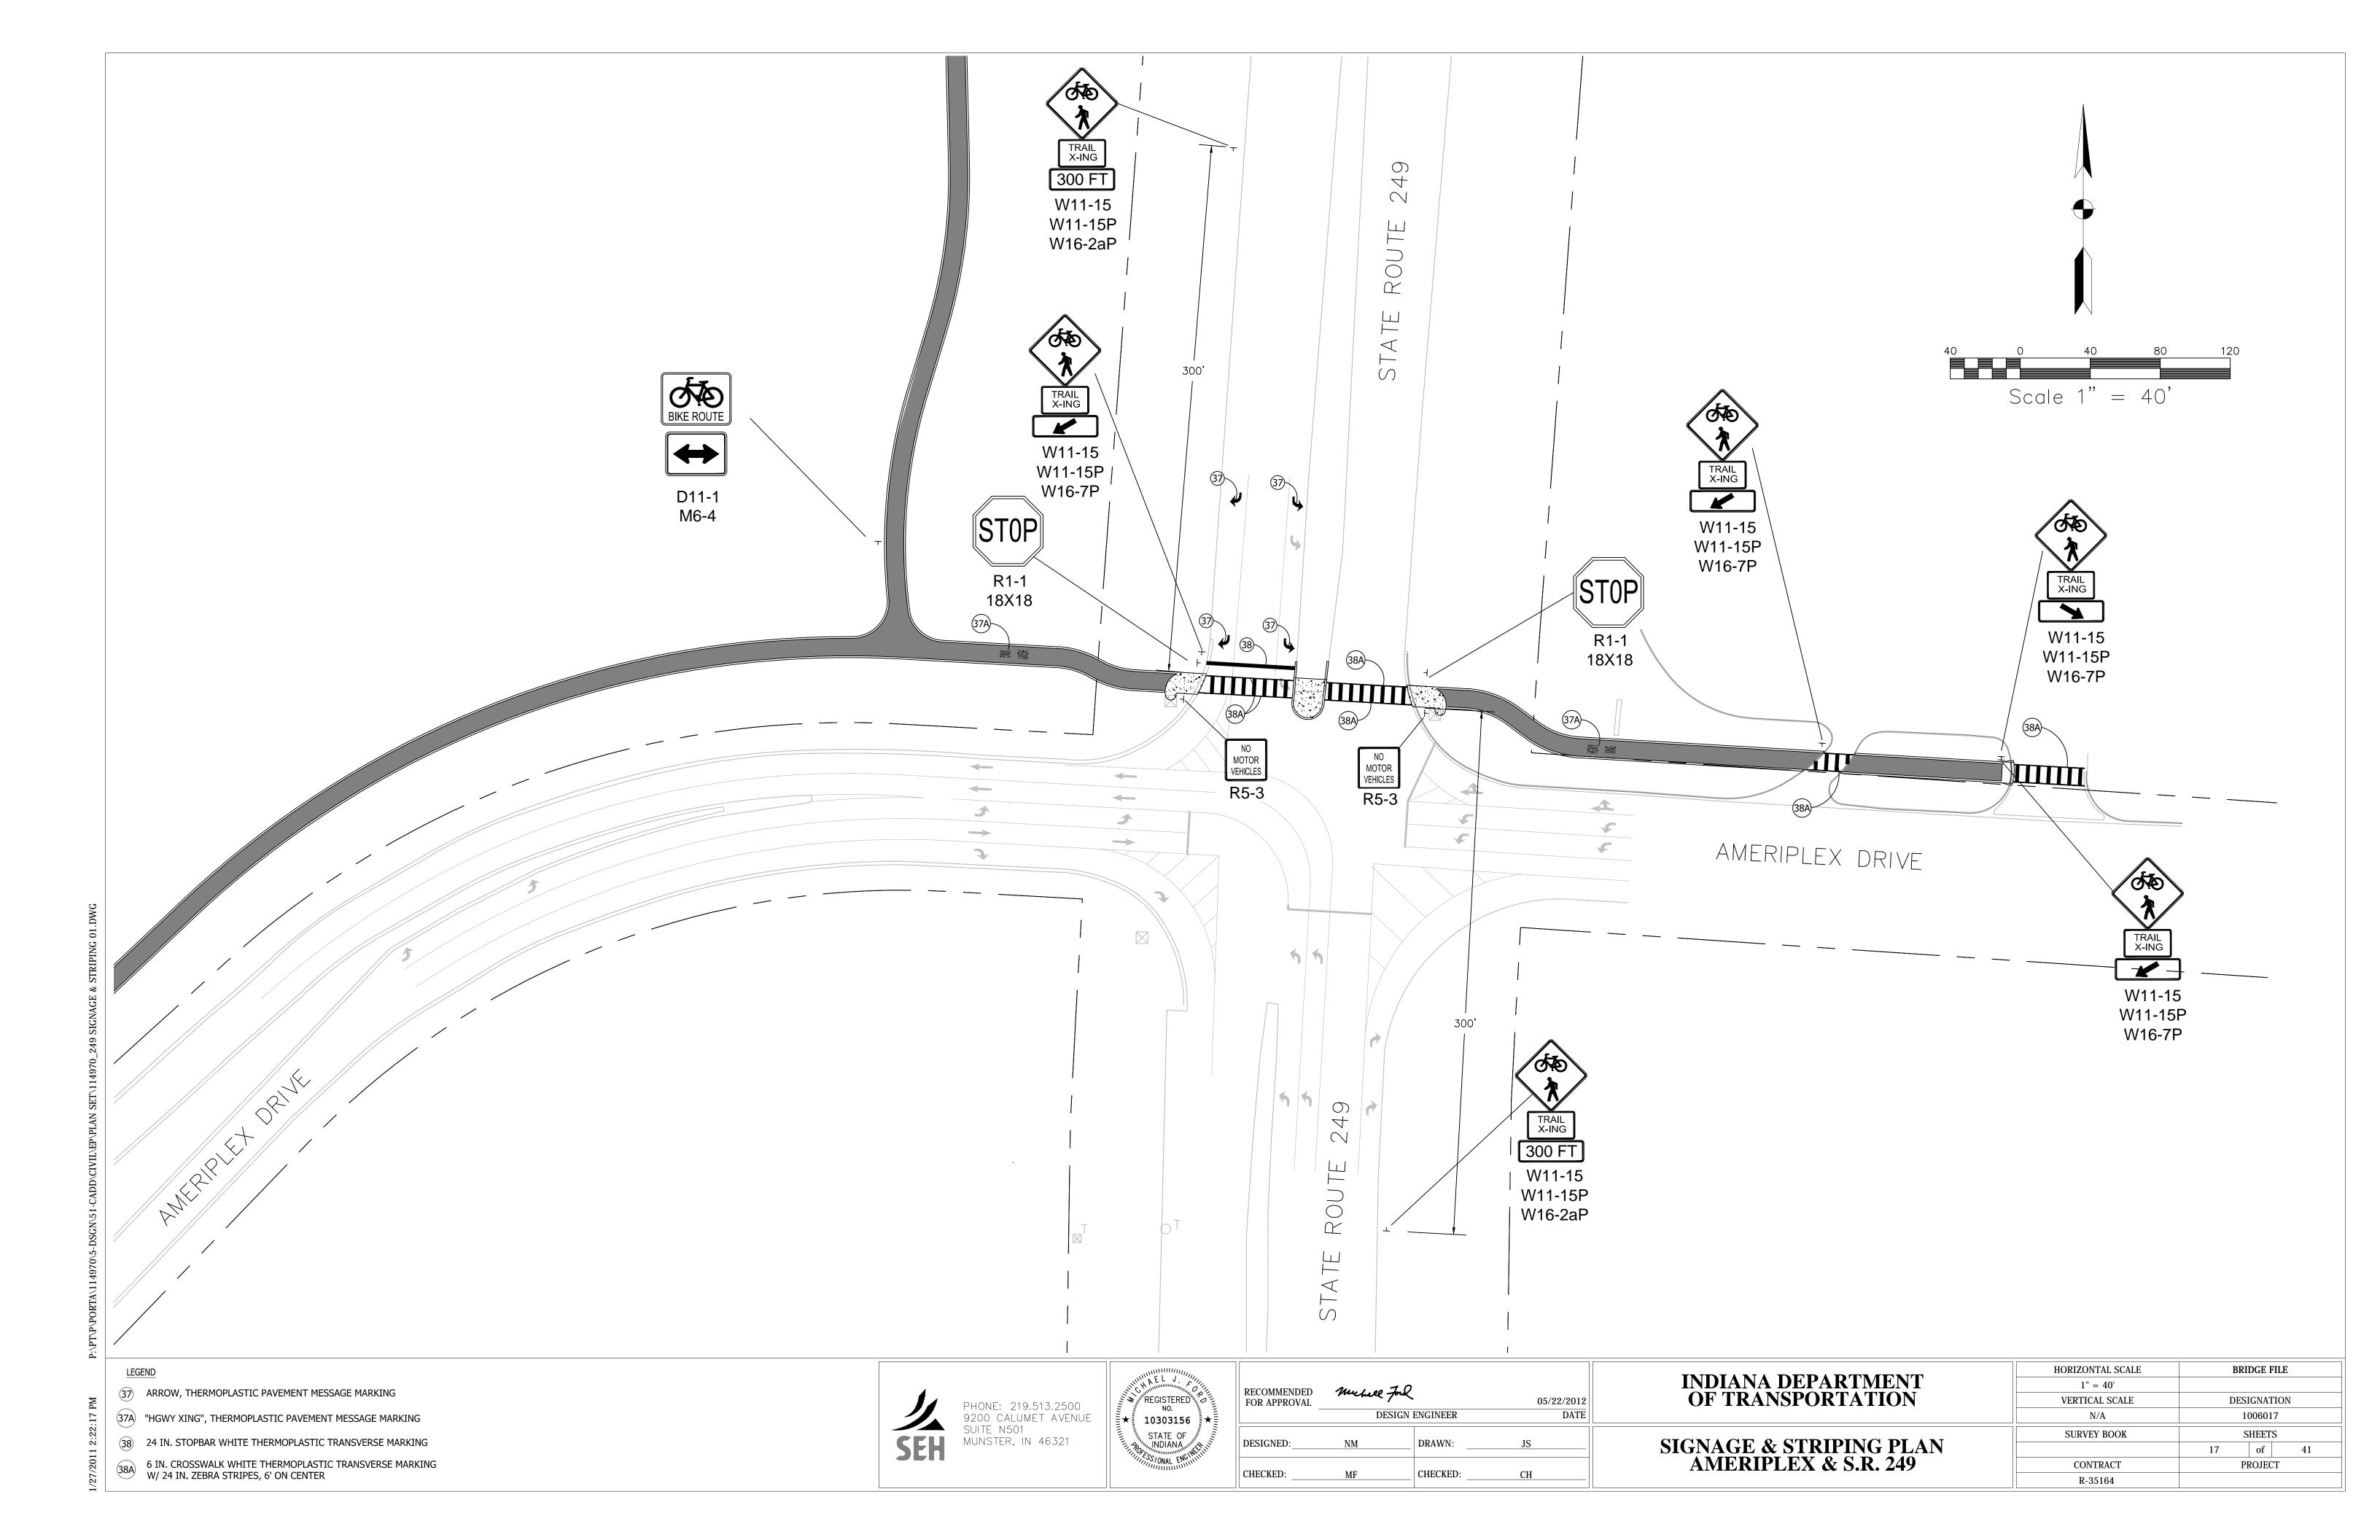
PLAN & PROFILE LINE "D" STA. 50+00 to 55+58.4


SHEETS

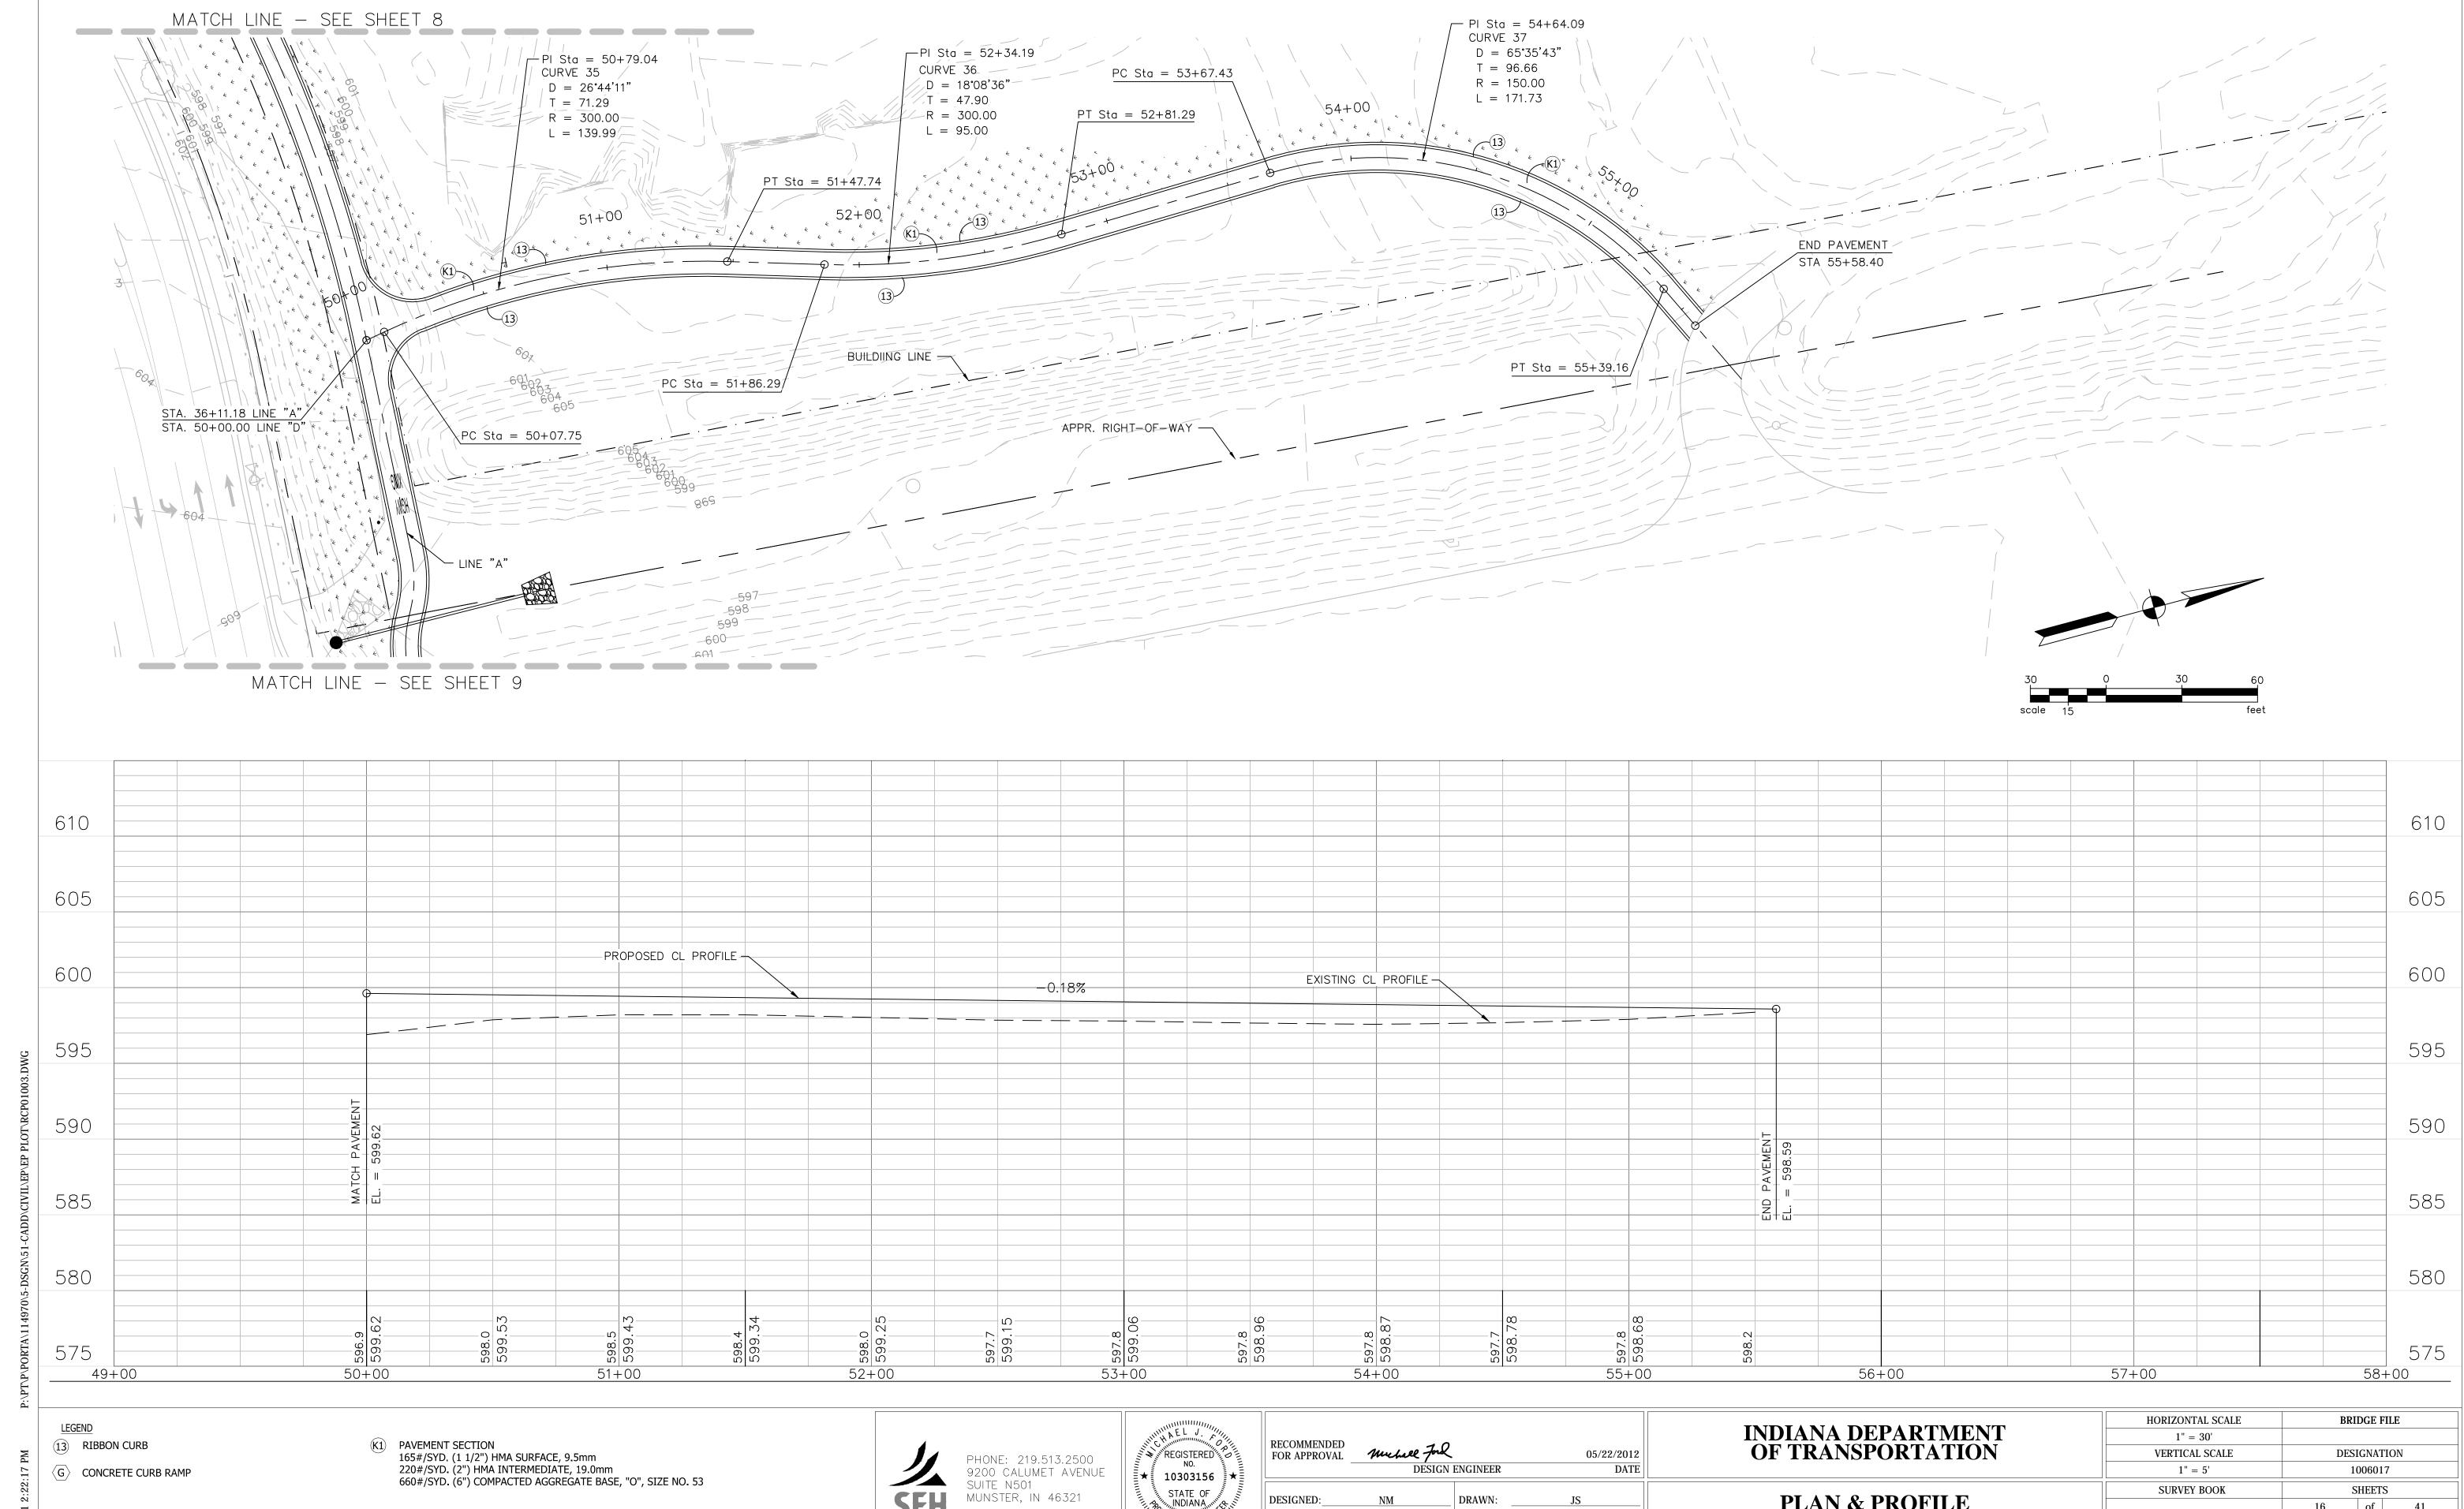of


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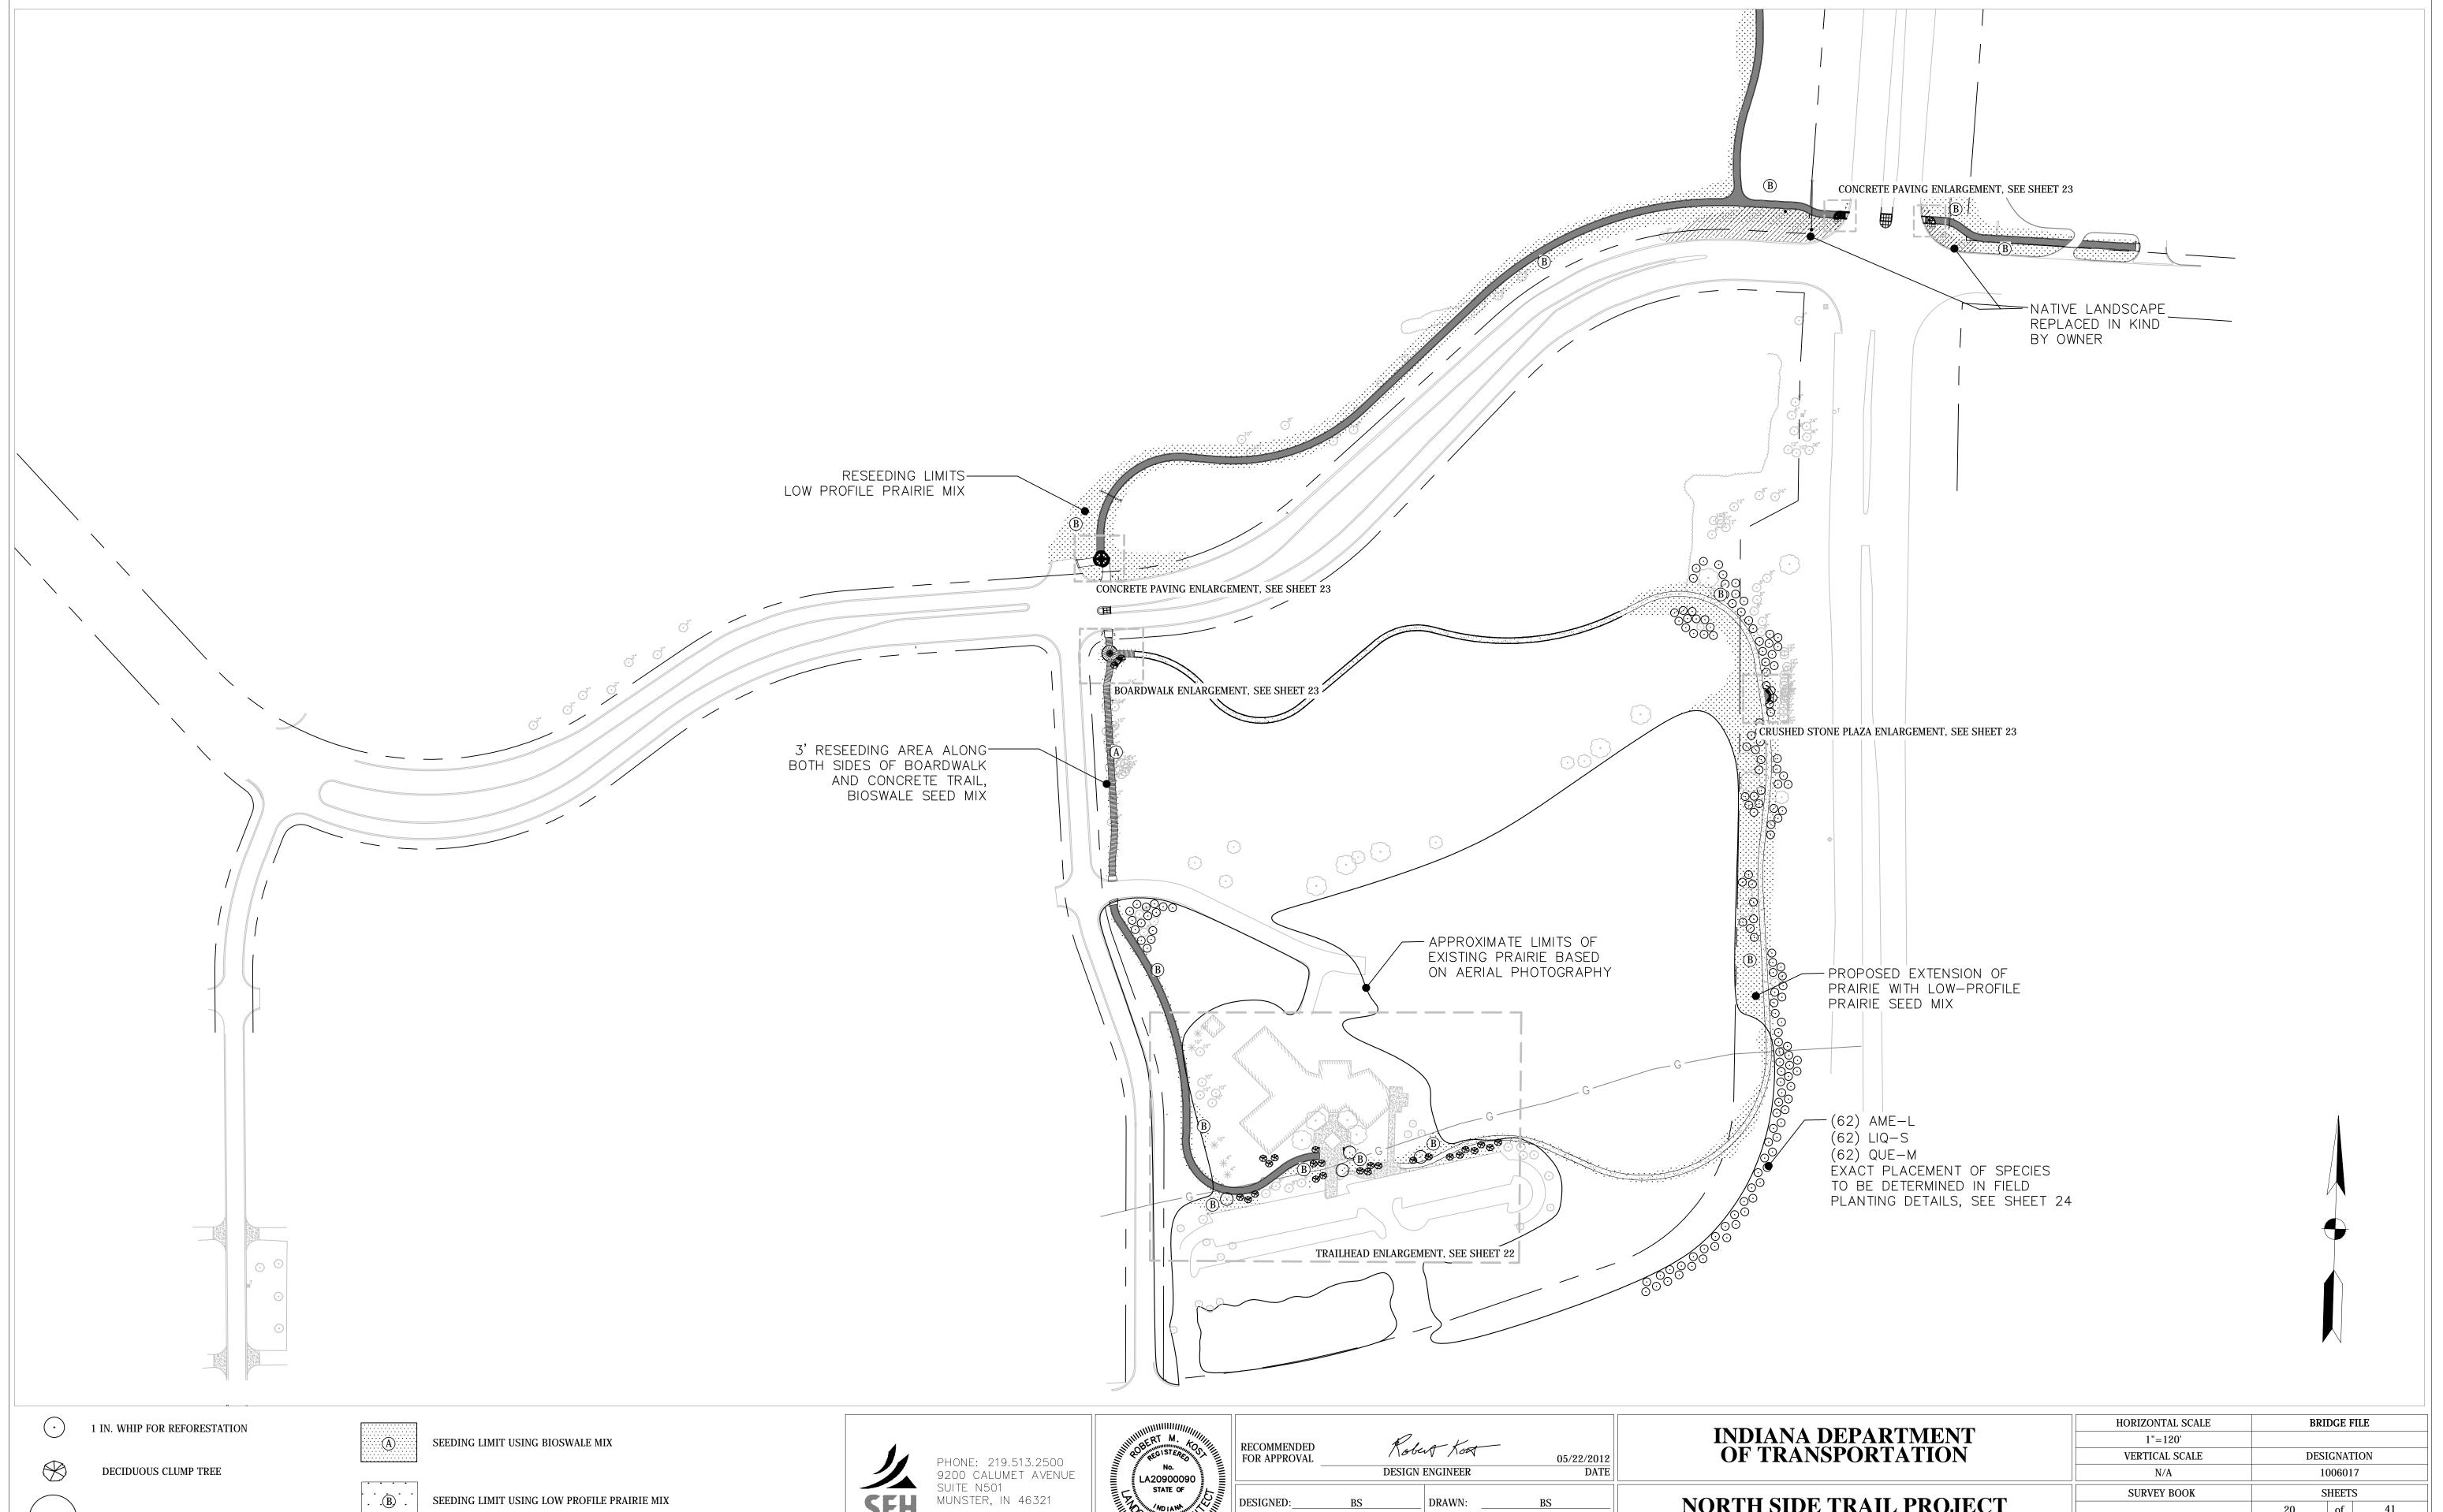
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CHECKED:



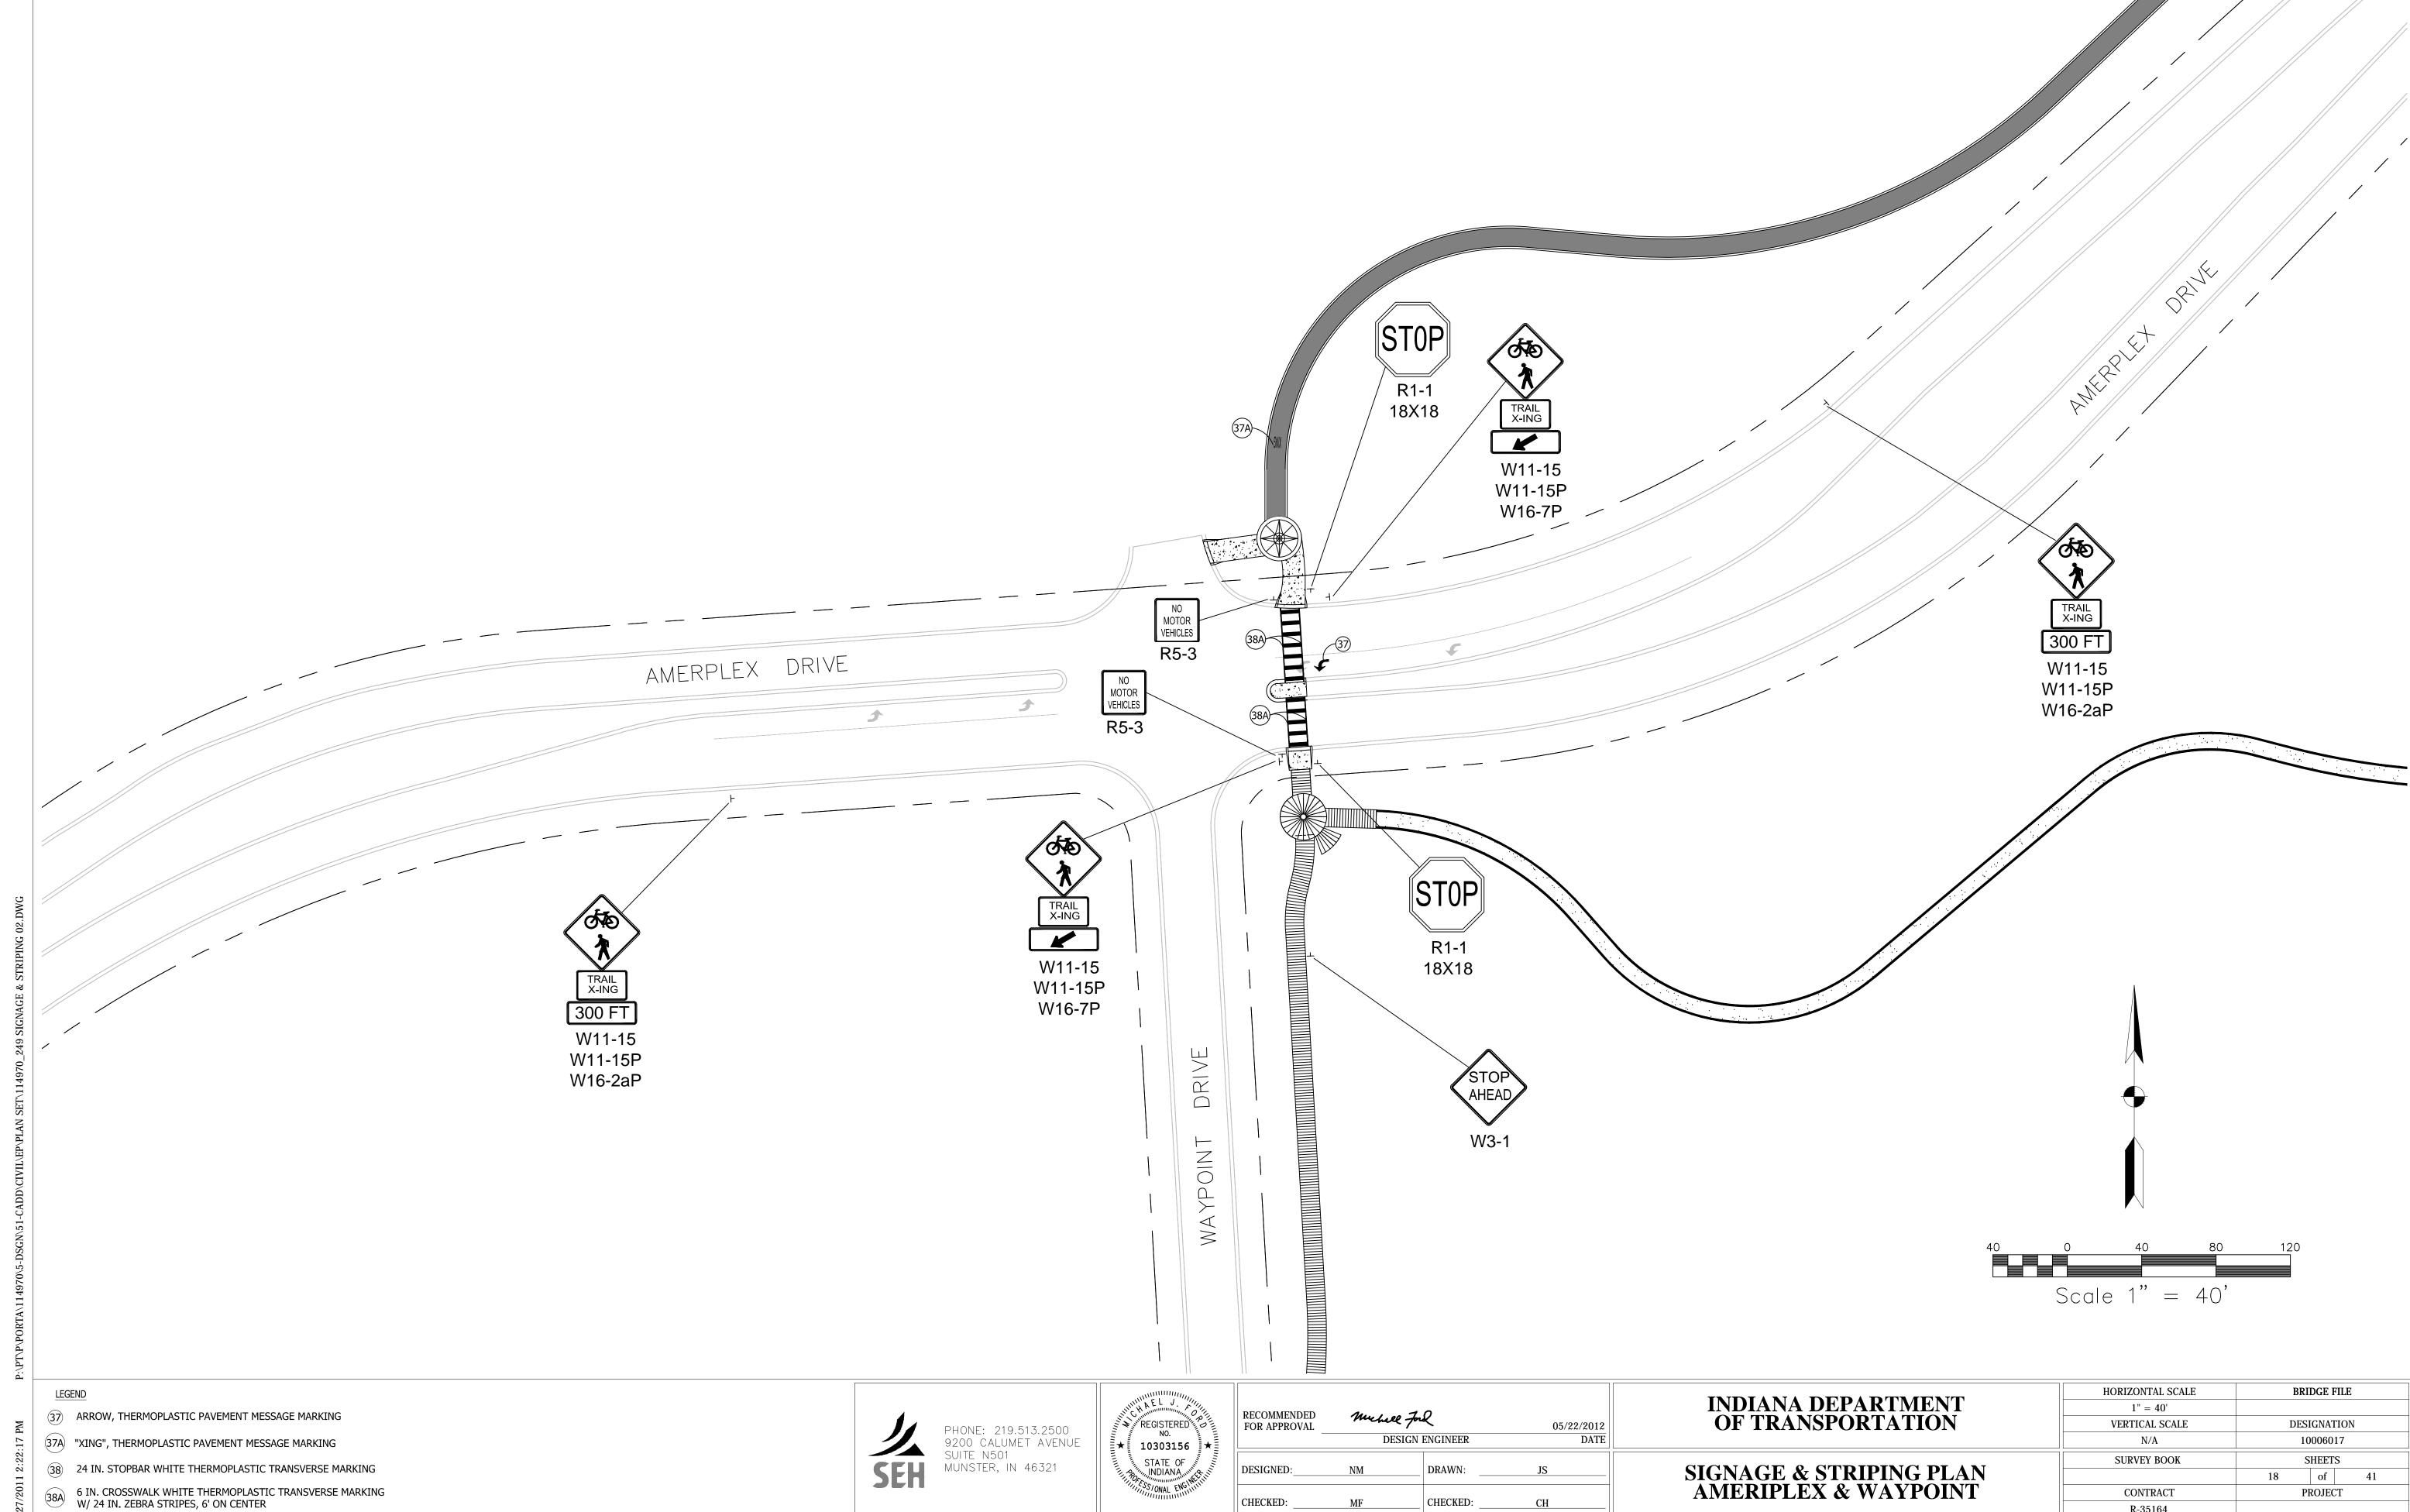

CHECKED:

SURVEY BOOK

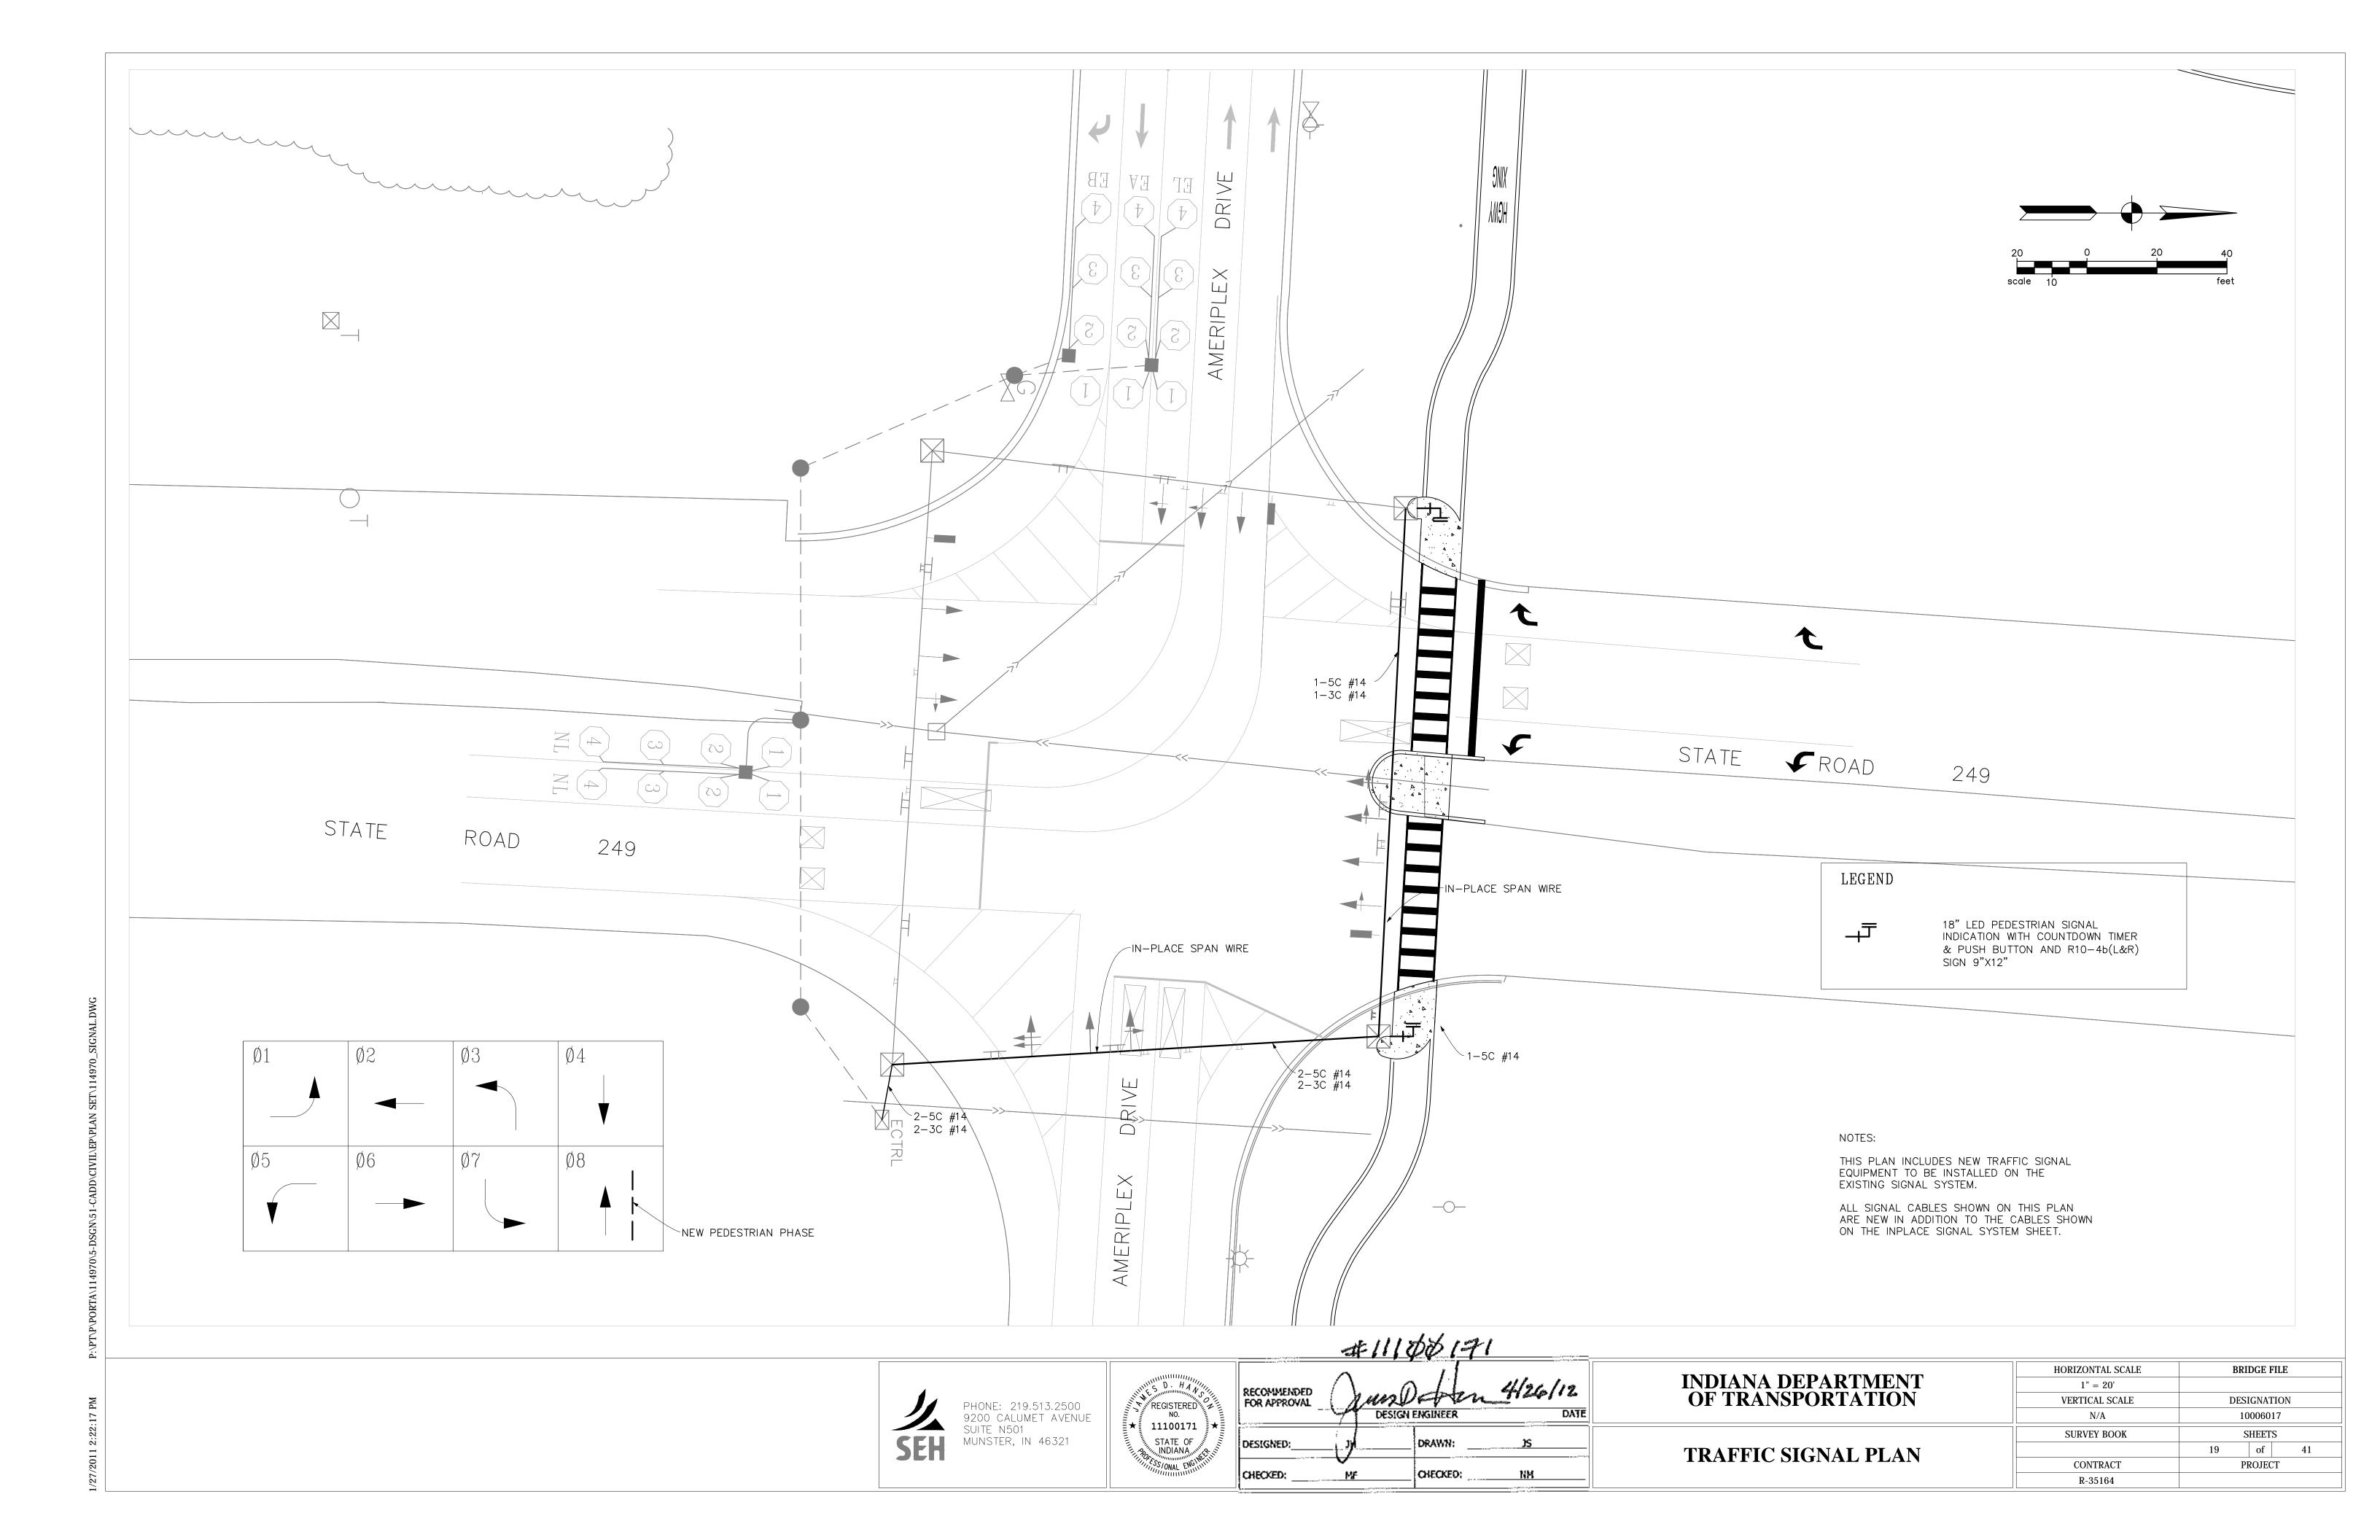CONTRACT

R-35164

NORTH SIDE TRAIL PROJECT OVERALL LANDSCAPE EXHIBIT

SHEETS

of


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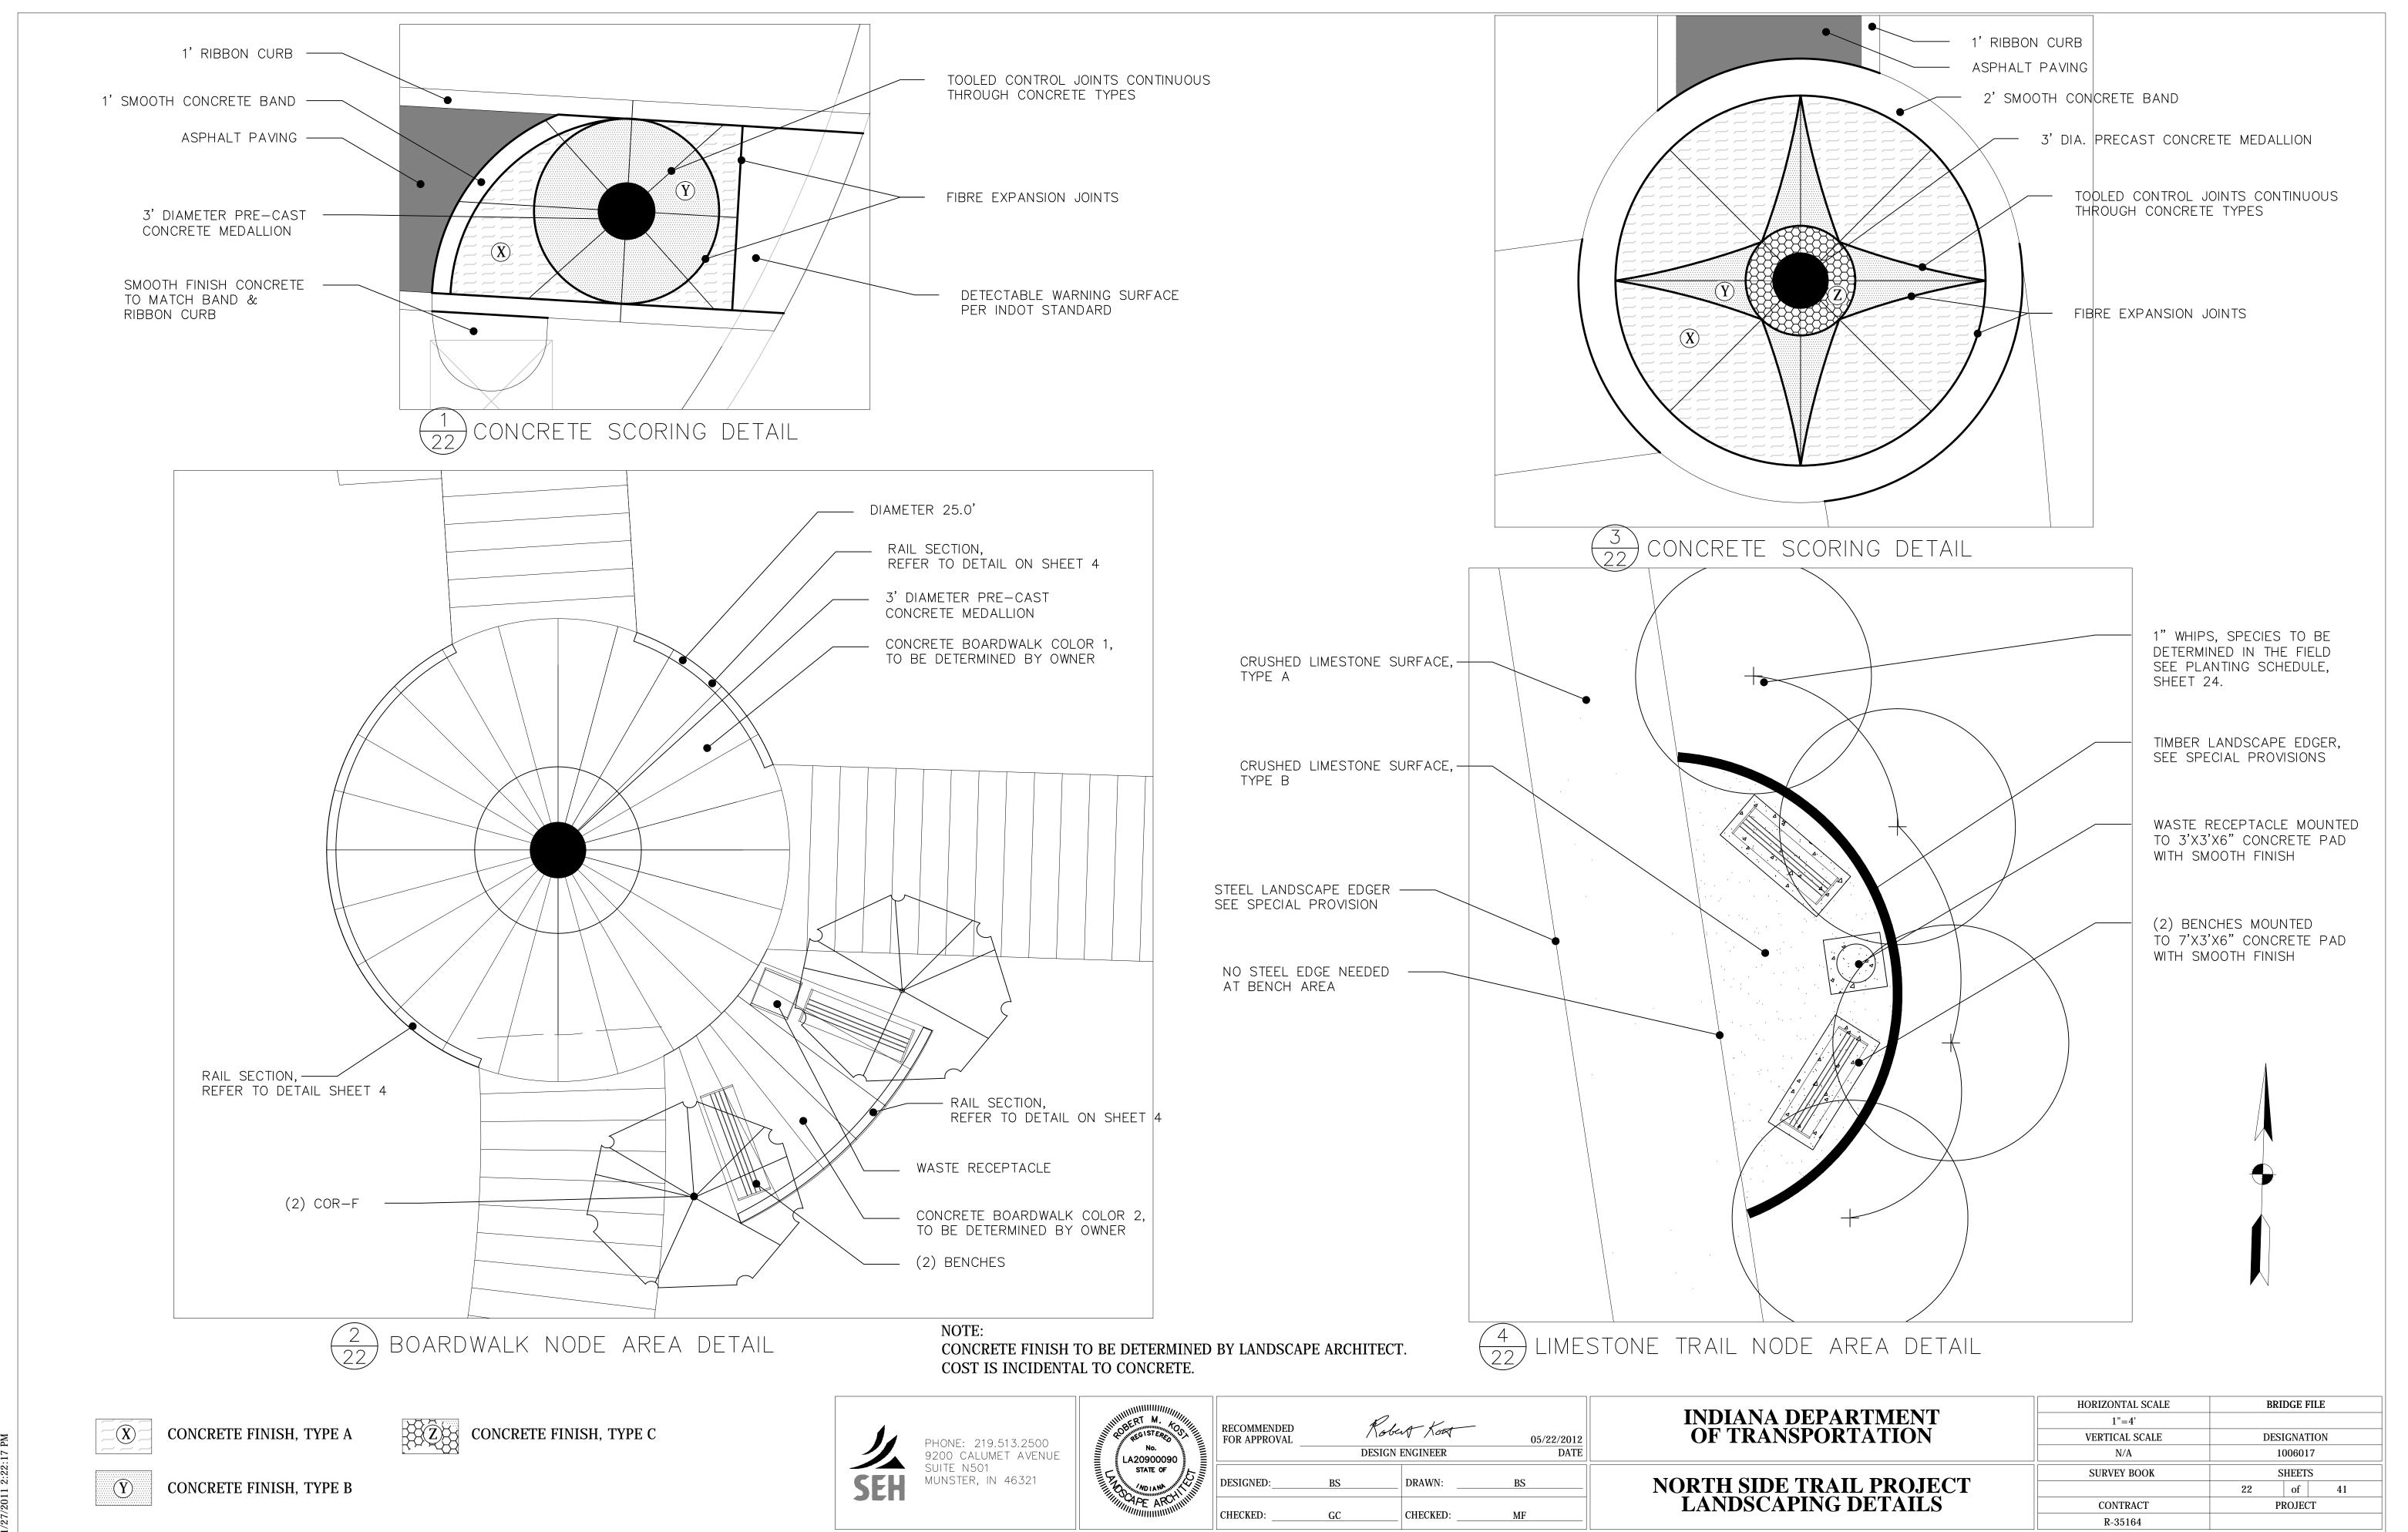
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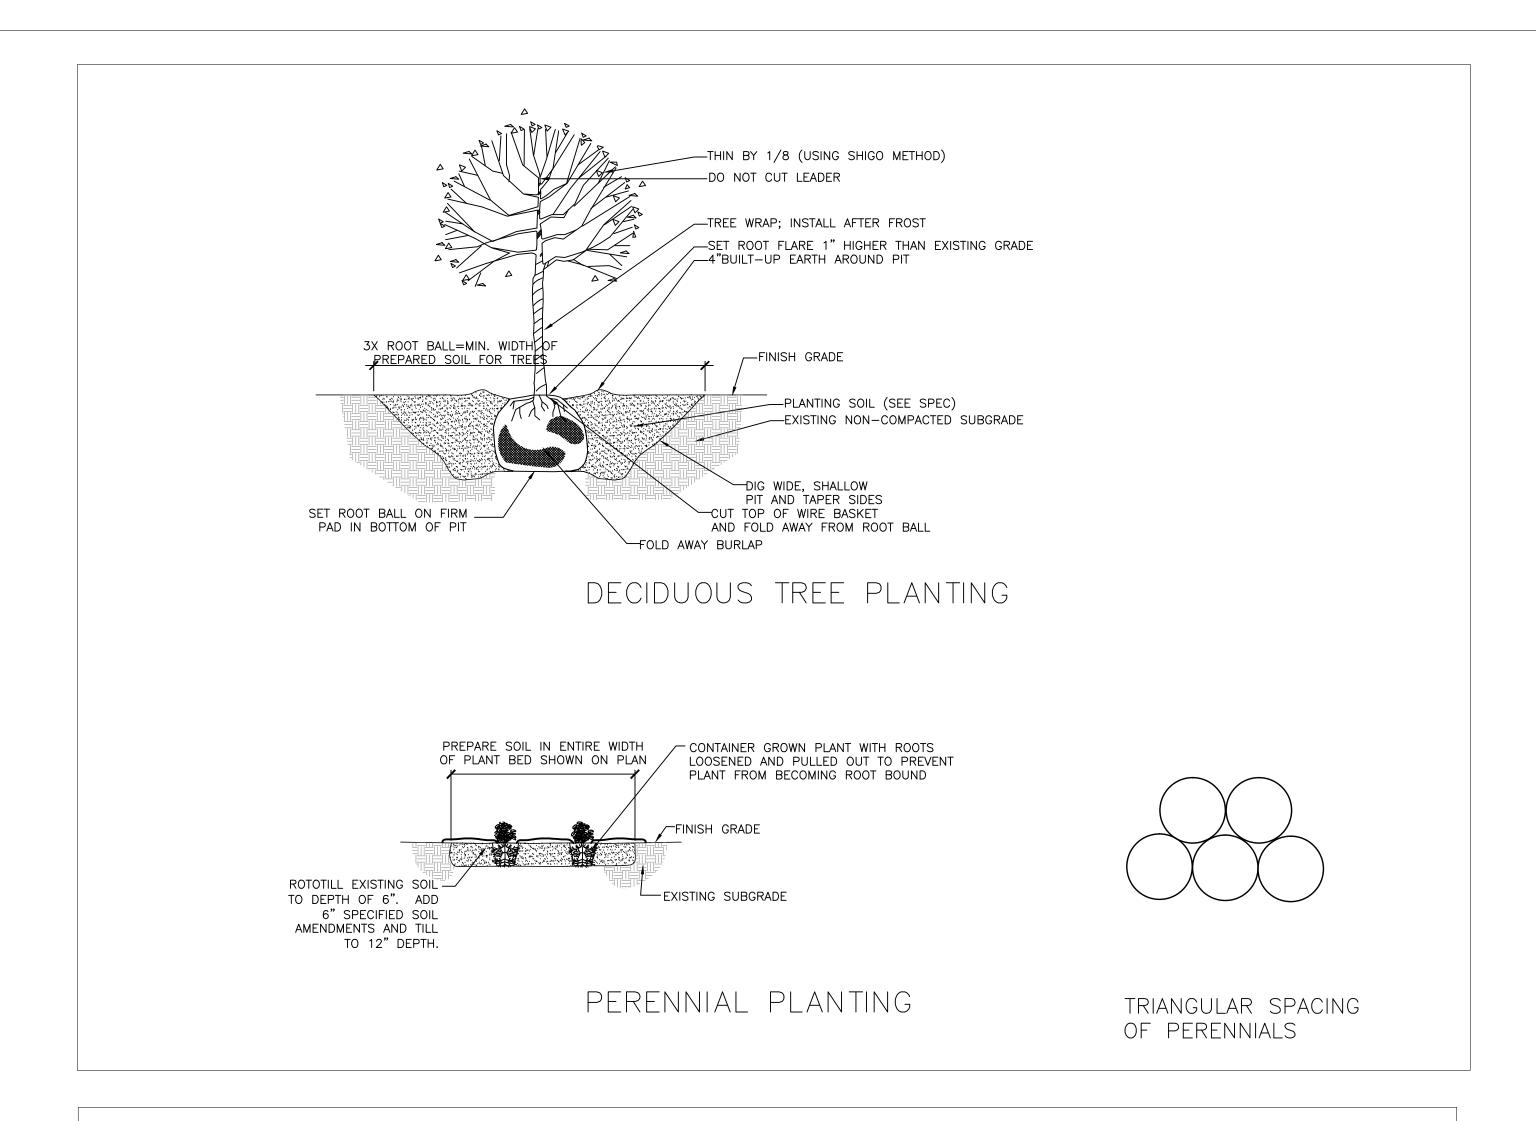
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DECIDUOUS TREE

SEEDING LIMIT USING LOW PROFILE PRAIRIE MIX





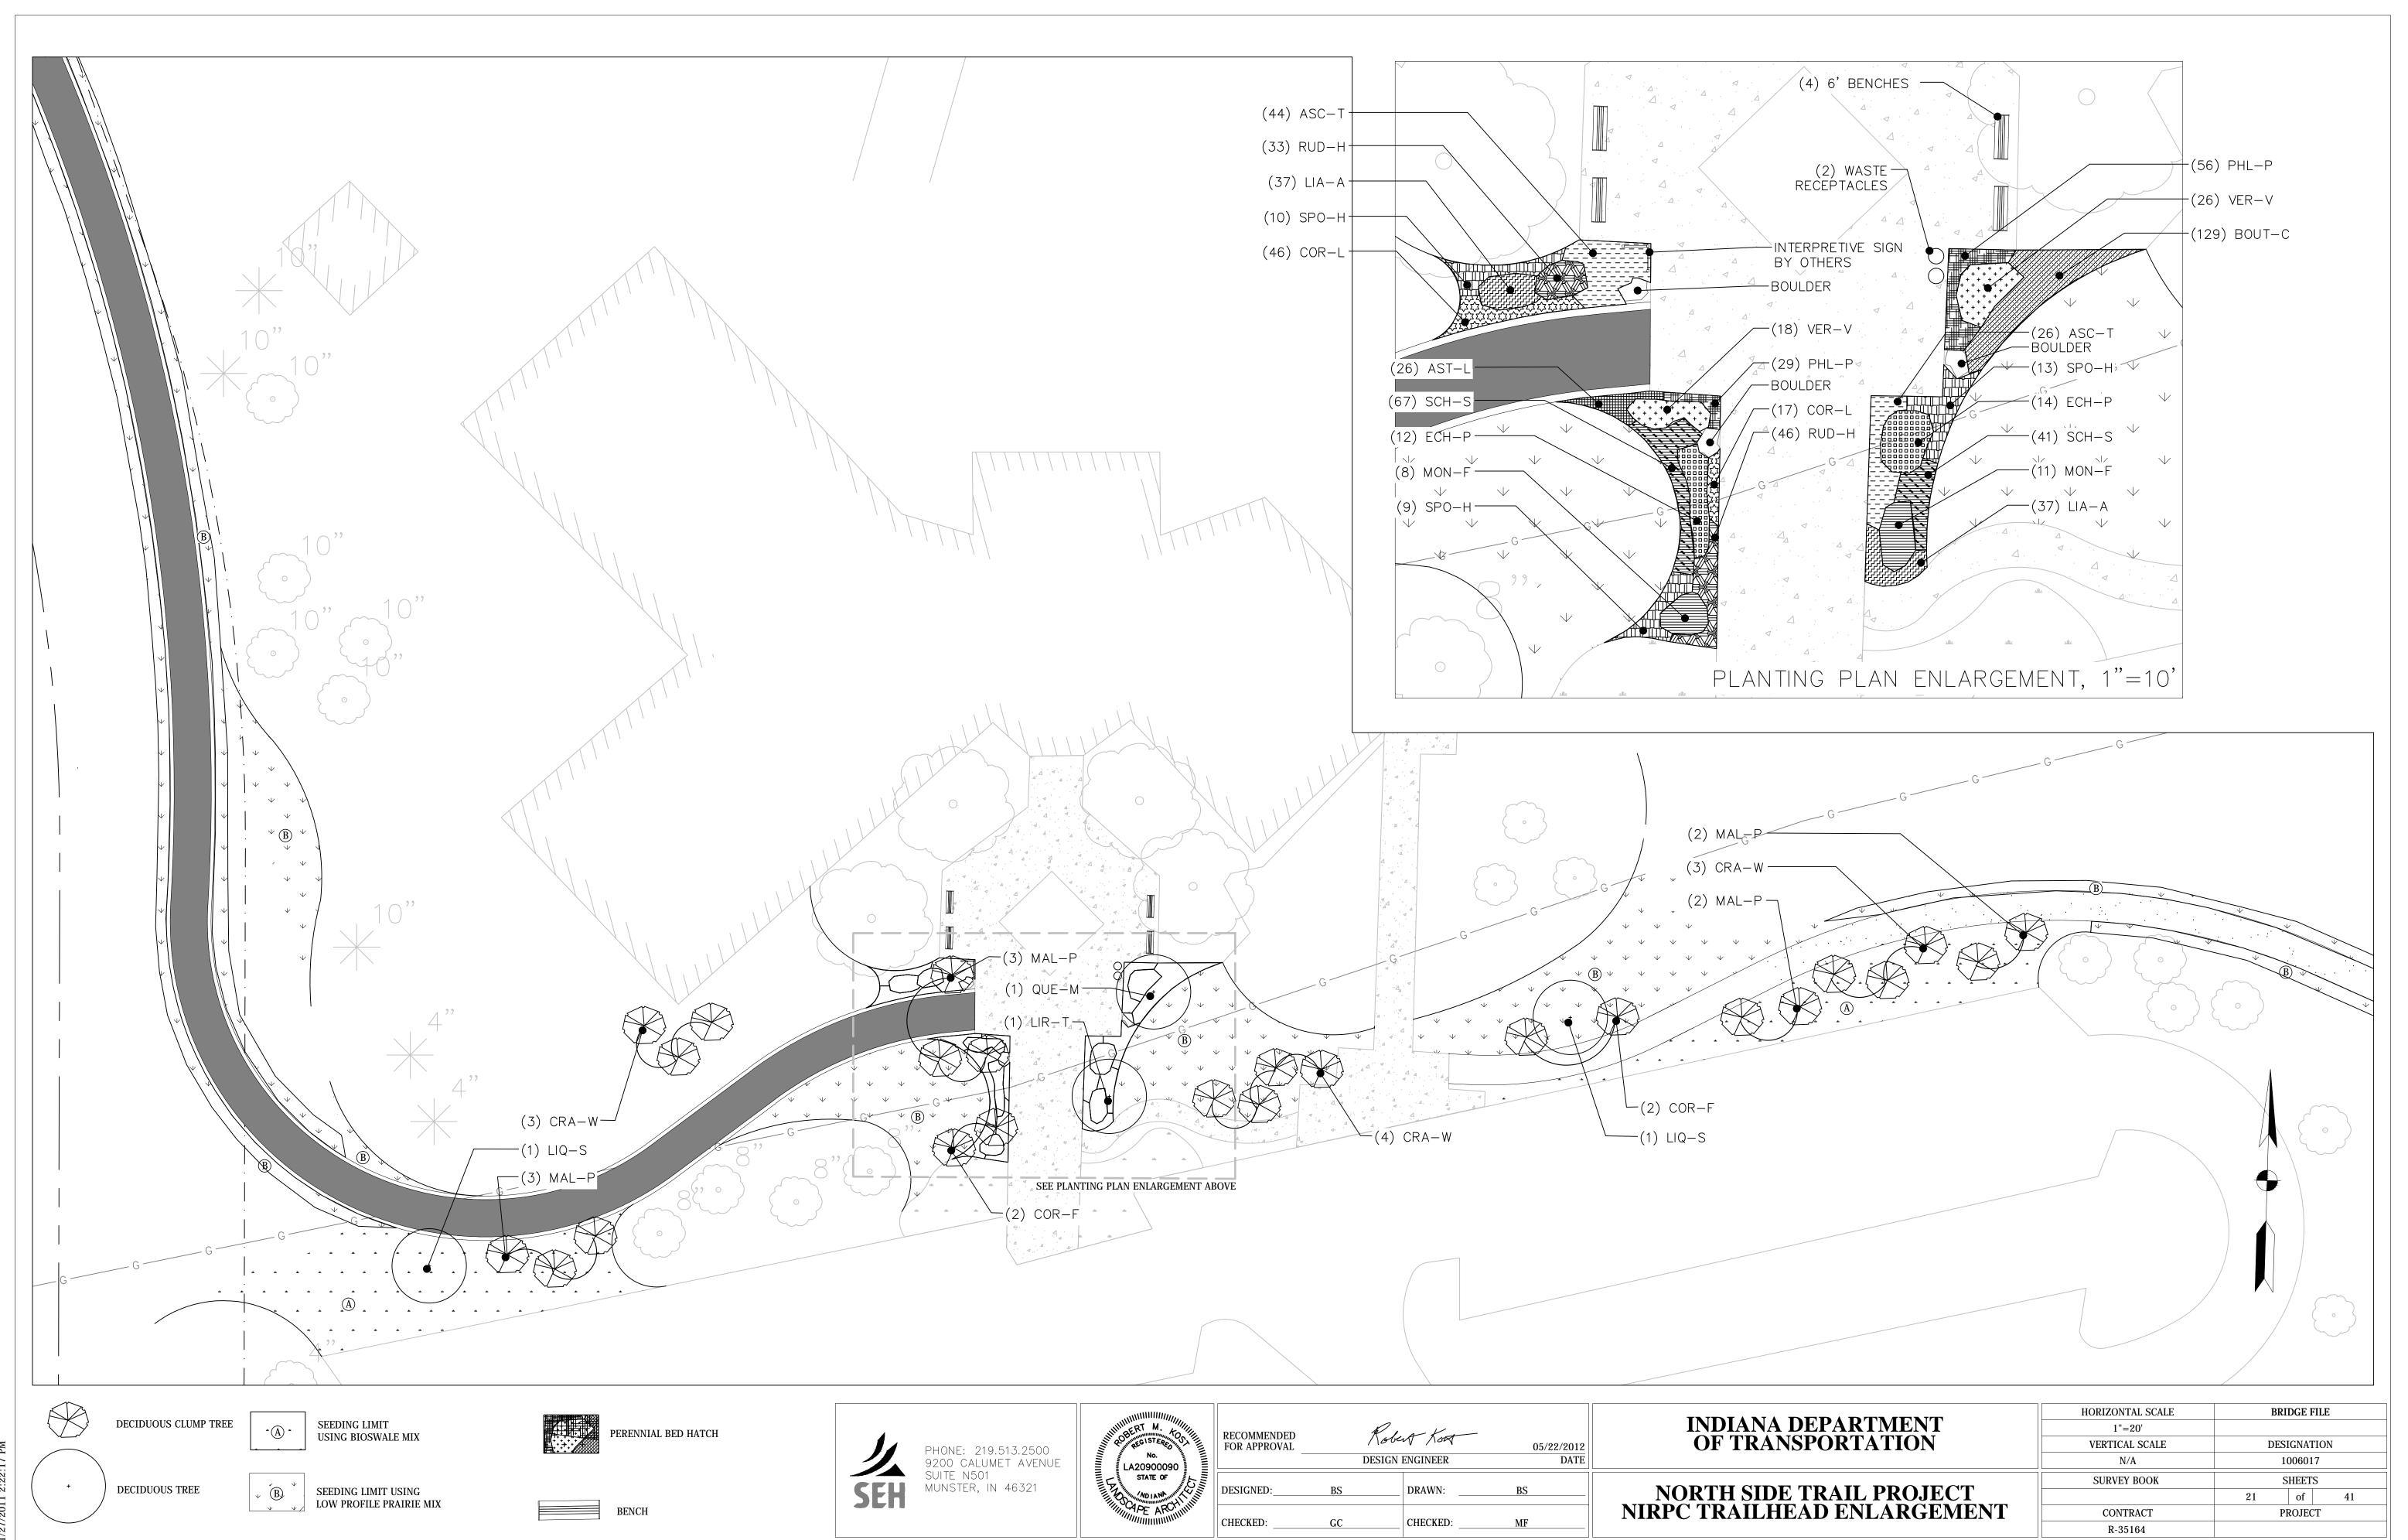

PLANTING NOTES

CONTRACTOR TO VERIFY PLANTS REQUIRED AS REFLECTED ON PLAN. QUANTITIES LISTED IN PLANT SCHEDULE ARE FOR REFERENCE ONLY. IF THERE IS A DISCREPANCY BETWEEN QUANTITIES LISTED IN PLANT SCHEDULE AND QUANTITIES SHOWN ON PLAN SHEETS, PLAN SHEETS SHALL GOVERN.

ALL TREE, SHRUB, AND PERENNIAL PLANTINGS SHALL BE MULCHED WITH 4" DEEP SHREDDED HARDWOOD MULCH WITHOUT FILTER FABRIC. MULCH SHALL BE INCIDENTAL TO PLANT MATERIALS.

CONTRACTOR IS RESPONSIBLE FOR ON-GOING MAINTENANCE OF ALL NEWLY INSTALLED MATERIALS UNTIL TIME OF OWNER ACCEPTANCE. ANY ACTS OF VANDALISM OR DAMAGE WHICH MAY OCCUR PRIOR TO OWNER ACCEPTANCE SHALL BE THE RESPONSIBILITY OF THE CONTRACTOR.

NO PLANT MATERIAL SUBSTITUTIONS WILL BE ACCEPTED UNLESS PRIOR APPROVAL IS REQUESTED OF THE LANDSCAPE ARCHITECT BY THE LANDSCAPE CONTRACTOR PRIOR TO THE SUBMISSION OF A BID AND/OR QUOTATION.

CONTRACTOR SHALL VISIT AND INSPECT SITE TO BECOME FAMILIAR WITH EXISTING CONDITIONS RELATING TO THE NATURE AND SCOPE OF WORK PRIOR TO SUMBITTING BID.

ALL PLANT BEDS SHALL BE EDGED USING SPADED GARDEN EDGE UNLESS OTHERWISE NOTED ON PLANS.

ALL SEEDED AREAS SHALL RECIEVE 3 INCHES DEPTH OF TOPSOIL. ALL PLANT BEDS SHALL RECIEVE 12 INCH DEPTH OF PREPARED PLANTING SOIL. EACH TREE AND SHRUB SHALL RECEIVE 1 CUBIC YARD OF PREPARED PLANTING SOIL AMENDED WITH NATIVE SOIL.

SEED DISTURBED AREAS ALONG THE BACK OF ALL NEW ROAD AND DRIVEWAY CURBING UP TO THE EDGE OF PLANTING BEDS OR TO EXISTING UNDISTURBED GROUNDCOVER.

ALL MASS PLANTING BEDS FOR SHRUBS AND PERENNIALS TO BE EXCAVATED TO A MINIMUM DEPTH OF 12 INCHES, ROTO—TILL SUBSOIL TO A DEPTH OF 6 INCHES AND RE—FILLED WITH PREPARED PLANTING SOIL CONSISTING OF TOPSOIL, SAND AND COMPOST (PERCENTAGES TO BE DETERMINED).

LAWN AREAS TO BE ROTO-TILLED TO A DEPTH OF 4 INCHES AND TOP-DRESSED WITH A MINIMUM OF 3 INCHES OF TOPSOIL.

AREAS TO BE SEEDED WITH "SWALE SEED MIX" AND "LOW PROFILE PRAIRIE SEED MIX" TO BE ROTO-TILLED TO A DEPTH OF 4 INCHES AND AMENDED WITH SAND AND/OR COMPOST AS SPECIFIED, RE-TILLED TO A DEPTH OF 6 INCHES, AND TOPDRESSED WITH TOPSOIL.

TREES SHALL BE PLANTED IN PITS 3 TIMES THE WIDTH OF THE ROOT BALL WITH ROOT CROWN SET 2 INCHES ABOVE FINAL GRADE. BACKFILL WITH A PLANTING MIX COMPRISED OF EQUAL PARTS NATIVE EXCAVATED SOIL, SAND, AND COMPOST AS SPECIFIED.

SPADED GARDEN EDGE TO BE PLACED BETWEEN MASS PLANTING BEDS AND LAWN AREAS.

PROTECT EXISTING TREES TO BE PRESERVED FROM DAMAGE DURING CONSTRUCTION.

PLANTING SCHEDULE

	CODE	Quantity	Botanical Name	Common Name	Spacing	Size	Root	Notes
Shade trees			_					
	LIQ-S	2	Liquidambar styraciflua	Sweet Gum	per plan	2.5" cal	B&B	
	LIR-T	1	Liriodendron tulipifera	Tulip Tree	per plan	2.5" cal	B&B	
	QUE-M	1	Quercus macrocarpa	Burr Oak	per plan	2.5" cal	B&B	
-								
Ornamental trees								<u>.</u>
	COR-F	6	Cornus florida	Flowering Dogwood	per plan	6'-7'	B&B	clump
	CRA-W	10	Crataegus viridis 'Winter King'	Winter King Hawthorn	per plan	6'-7'	B&B	clump
	MAL-P	10	Malus x 'Prairifire'	Prairifire Crabapple	per plan	6'-7'	B&B	clump
Reforestation trees								
Reforestation trees	AME-L	62	Amelanchier laevis	Smooth Serviceberry	per plan	1" whip	bare root	
	LIQ-W	62	Liquidambar styraciflua	Sweet Gum	per plan	1" whip	bare root	Species placement determined in field
	QUE-W	62	Quercus macrocarpa	Burr Oak	per plan	1" whip	bare root	Species placement acternined in neid
	QUL-VV	02	Quercus macrocarpa	Duil Oak	per plan	1 Willip	bare root	
Herbaceous perennials								
	ASC-T	70	Asclepias tuberosa	Butterfly Weed	18"	gallon	container	
	AST-L	26	Aster laevis	Smooth Blue Aster	12"	gallon	container	
	COR-L	63	Coreopsis lanceolata	Sand Coreopsis	12"	gallon	container	
	ECH-P	26	Echinacea purpurea	Purple Coneflower	24"	gallon	container	
	LIA-A	74	Liatris aspera	Rough Blazing Star	12"	gallon	container	
	MON-F	19	Monarda fistulosa	Wild Bergamot	24"	gallon	container	
	PHL-P	85	Phlox pilosa	Sand Prairie Phlox	12"	gallon	container	
	RUD-H	79	Rudbeckia hirta	Black-eyed Susan	12"	gallon	container	
	VER-V	44	Veronicastrum virginicum	Culver's Root	18"	gallon	container	
Perennial Grasses	BOU-C	120	Bouteloua curtipendula	Side-Oats Grama	12"	gallon	container	
	SCH-S	129	•	Little Blue-Stem	12"	gallon		
		108	Schizacarium scoparium			gallon	container	
	SPO-H	32	Sporobolous heterolepis	Prairie Dropseed	24"	gallon	container	
Seeding								
	Hatch "A"	0.02	2 Acres Bioswale Seed Mix, Applied	d @ 20.34 lbs/acre				
	Hatch "B"	3.75	Acres Low Profile Prairie Seed M	ix. Applied @17.126 lbs/acre	2			

NOTE

ORNAMENTAL TREES SHALL HAVE 1 IN. MINIMUM TRUNK DIAMETER

CUSTOM SEED MIXES


MIX A

Custom Bioswale Seed Mix Specification Apply @ 20.34 pounds per acre 0.56% Asclepias incarnata 0.28% Asclepias sullivantii 50.44% Avena sativa 0.56% Bidens cernua 0.28% Calamagrostis canadensis 0.94% Carex scoparia 0.18% Carex squarrosa 3.36% Carex vulpinoidea 1.58% Echinochloa crusgalii 0.48% Eleocharis ovata (Eleocharis obtusa) 0.08% Eleocharis smallii 4.48% Elymus canadensis 2.24% Elymus virginicus 0.14% Euthamia graminifolia (Solidago graminifolia) 1.12% Glyceria striata 0.42% Iris virginica 0.28% Juncus effusus 0.07% Juncus tenuis 0.00% Juncus tenuis v. dudleyi 0.07% Juncus torreyi 1.12% Liatris spicata 0.28% Lobelia siphilitica 3.93% Lolium multiflorum 0.07% Ludwigia alternifolia 0.56% Lycopus species blend 0.56% Mondarda fistulosa 0.28% Panicum virgatum 0.14% Penstemon digitalis 0.42% Physostegia virginiana 0.56% Pycnanthemum virginianum 8.98% Schizachyrium scoparium (Adropogon scoparius) 1.12% Scirpus atrovirens 2.90% Scirpus cyperinus 0.28% Solidago riddelii 8.97% Sorghastrum nutans 1.12% Spartina pectinata 0.28% Thalictrum dasycarpum 0.56% Vernonia fasciculata 0.28% Zizia aurea 100.00%

MIX B

5.84% Agropyron trachycaulum 0.73% Aster laevis 1.46% Aster novae-angliae 8.75% Bouteloua curtipendula 1.46% Chamaecrista fascilulata (Cassia fascilulata) 5.84% Coreopsis lanceloata 2.93% Dalea purpurea 3.65% Desmanthus illnoensis 3.65% Echinacea purpurea 11.68% Elymus canadensis 11.68% elymus virginicus 1.46% Heliopsis helianthoides 0.73% Juncus tenuis 1.46% Liatris spicata 1.46% Lupinus perennis 0.37% Mondard fistulosa 1.10% Penstemon digitalis 3.65% Ratibida pinnata 4.38% Rudbeckia hirta 26.27% Schizachyrium scoparium 0.73% Solidago rigida 0.73% Verbena stricta	0.73% Ast 1.46% Ast 8.75% Bou 1.46% Cha 5.84% Cor 2.93% Dal	er laevis er novae-angliae uteloua curtipendula amaecrista fascilulata (Cassia fascilulata)
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	RECOMMENDED FOR APPROVAL		ENGINEER	05/22/2012 DATE	
	DESIGNED:	BS	DRAWN:	BS	
	CHECKED:	GC	CHECKED:	MF	

	HORIZONTAL SCALE	BRIDGE FILE
INDIANA DEPARTMENT OF TRANSPORTATION	N/A	
	VERTICAL SCALE	DESIGNATION
	N/A	1006017
	SURVEY BOOK	SHEETS
NORTH SIDE TRAIL PROJECT		23 of 41
LANDSCAPING DETAILS	CONTRACT	PROJECT

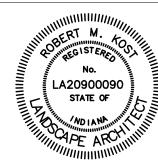DESIGNED:_

CHECKED:

05/22/2012

CHECKED:

EROSION CONTROL LINE "A" STA. 10+00 to 42+50

PHONE: 219.513.2500 9200 CALUMET AVENUE SUITE N501 MUNSTER, IN 46321

VERTICAL SCALE

1" = 5'

SURVEY BOOK

CONTRACT

R-35164


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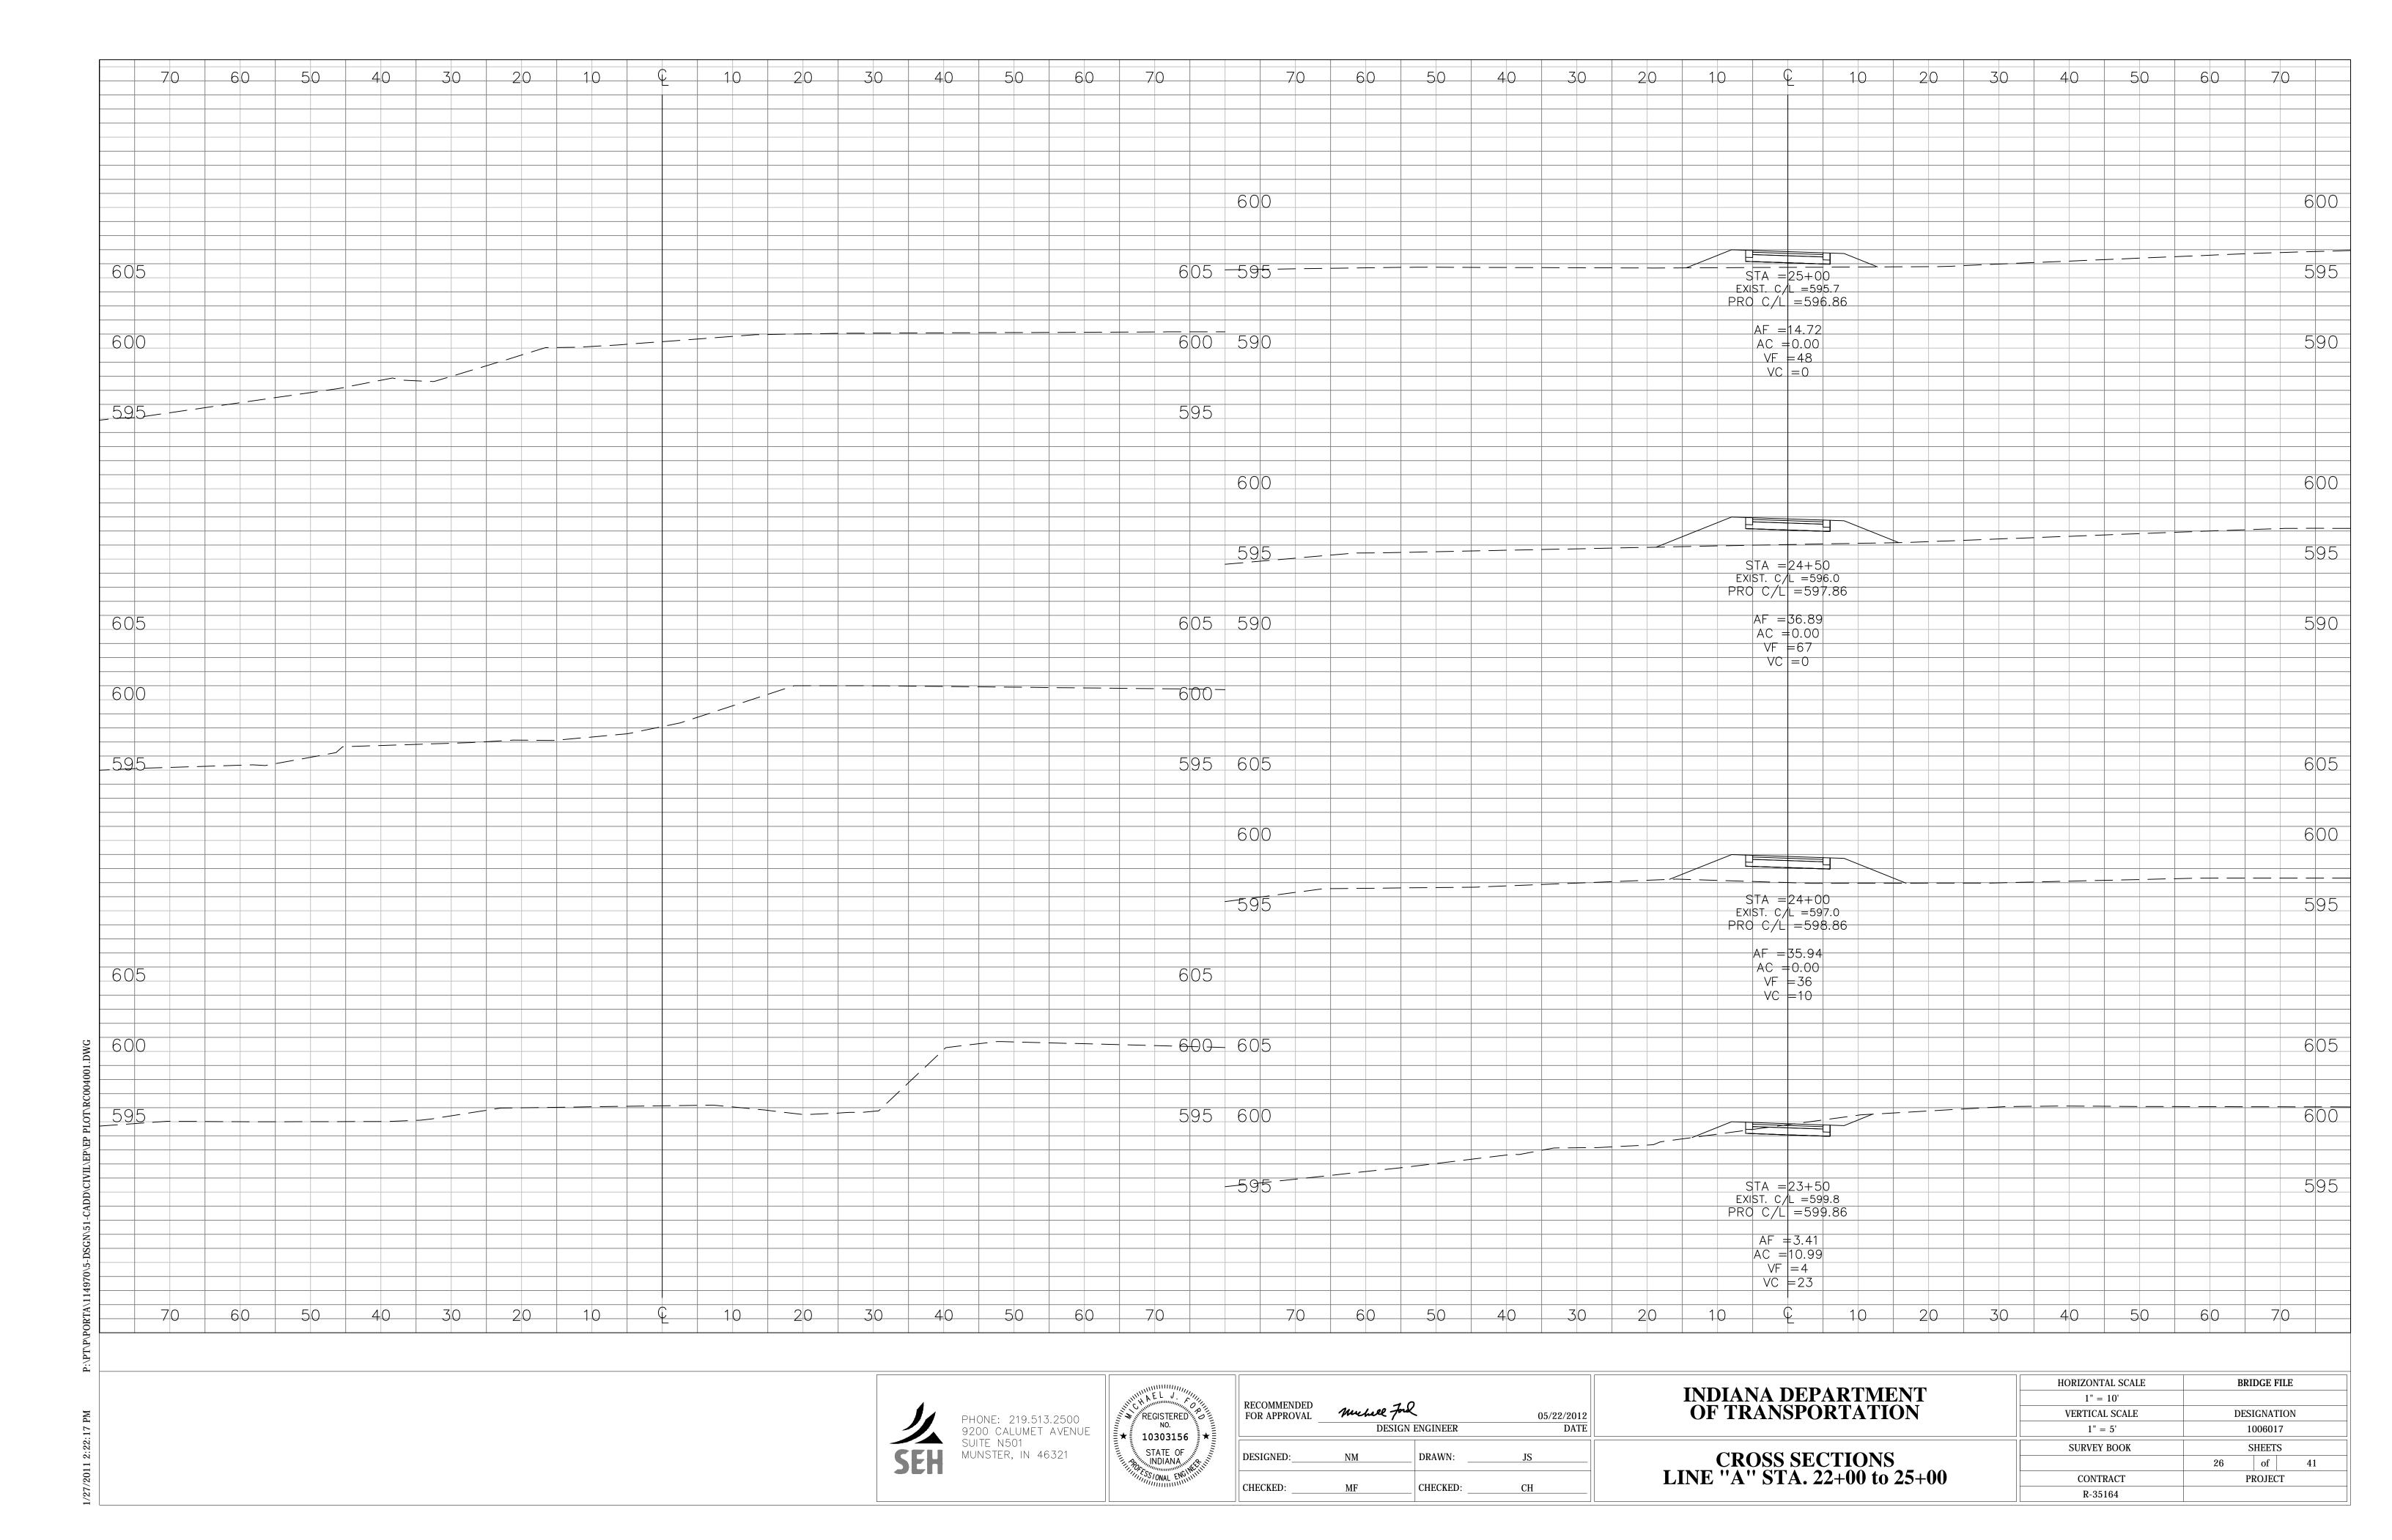
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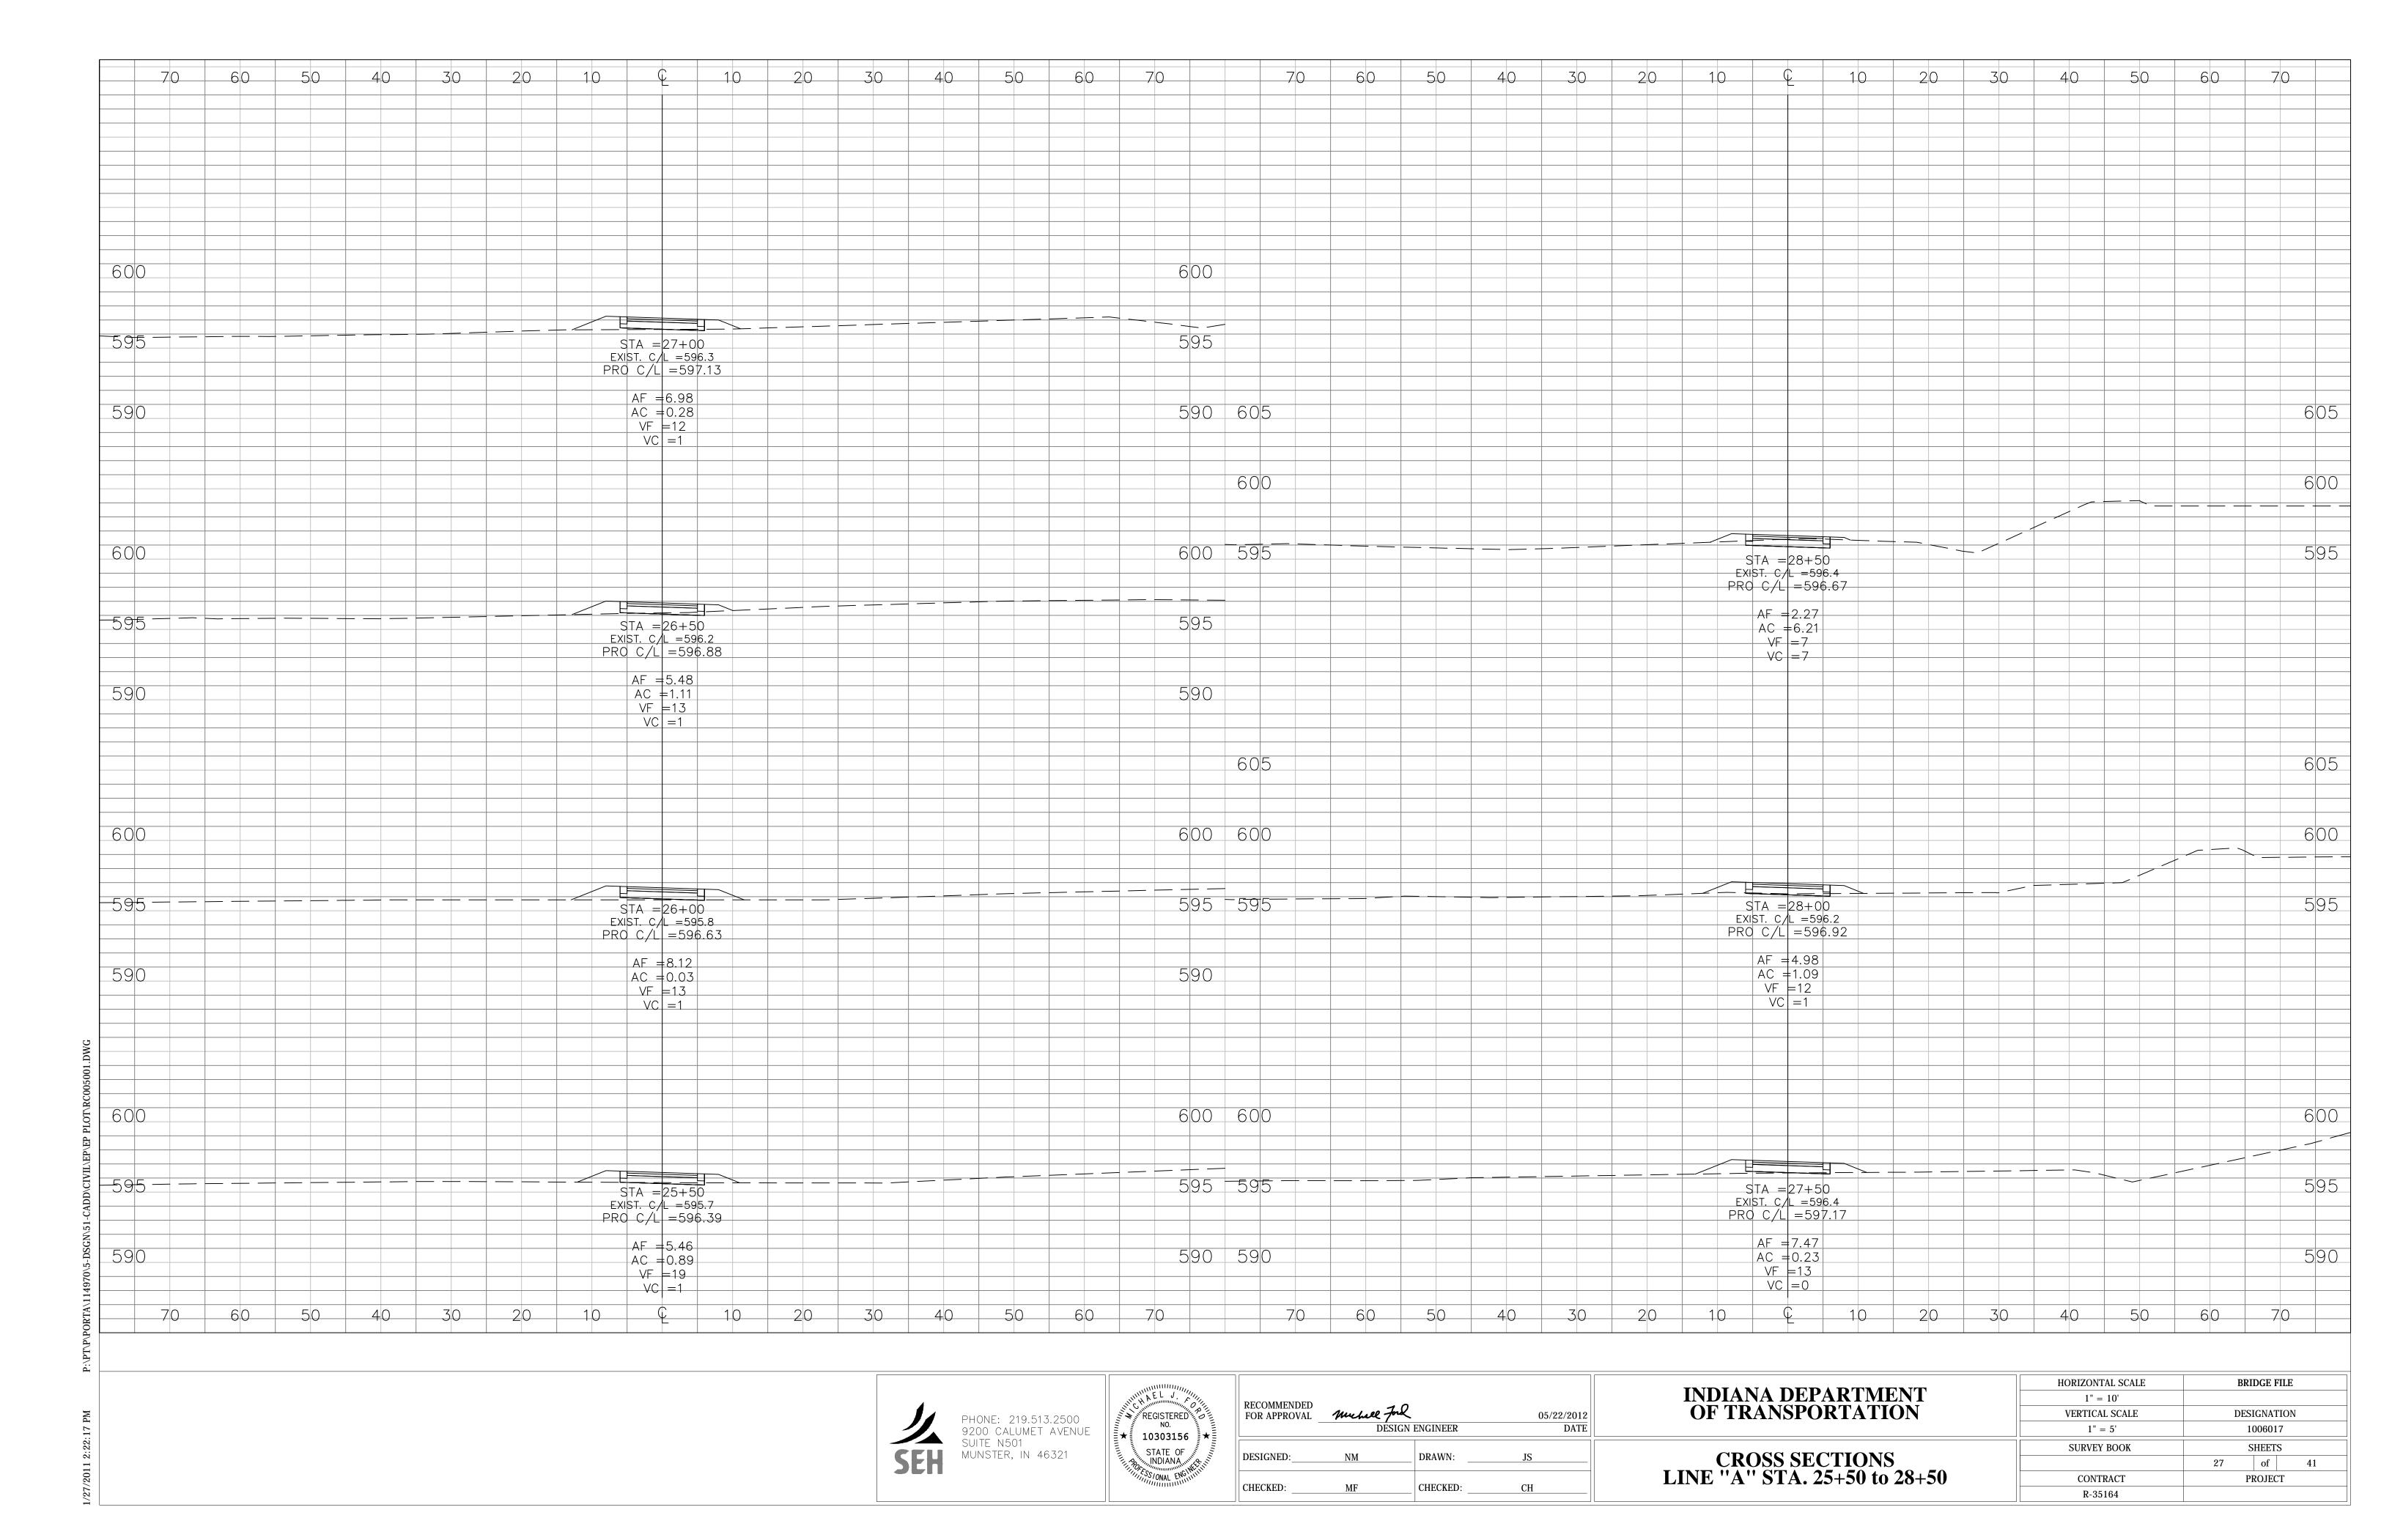
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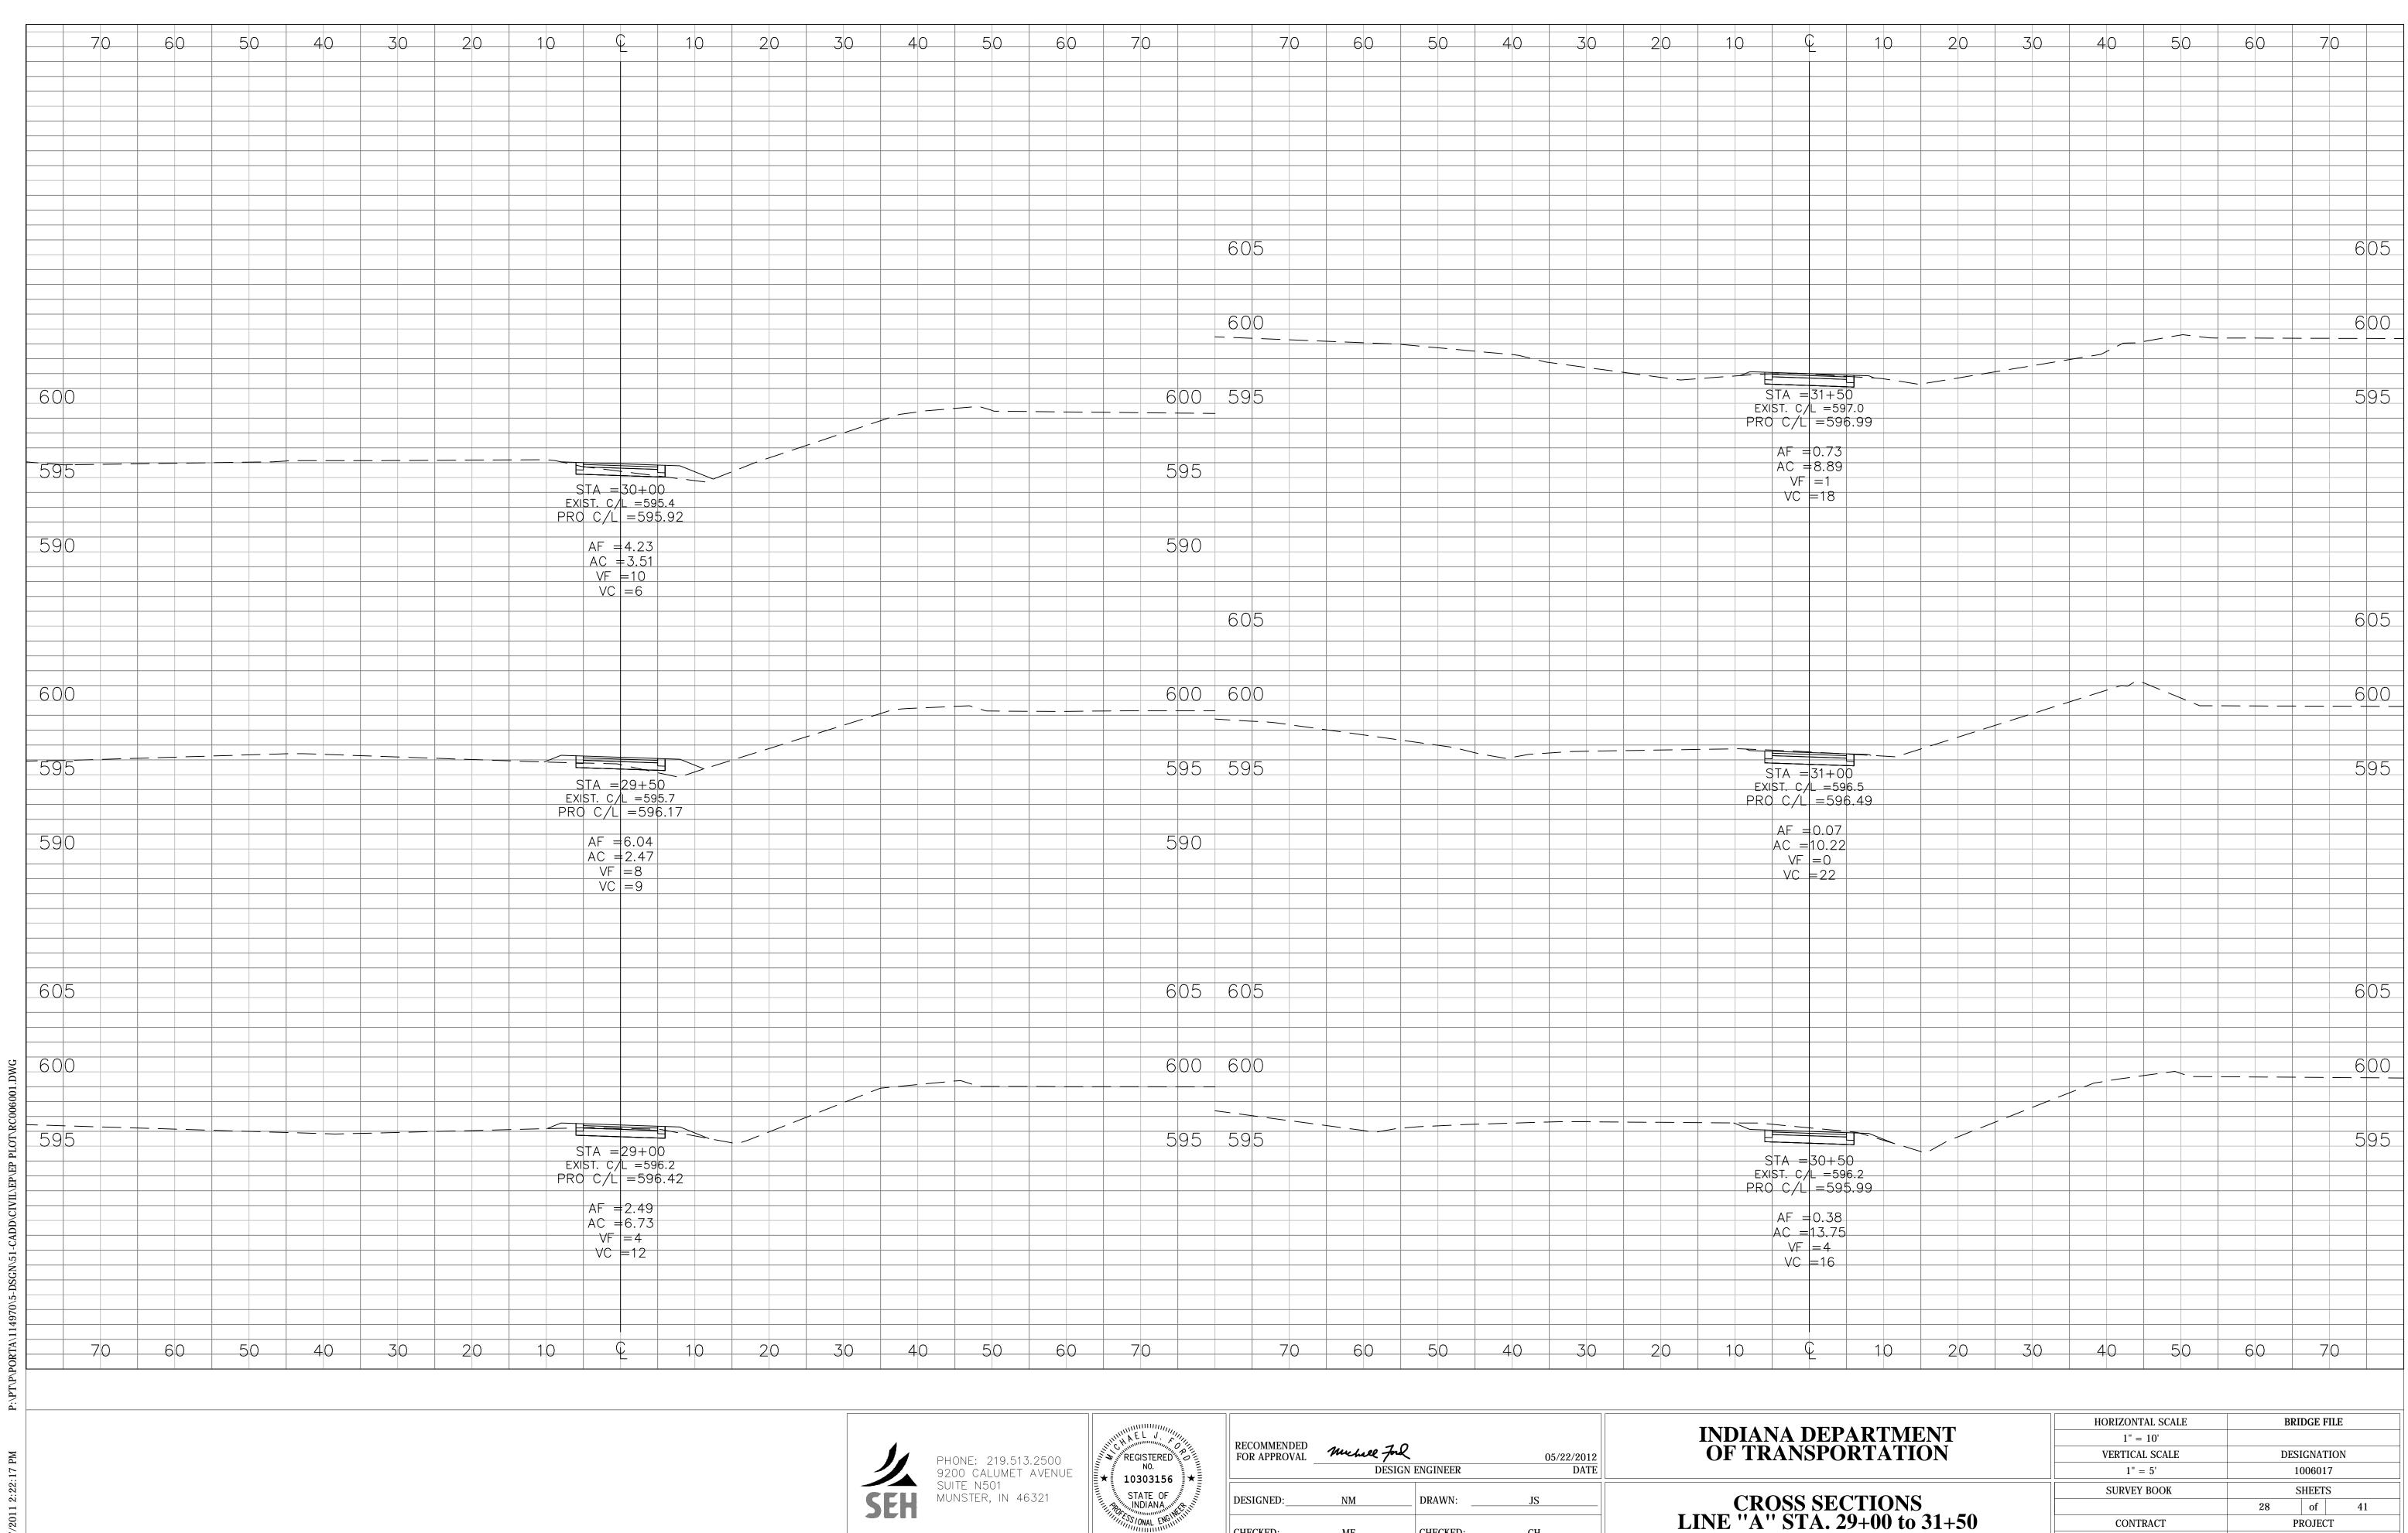
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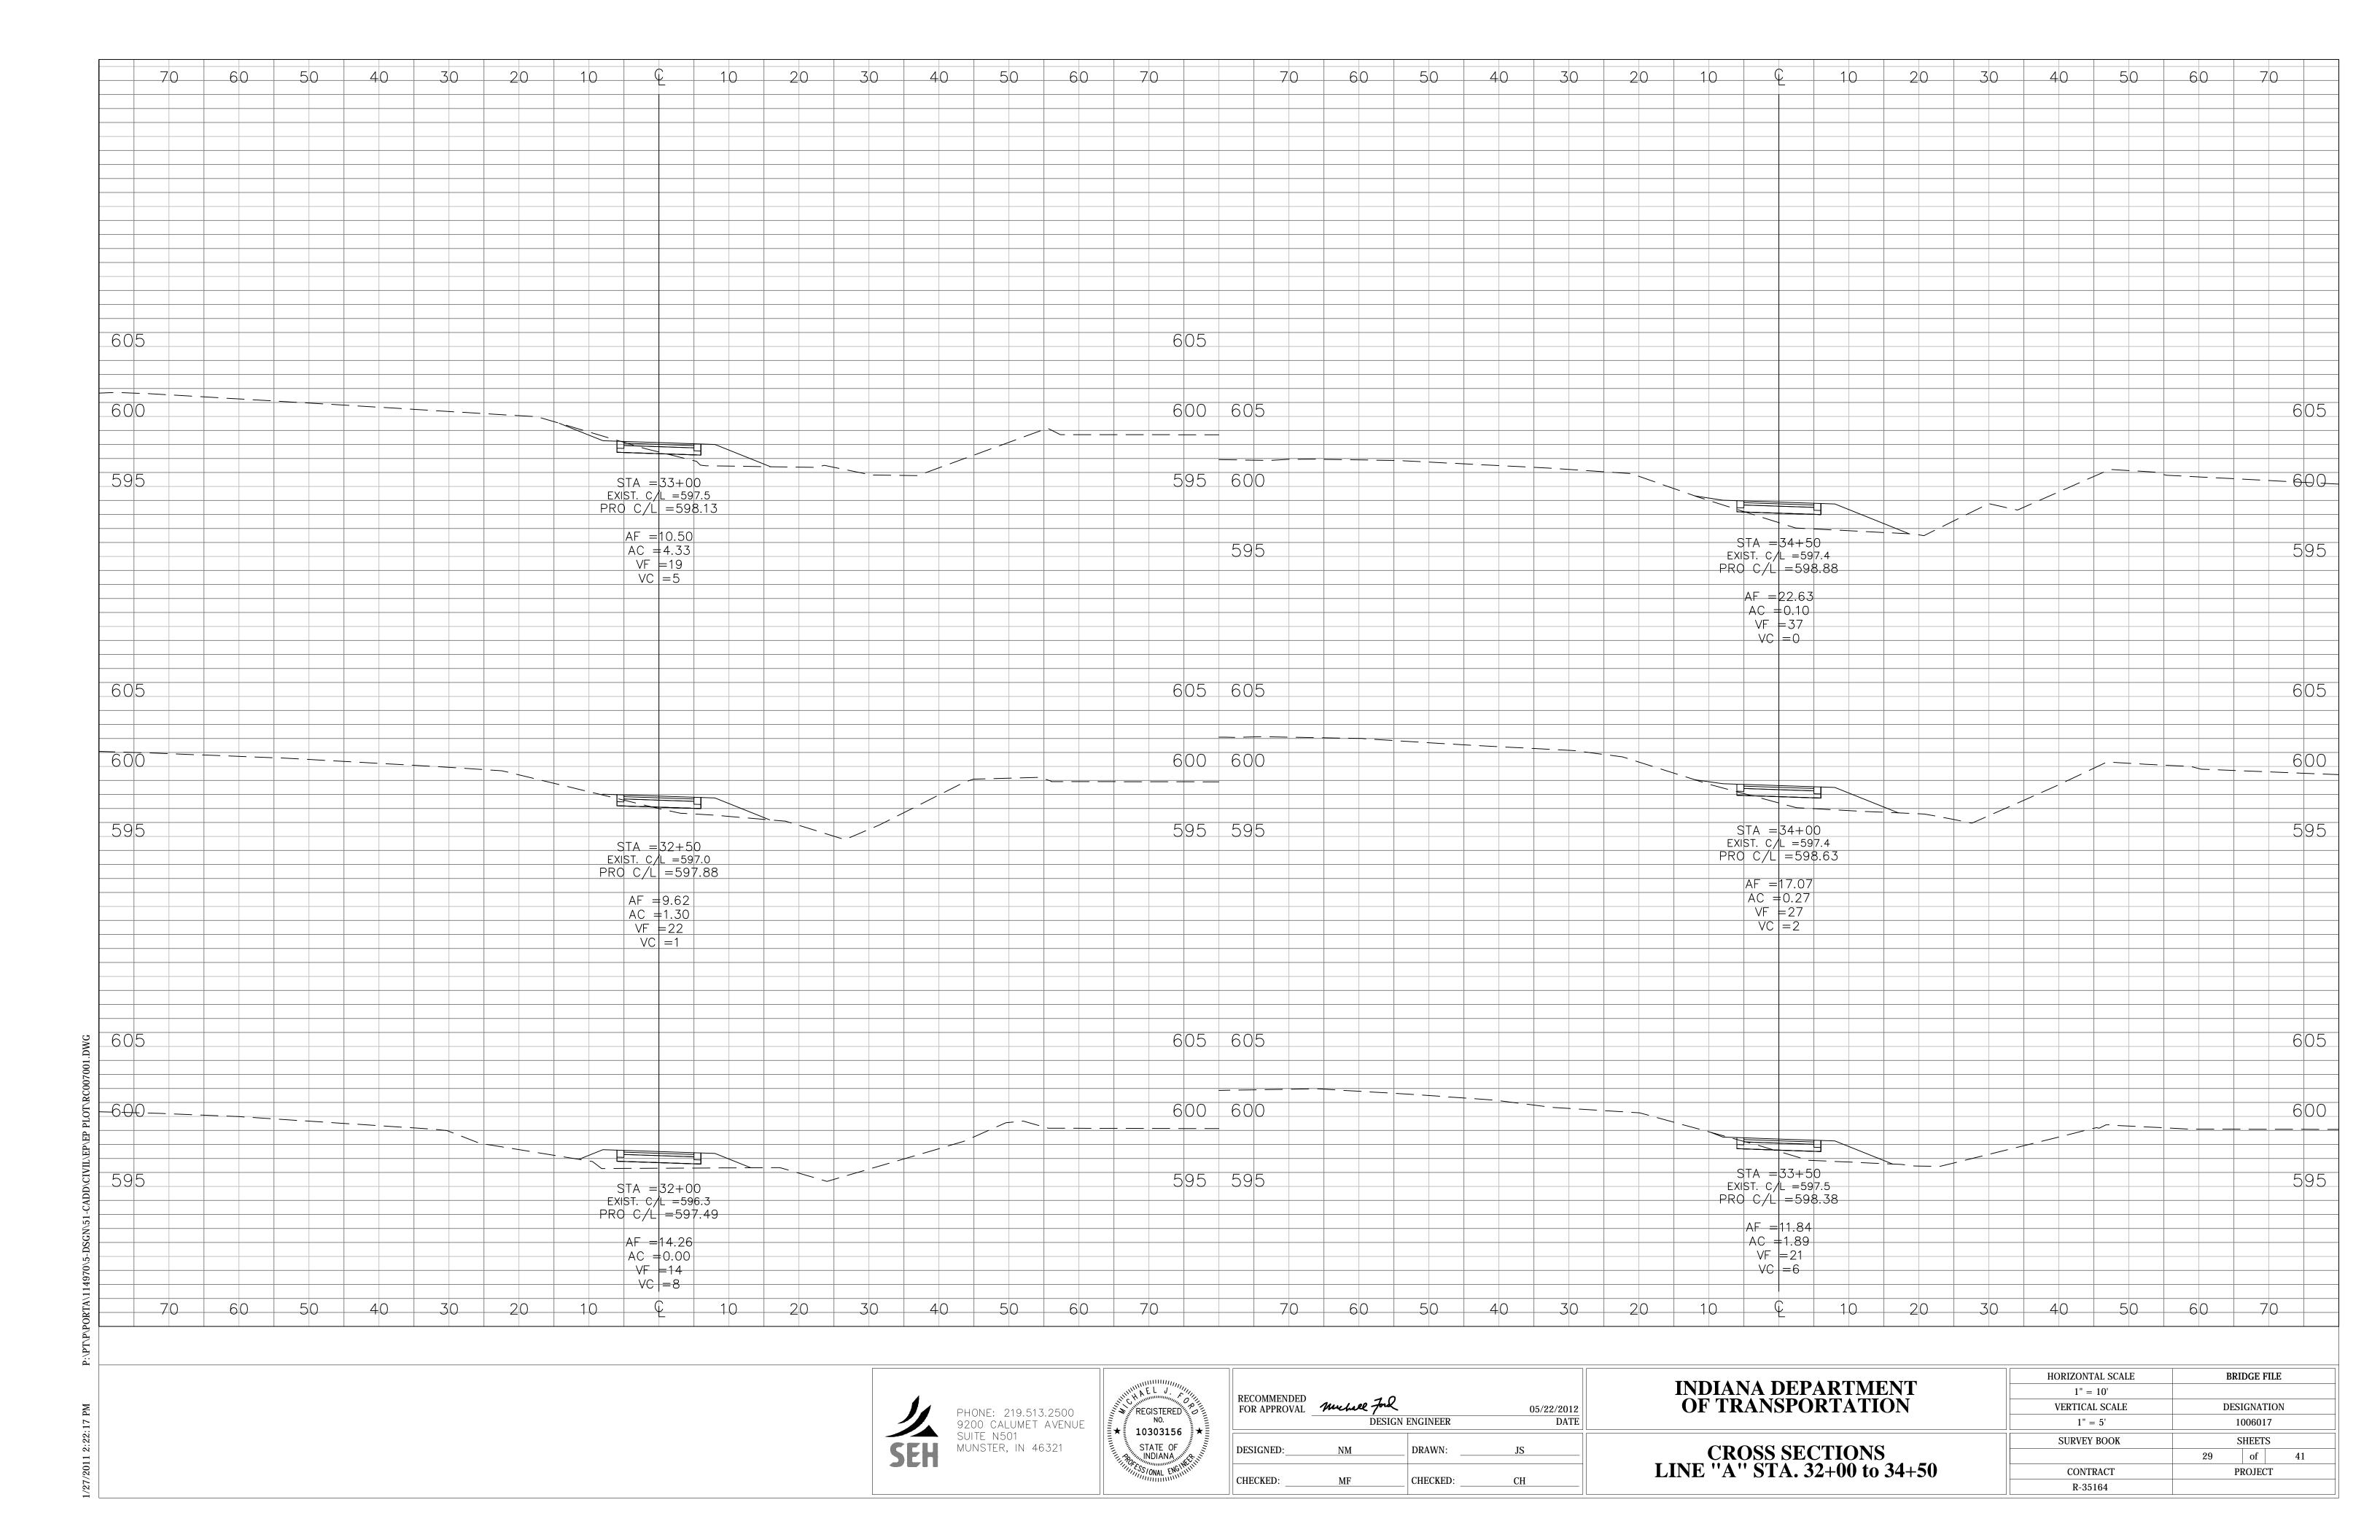












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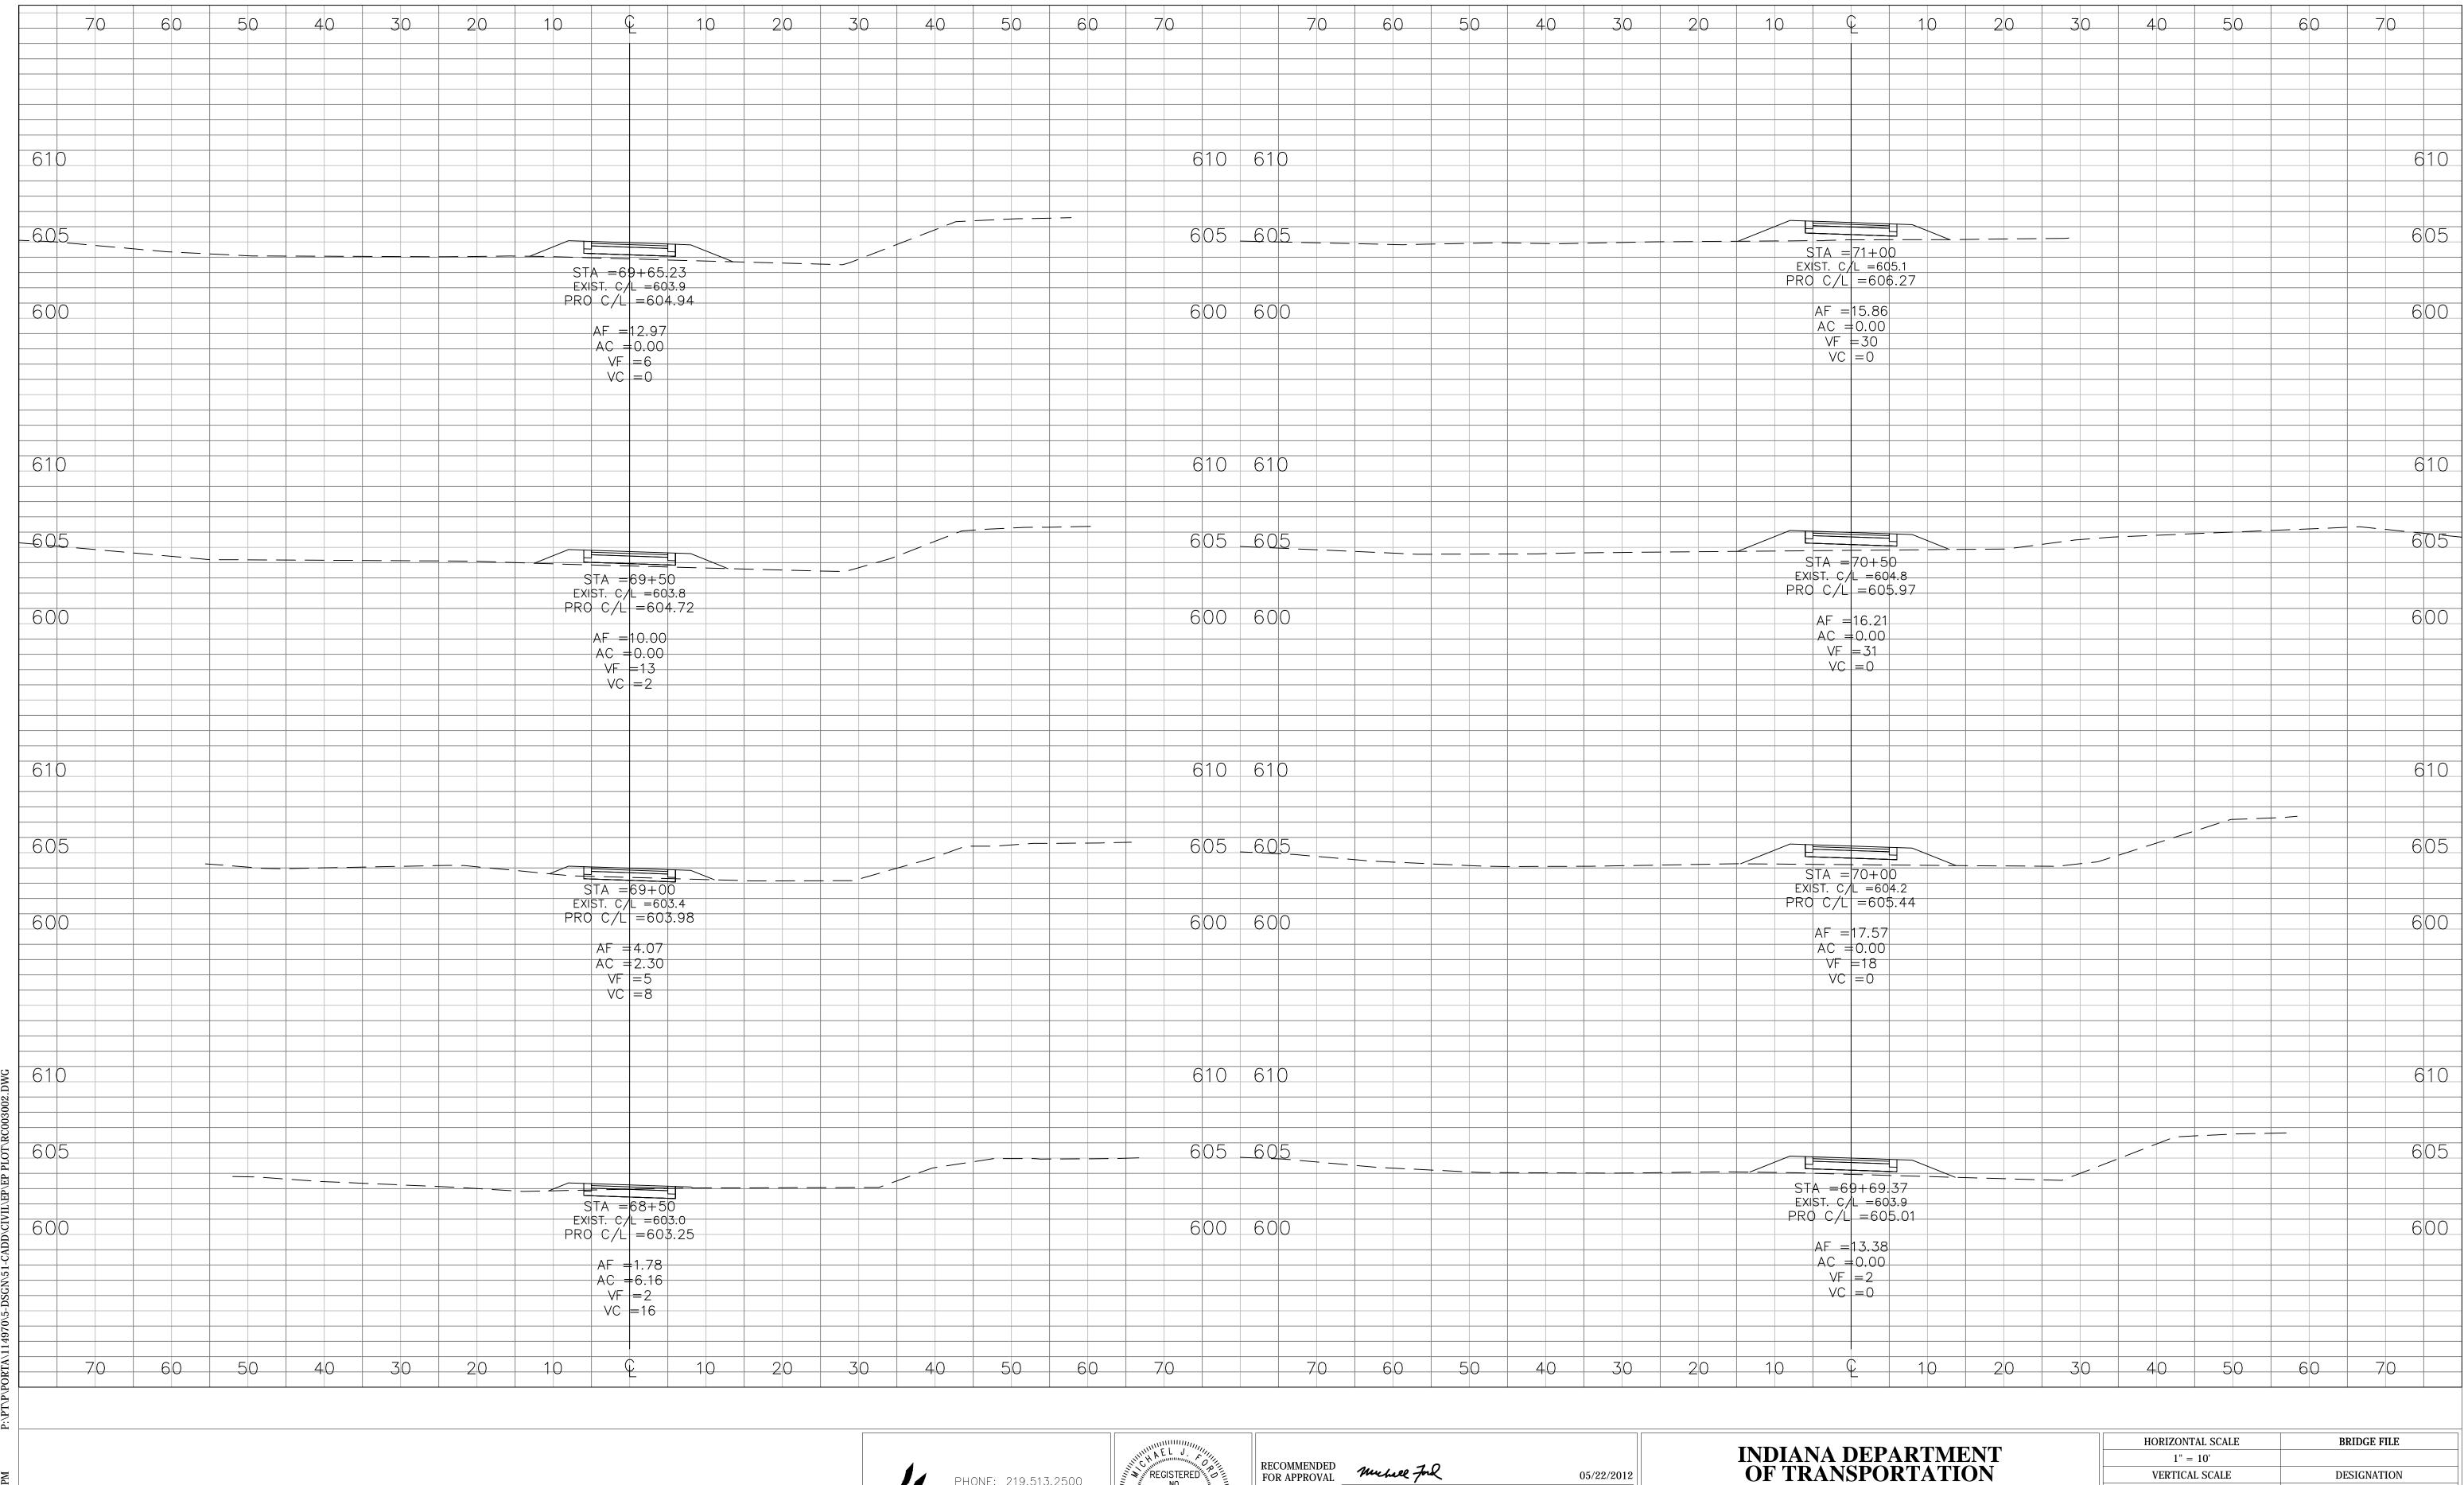


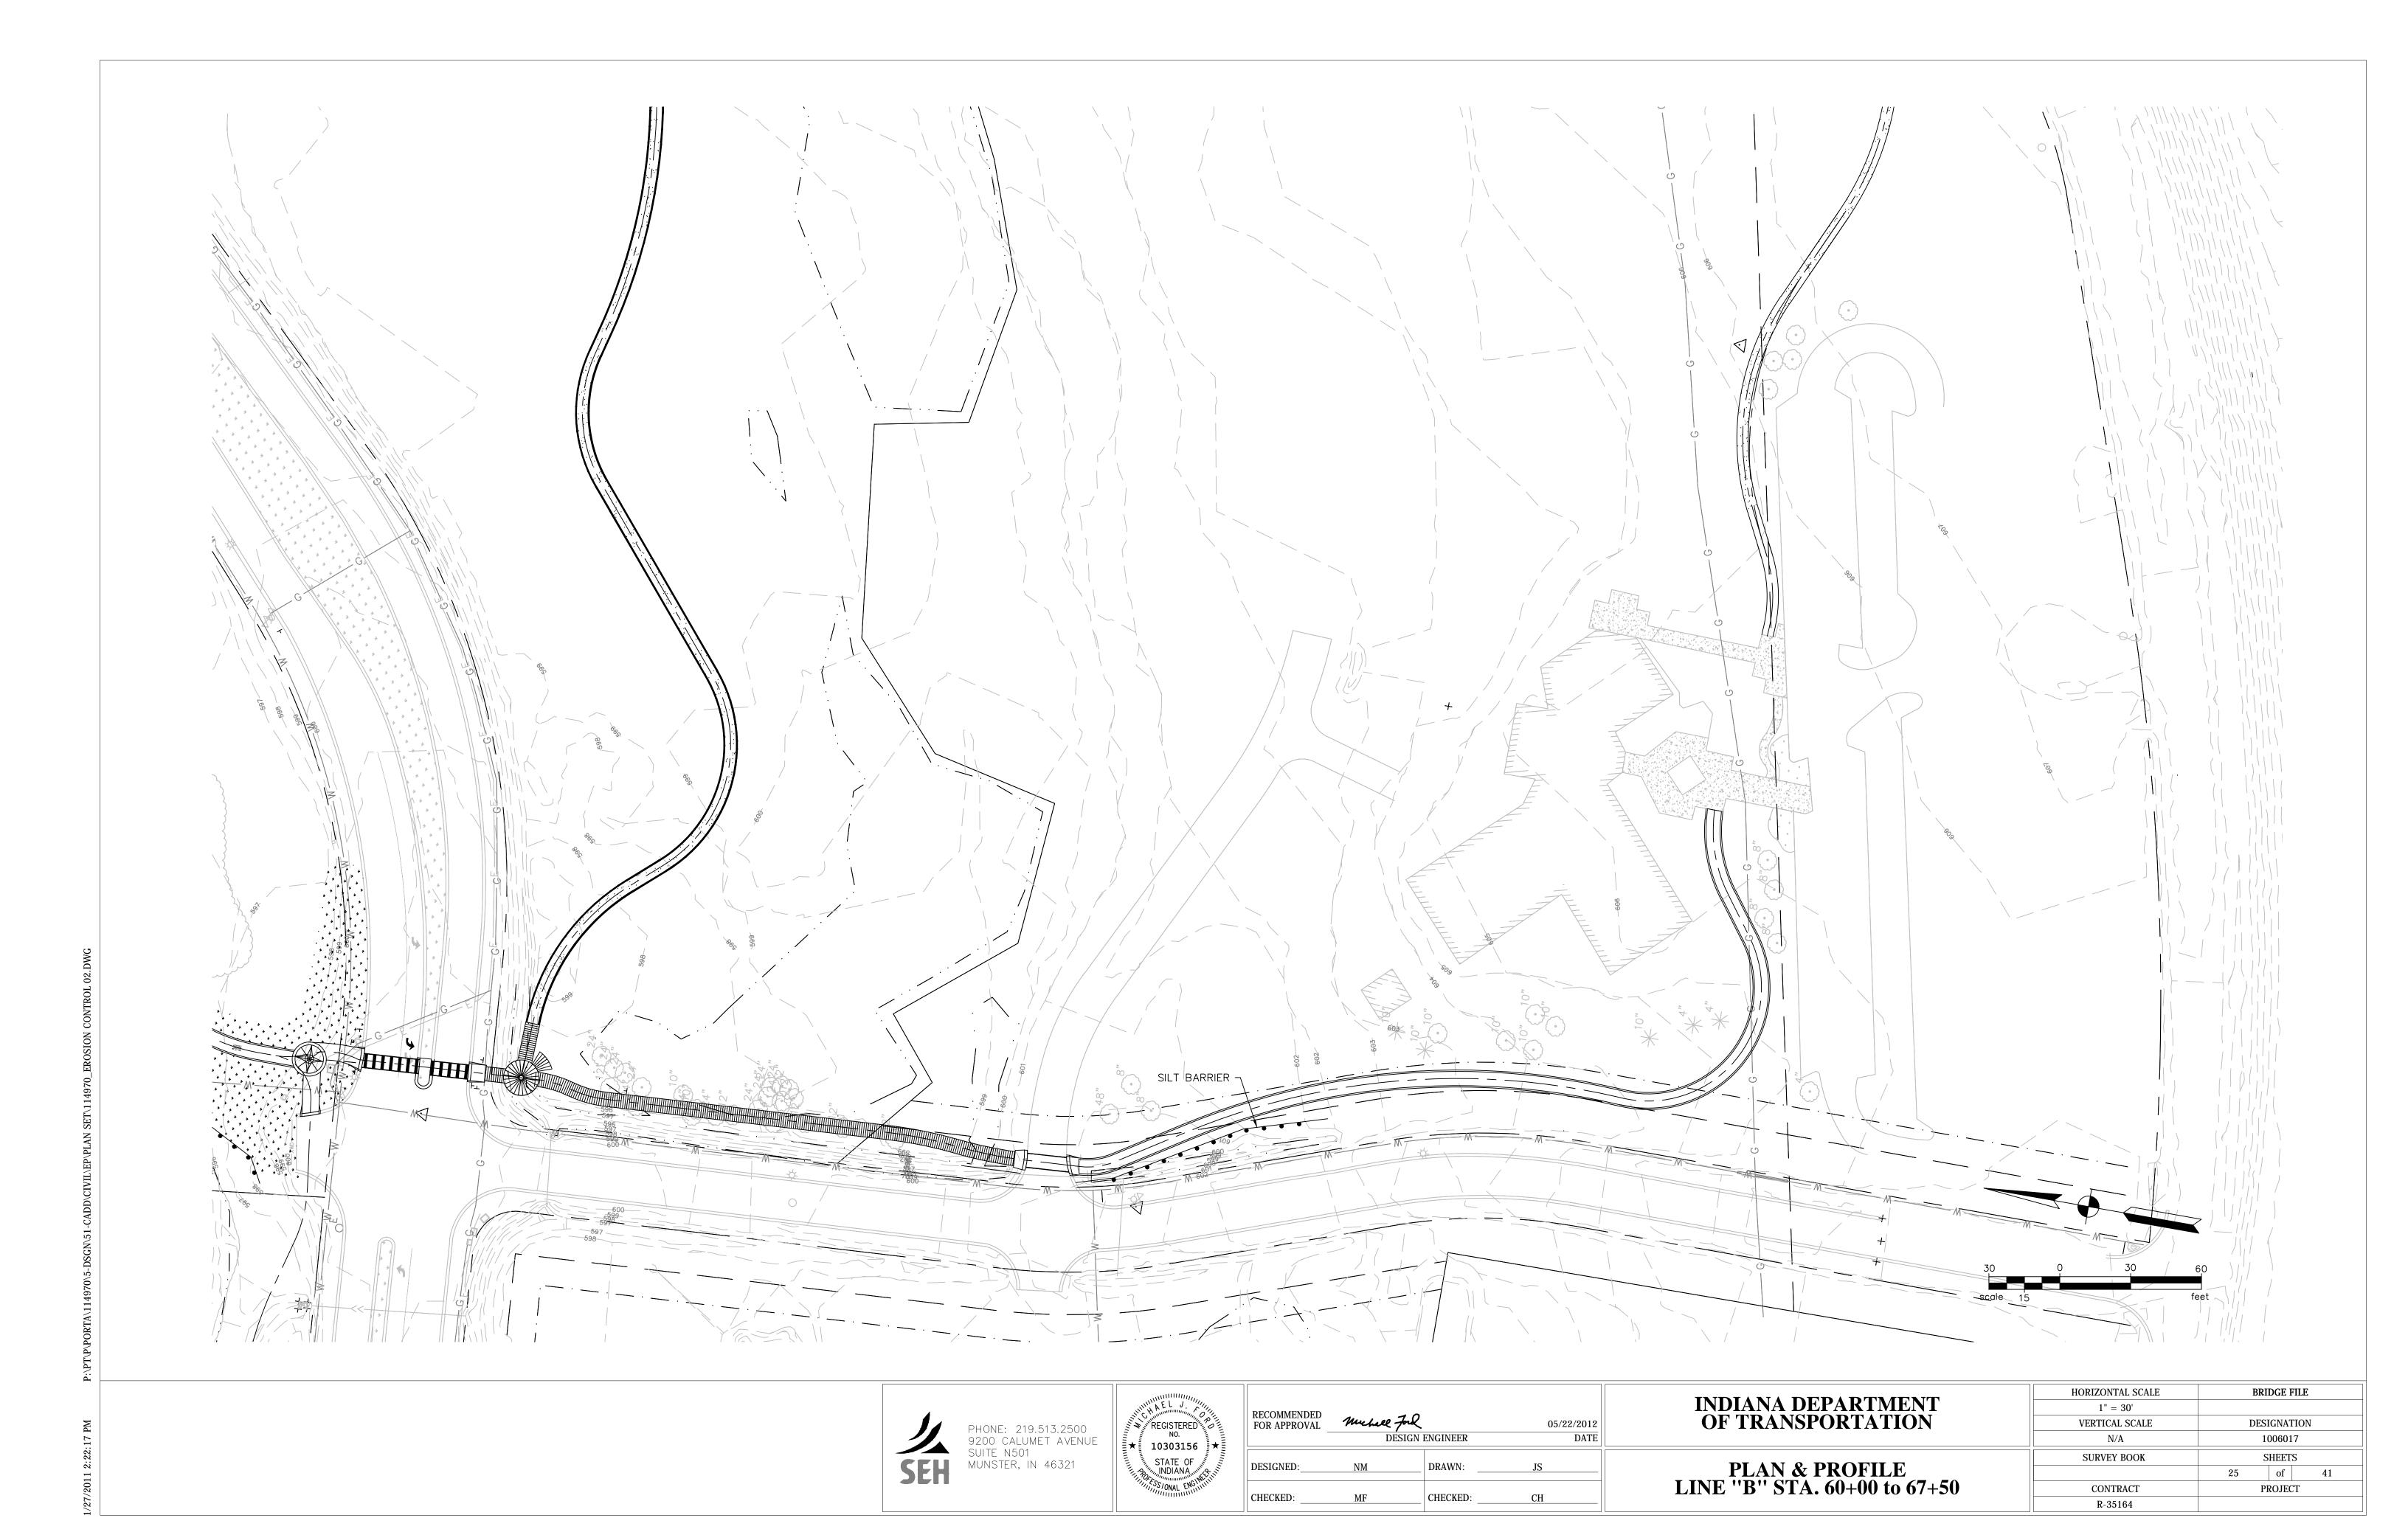

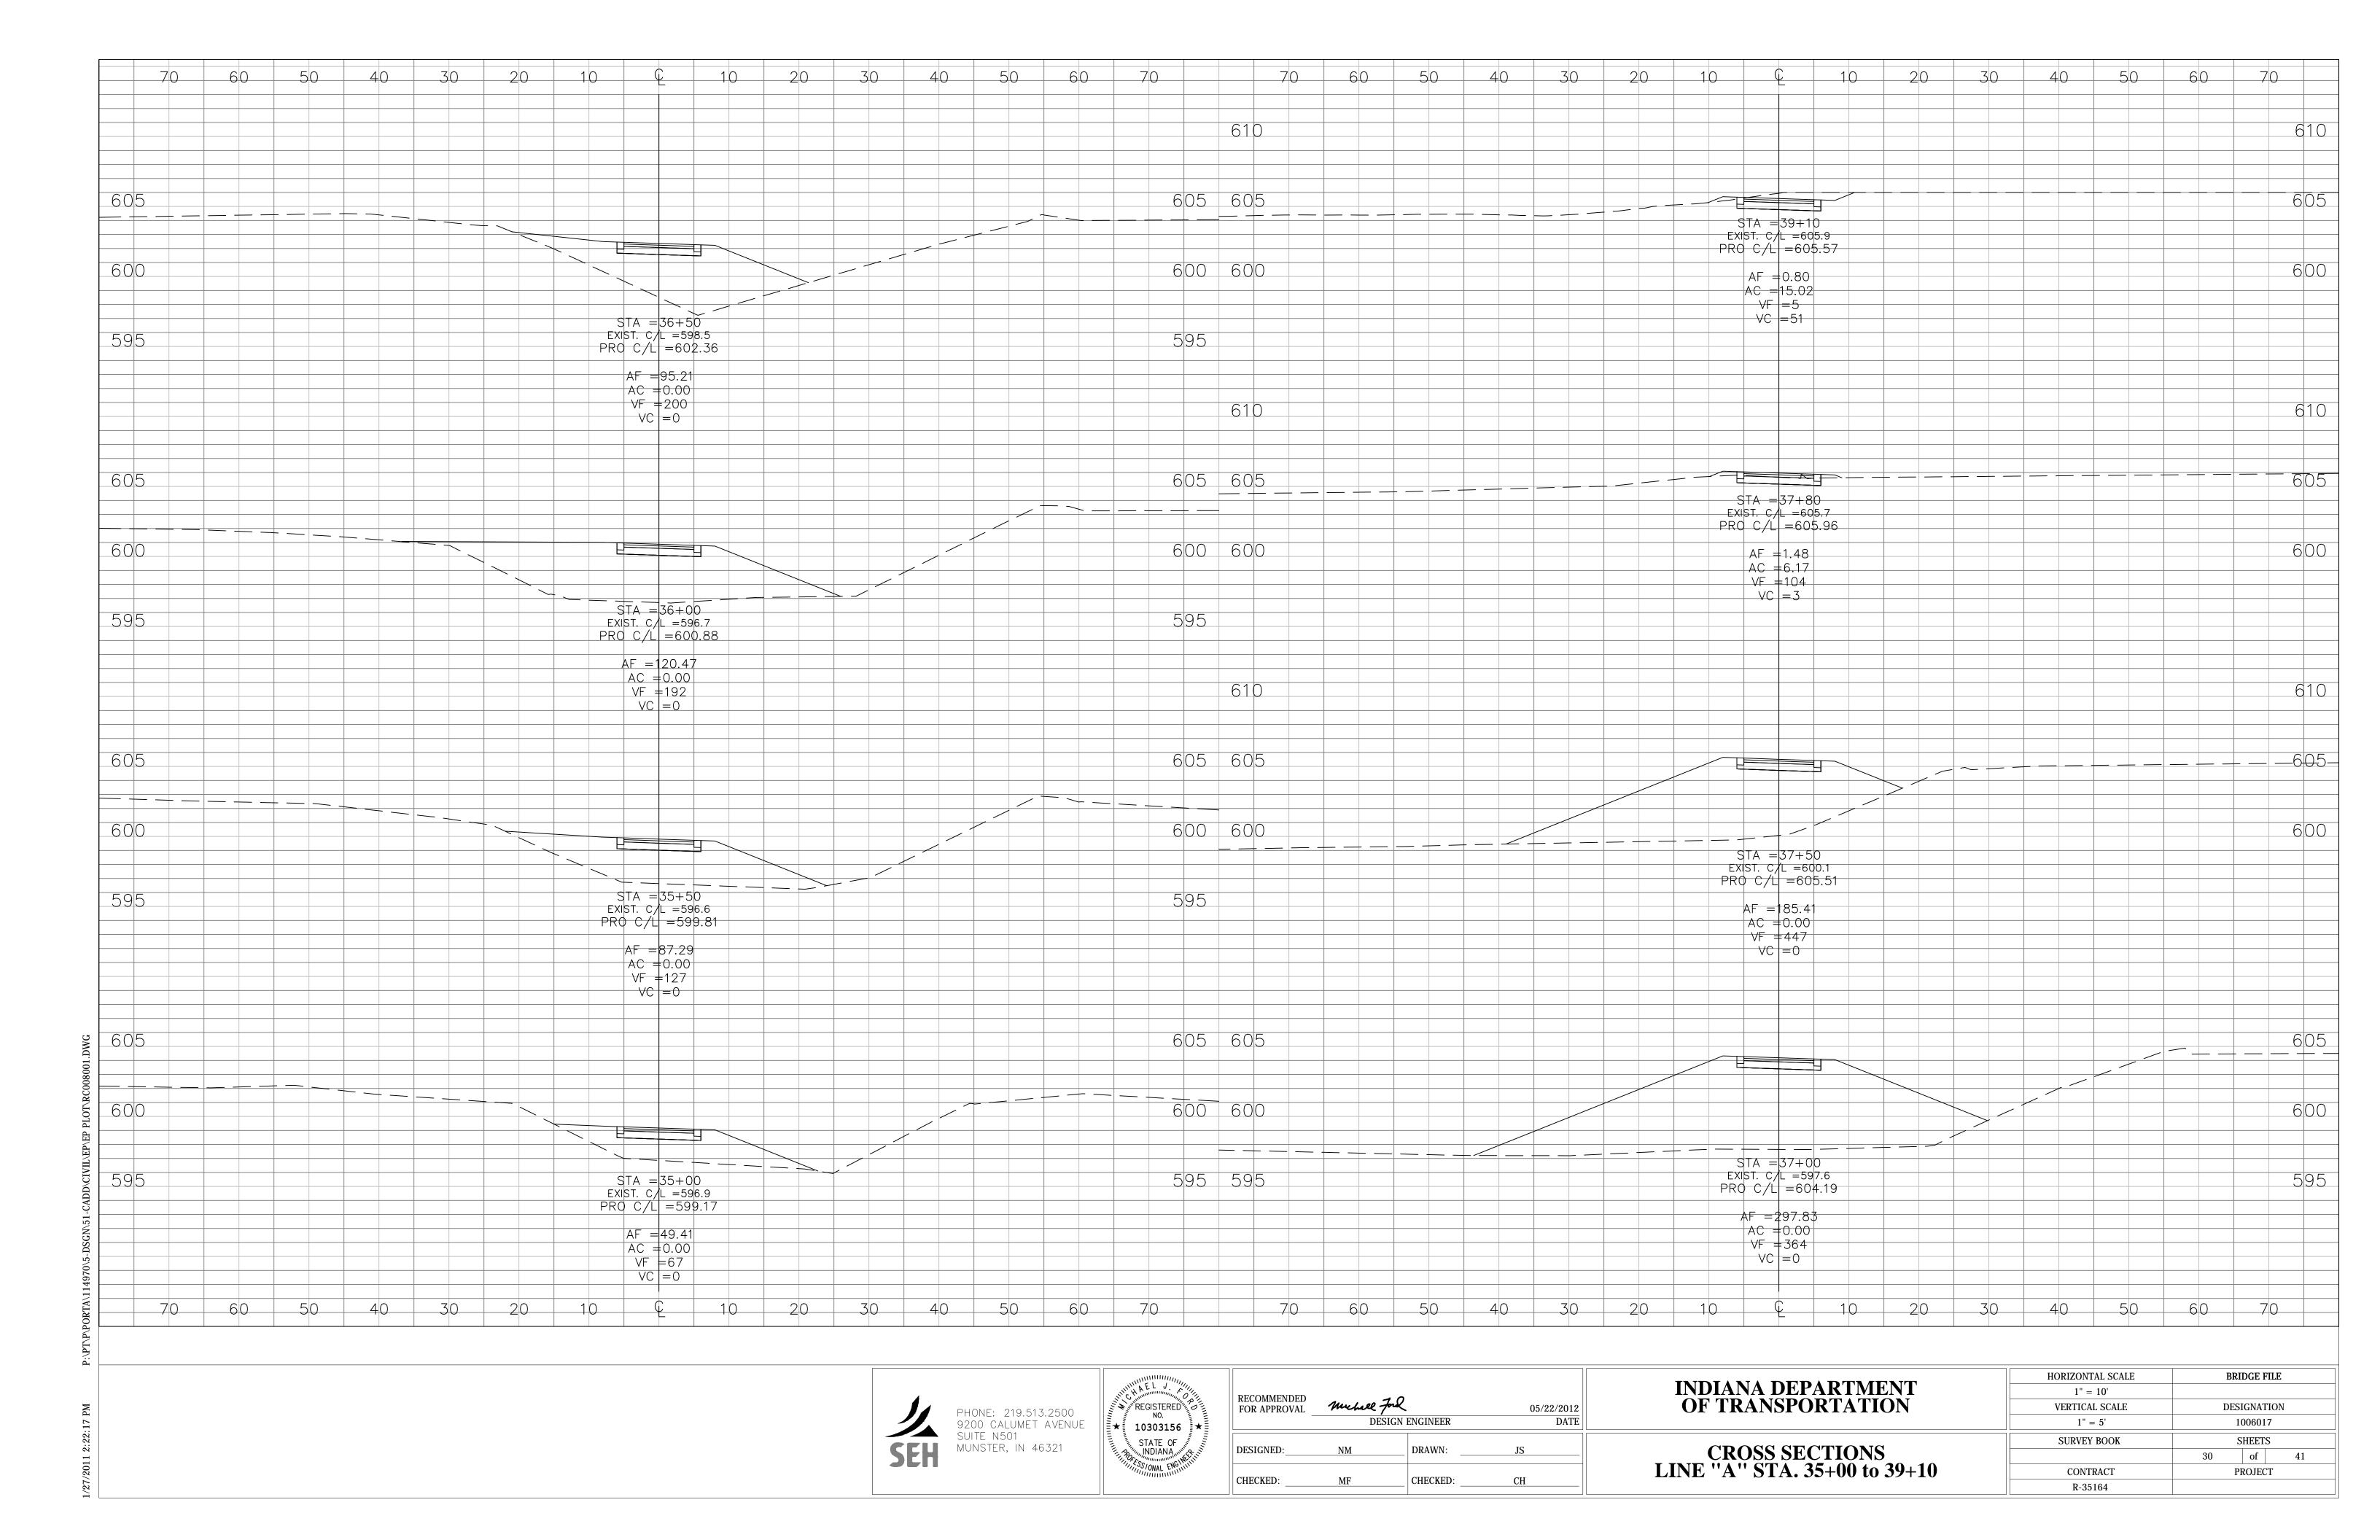

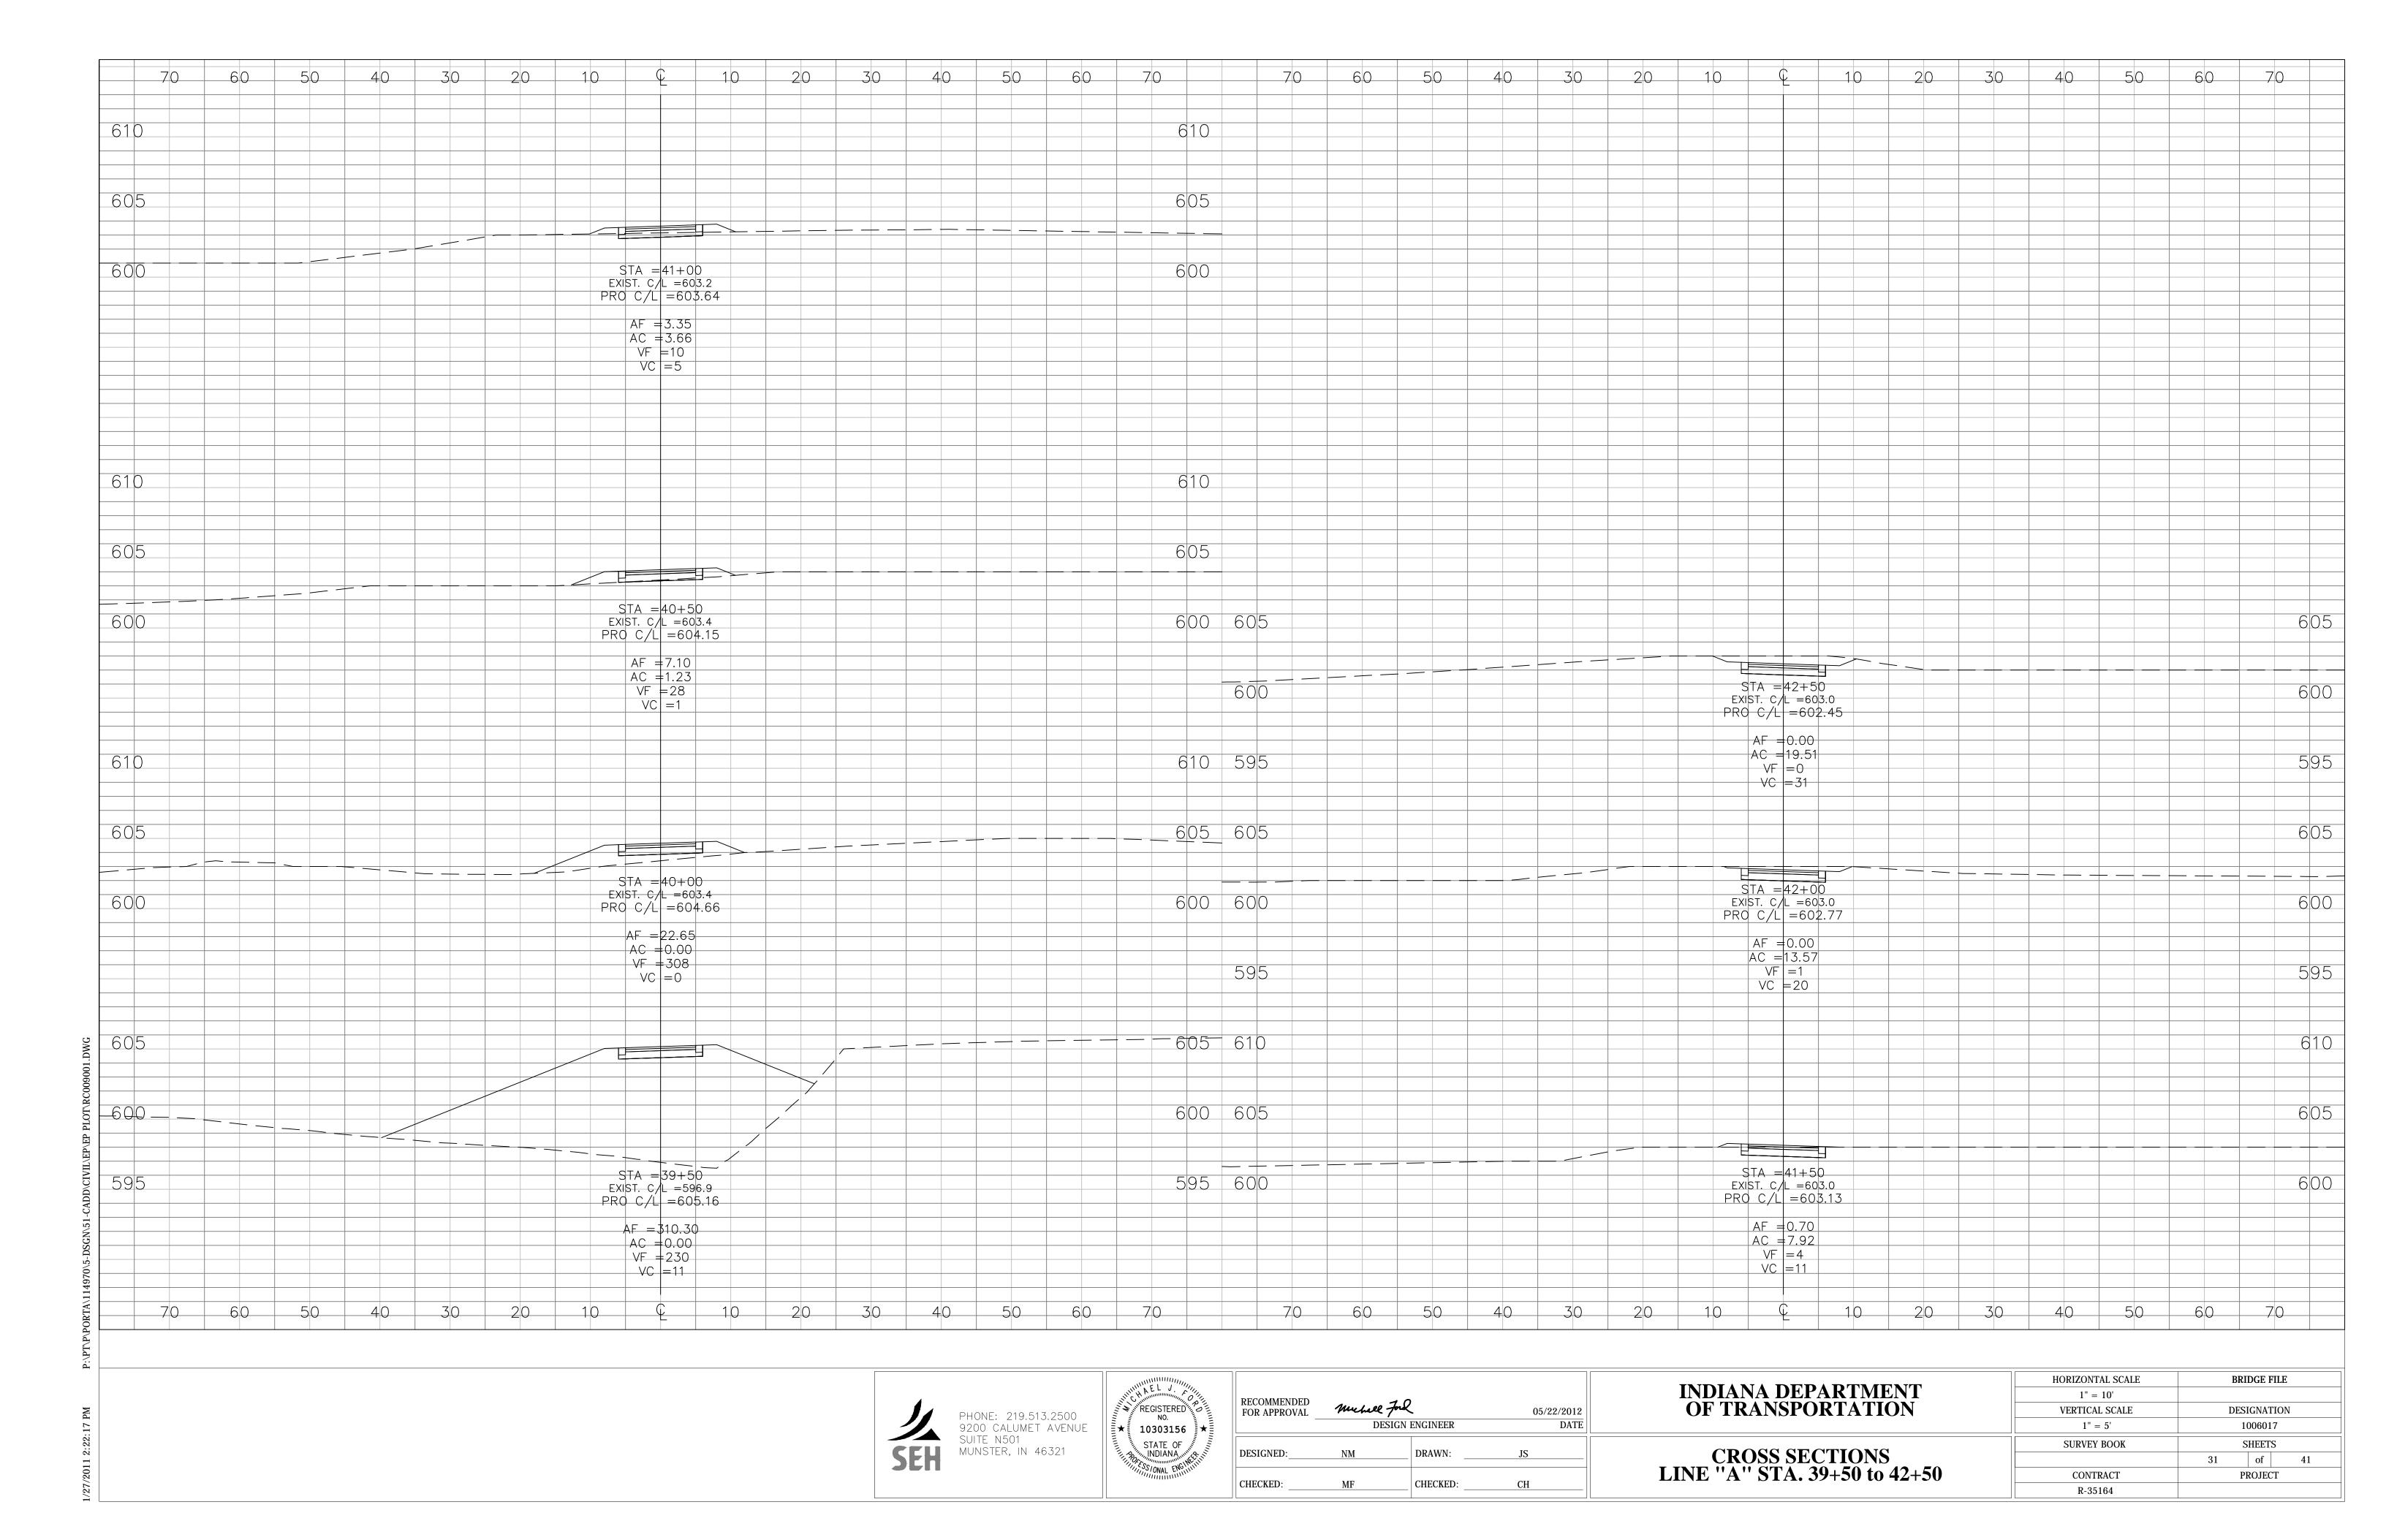

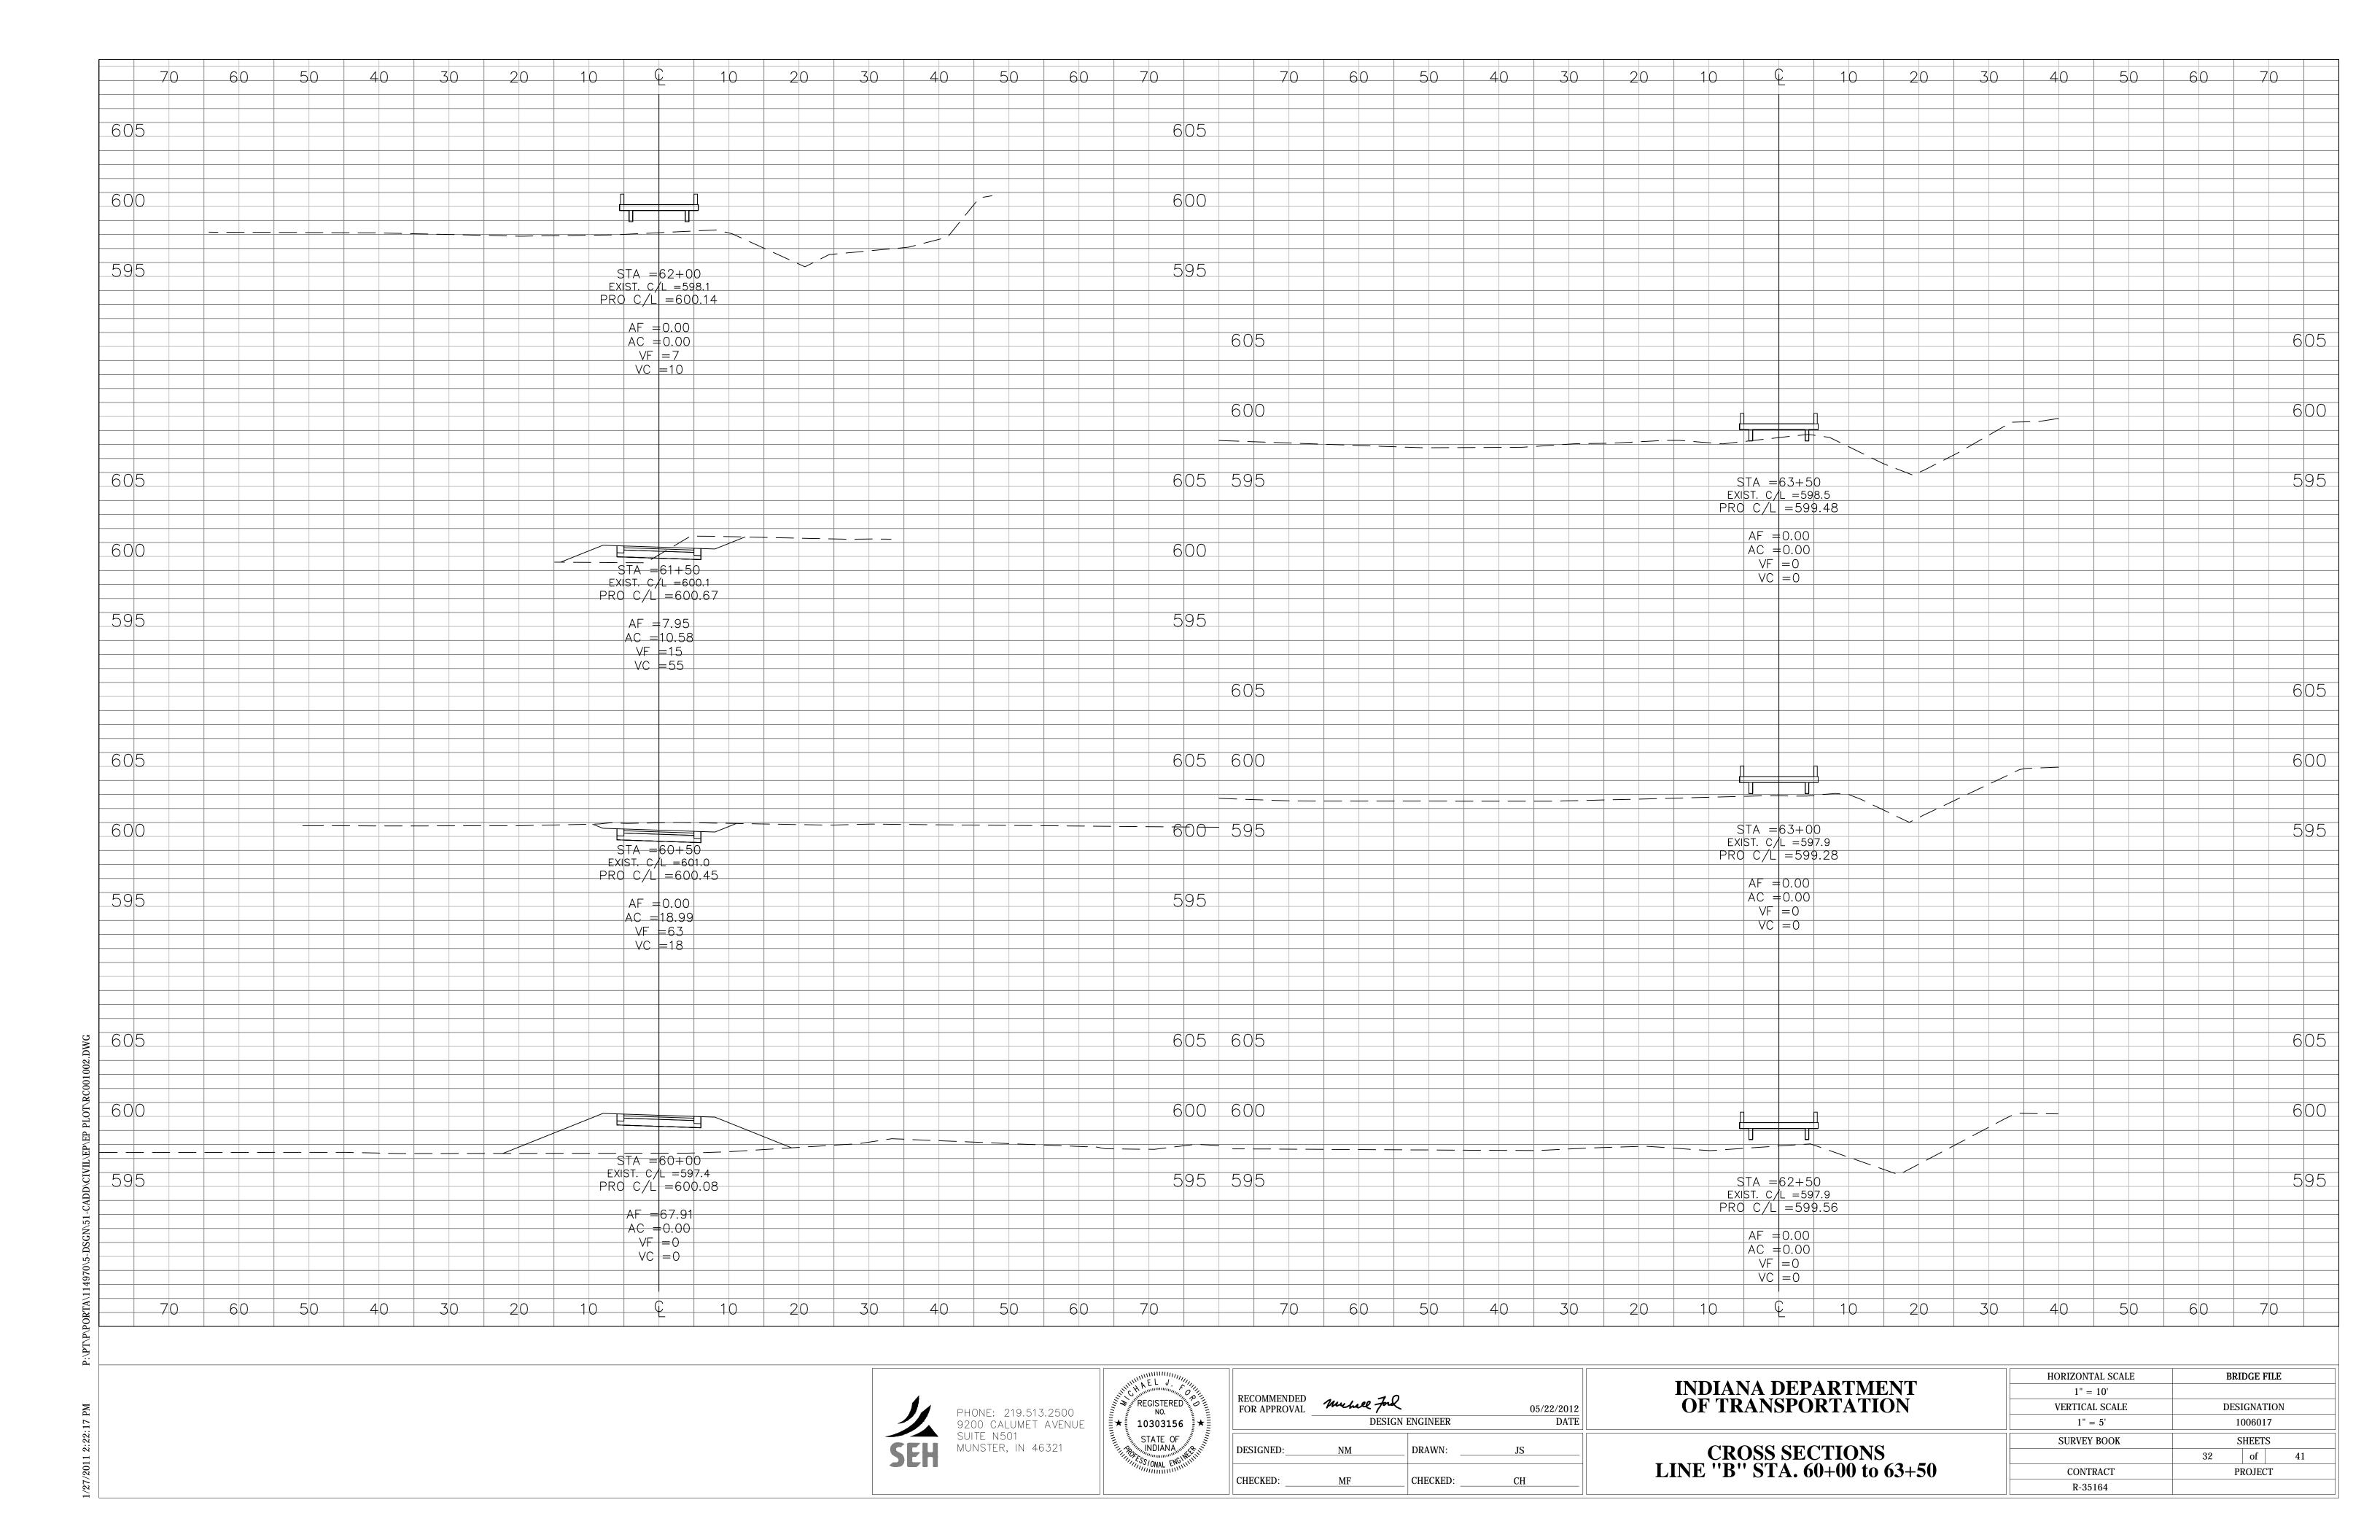

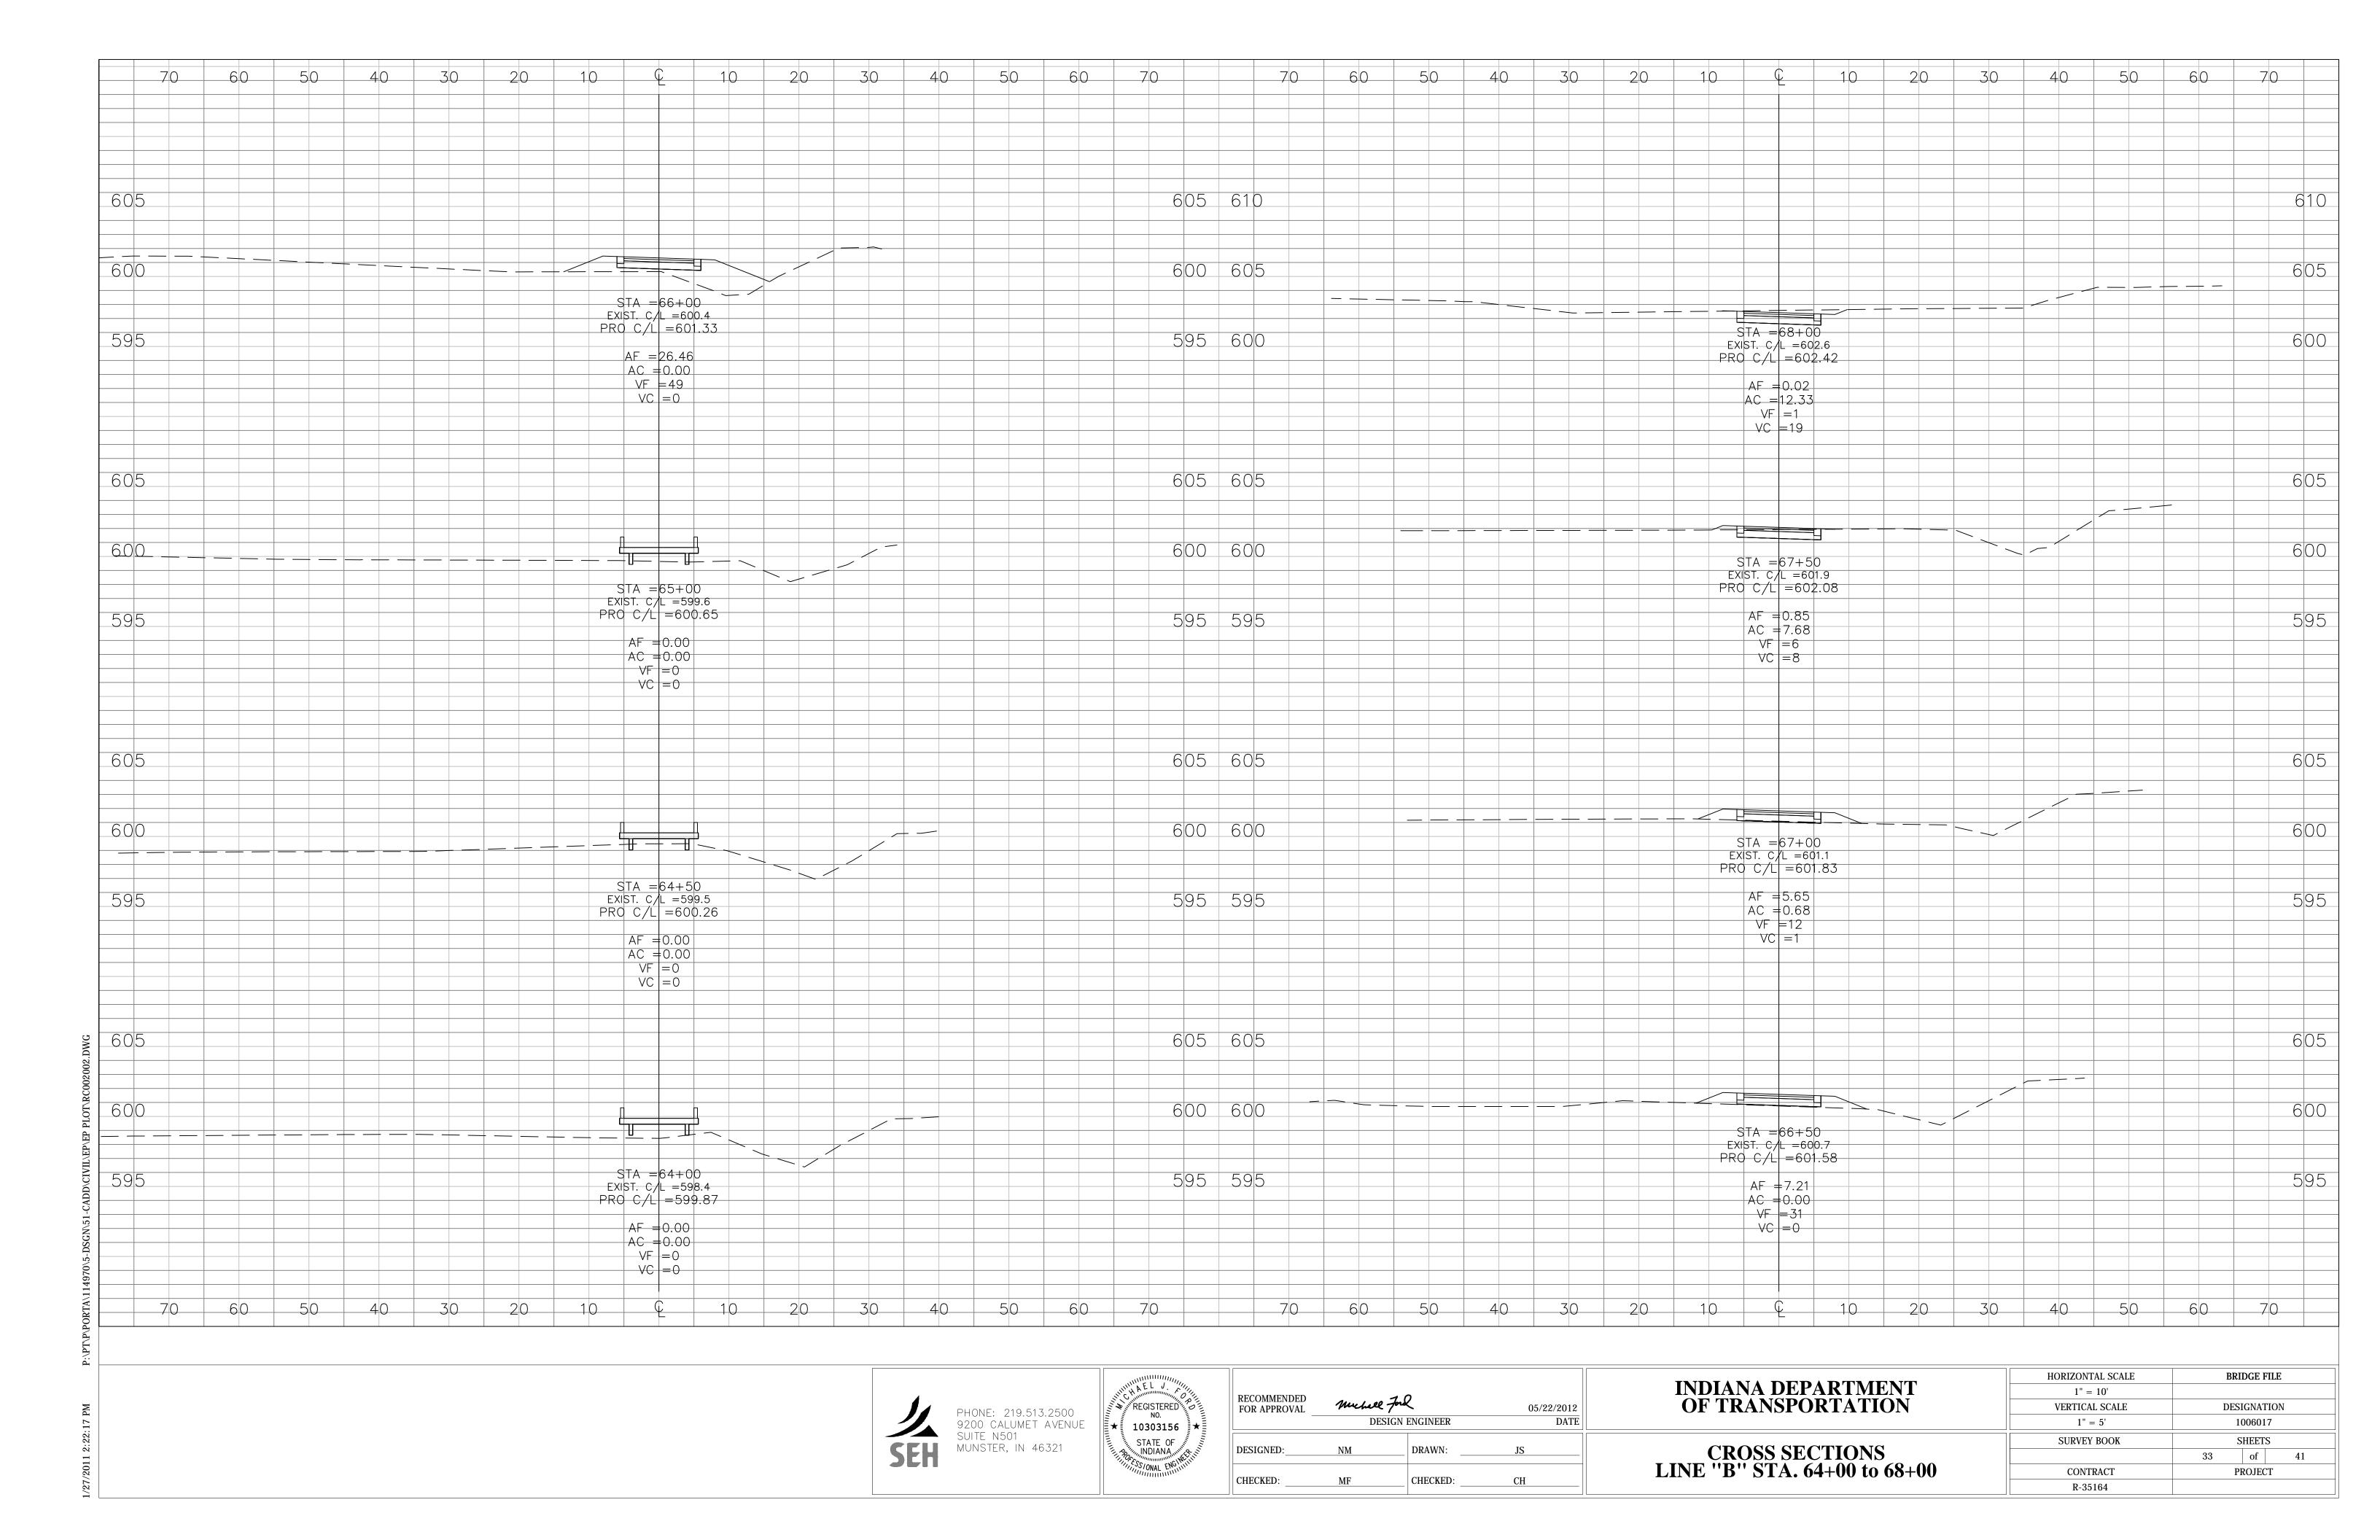






RECOMMENDED FOR APPROVAL	Muchiel Foll DESIGN ENGINEER		05/22/2012 DATE	
DESIGNED:	NM	DRAWN:	JS	
CHECKED:	MF	CHECKED:	СН	

	HORIZONTAL SCALE	BRIDGE FILE		
INDIANA DEPARTMENT	1" = 10'			
OF TRANSPORTATION	VERTICAL SCALE	DESIGNATION		ION
	1" = 5'	1006017		7
	SURVEY BOOK	SHEETS		
CROSS SECTIONS		34	of	41
LINE "B" STA. 68+50 to 71+00	CONTRACT	PROJECT		Γ
	R-35164			

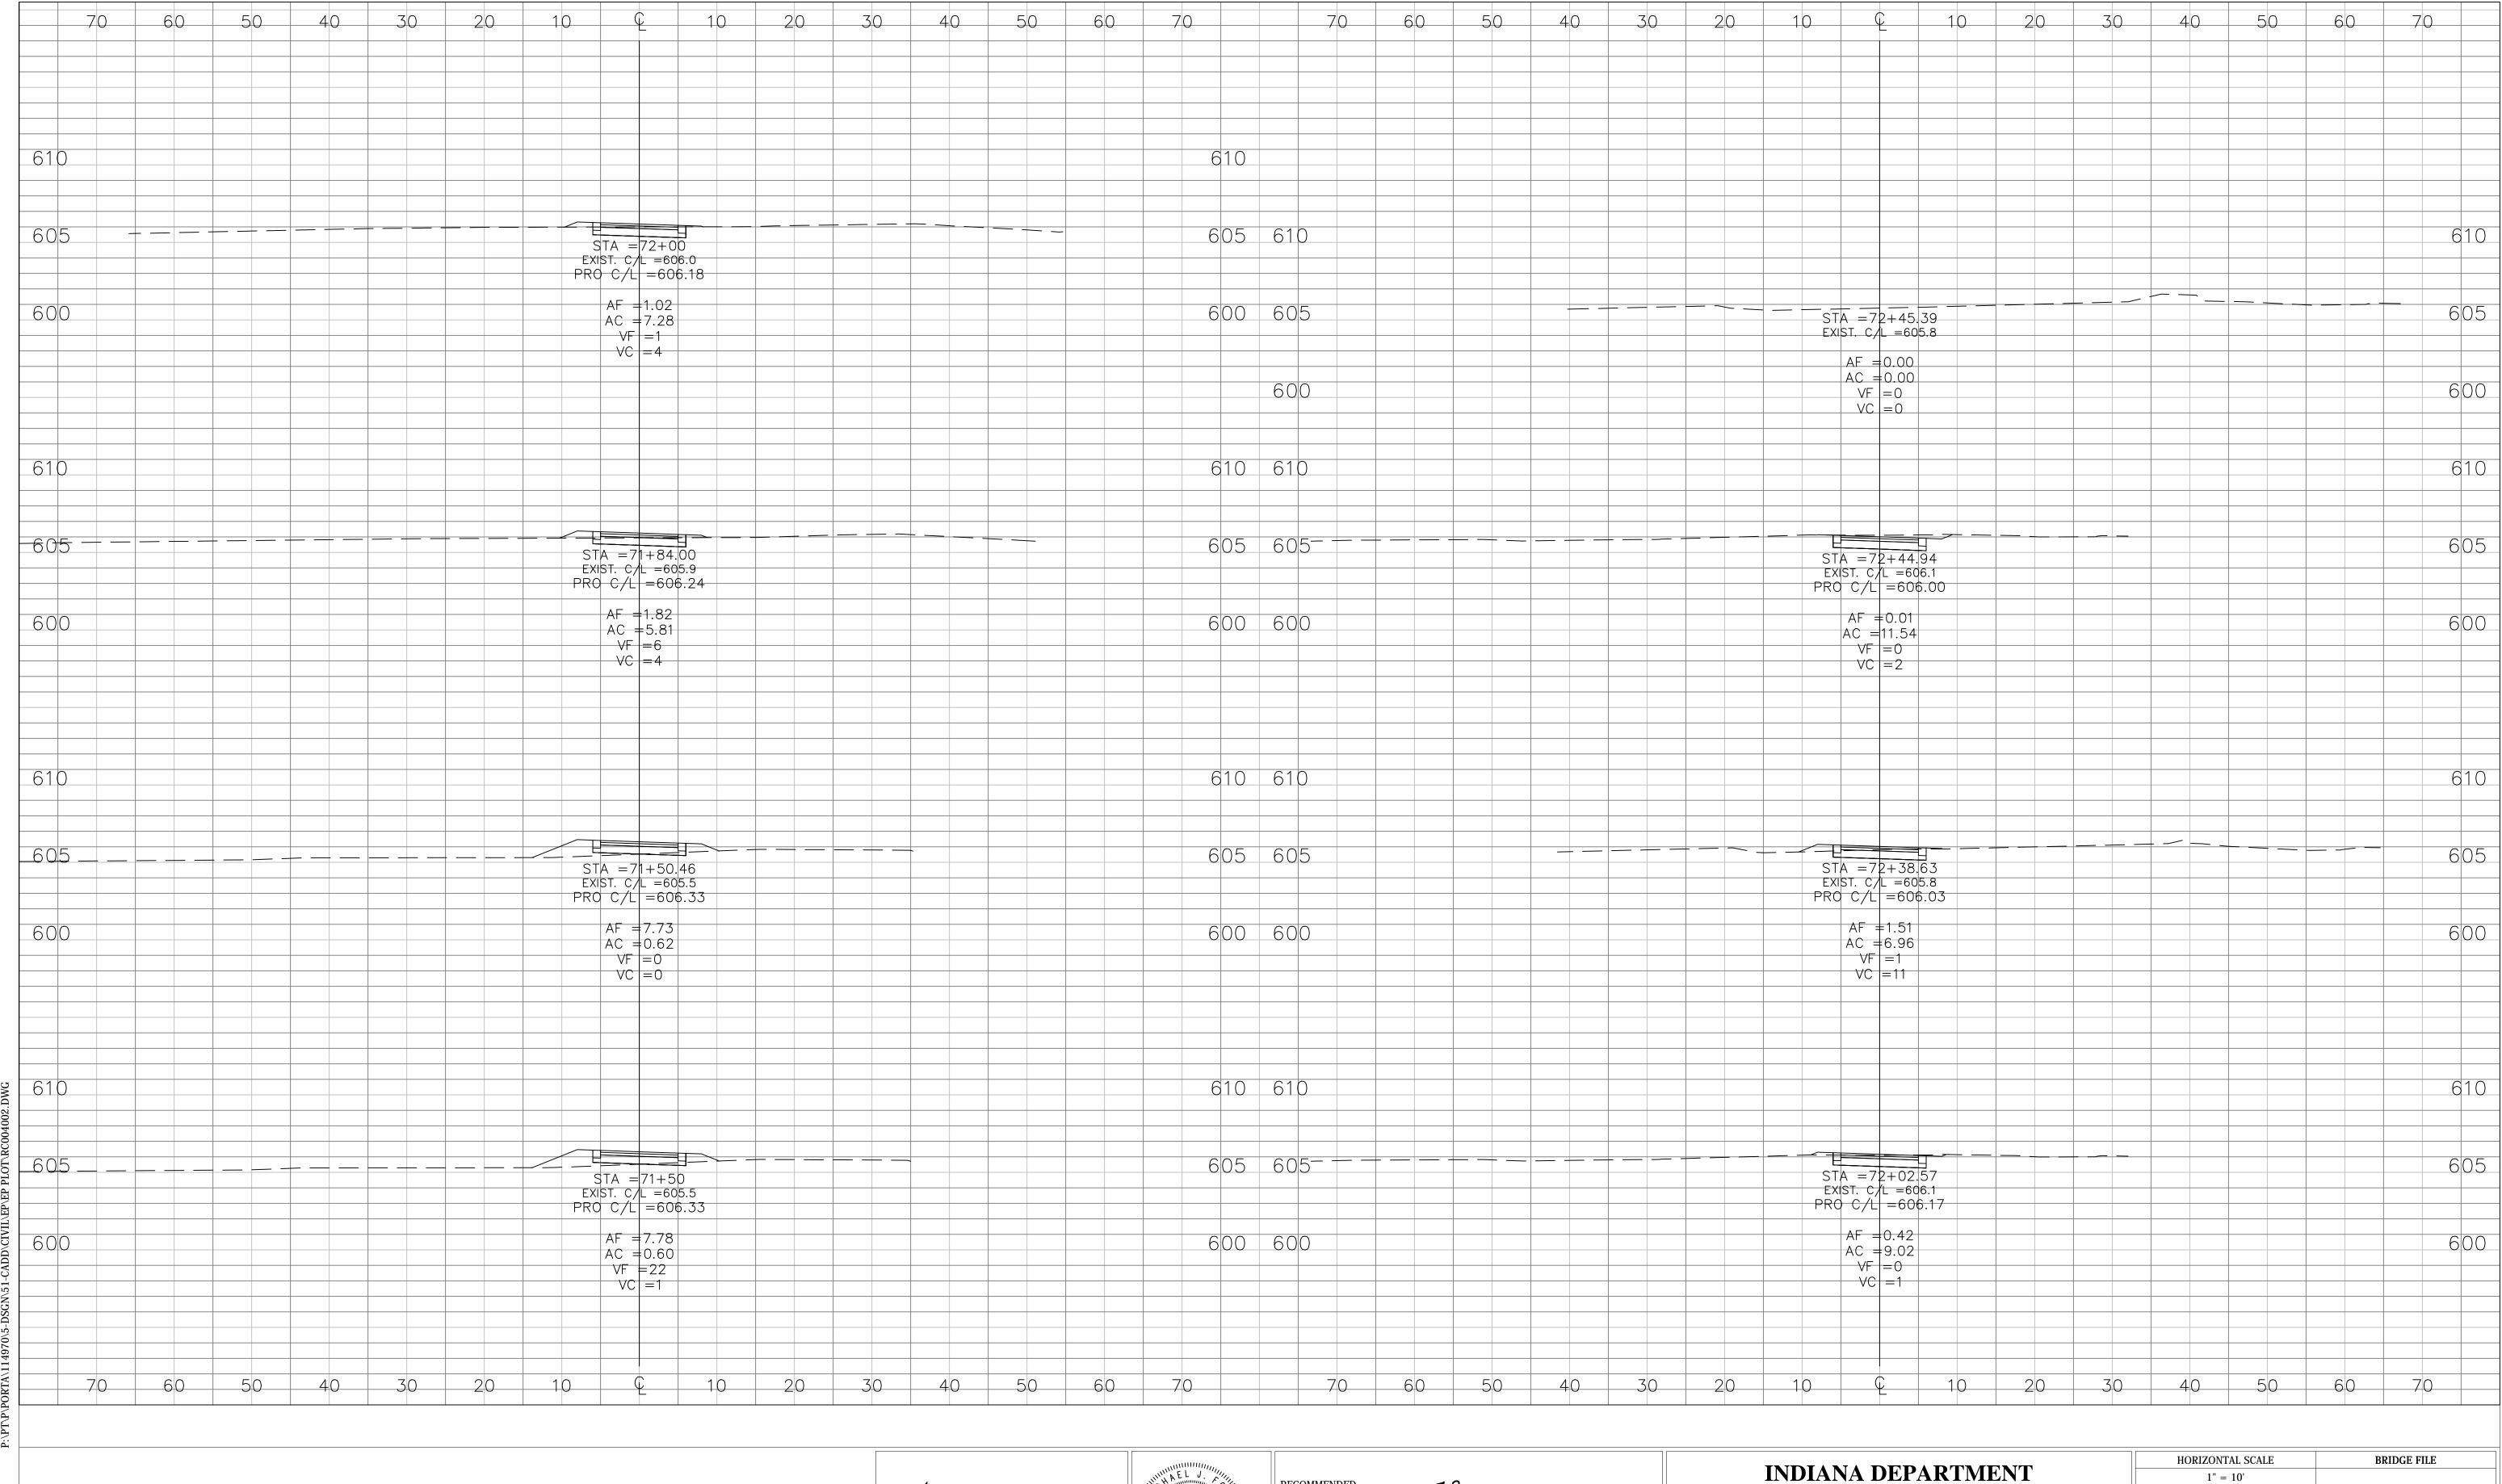






RECOMMENDED FOR APPROVAL	COLLY 1 400 NOTE		05/22/2012 DATE	
DESIGNED:	NM	DRAWN:	JS	
CHECKED:	MF	CHECKED:	СН	


	HORIZONTAL SCALE	BRIDGE FILE		
INDIANA DEPARTMENT	1" = 10'			
OF TRANSPORTATION	VERTICAL SCALE DESIGNATION		ON	
	1" = 5' 1006017			
	SURVEY BOOK SHEETS			
CROSS SECTIONS		35	of	41
LINE "B" STA. 71+50 to 72+45	CONTRACT	PROJECT		
	R-35164			

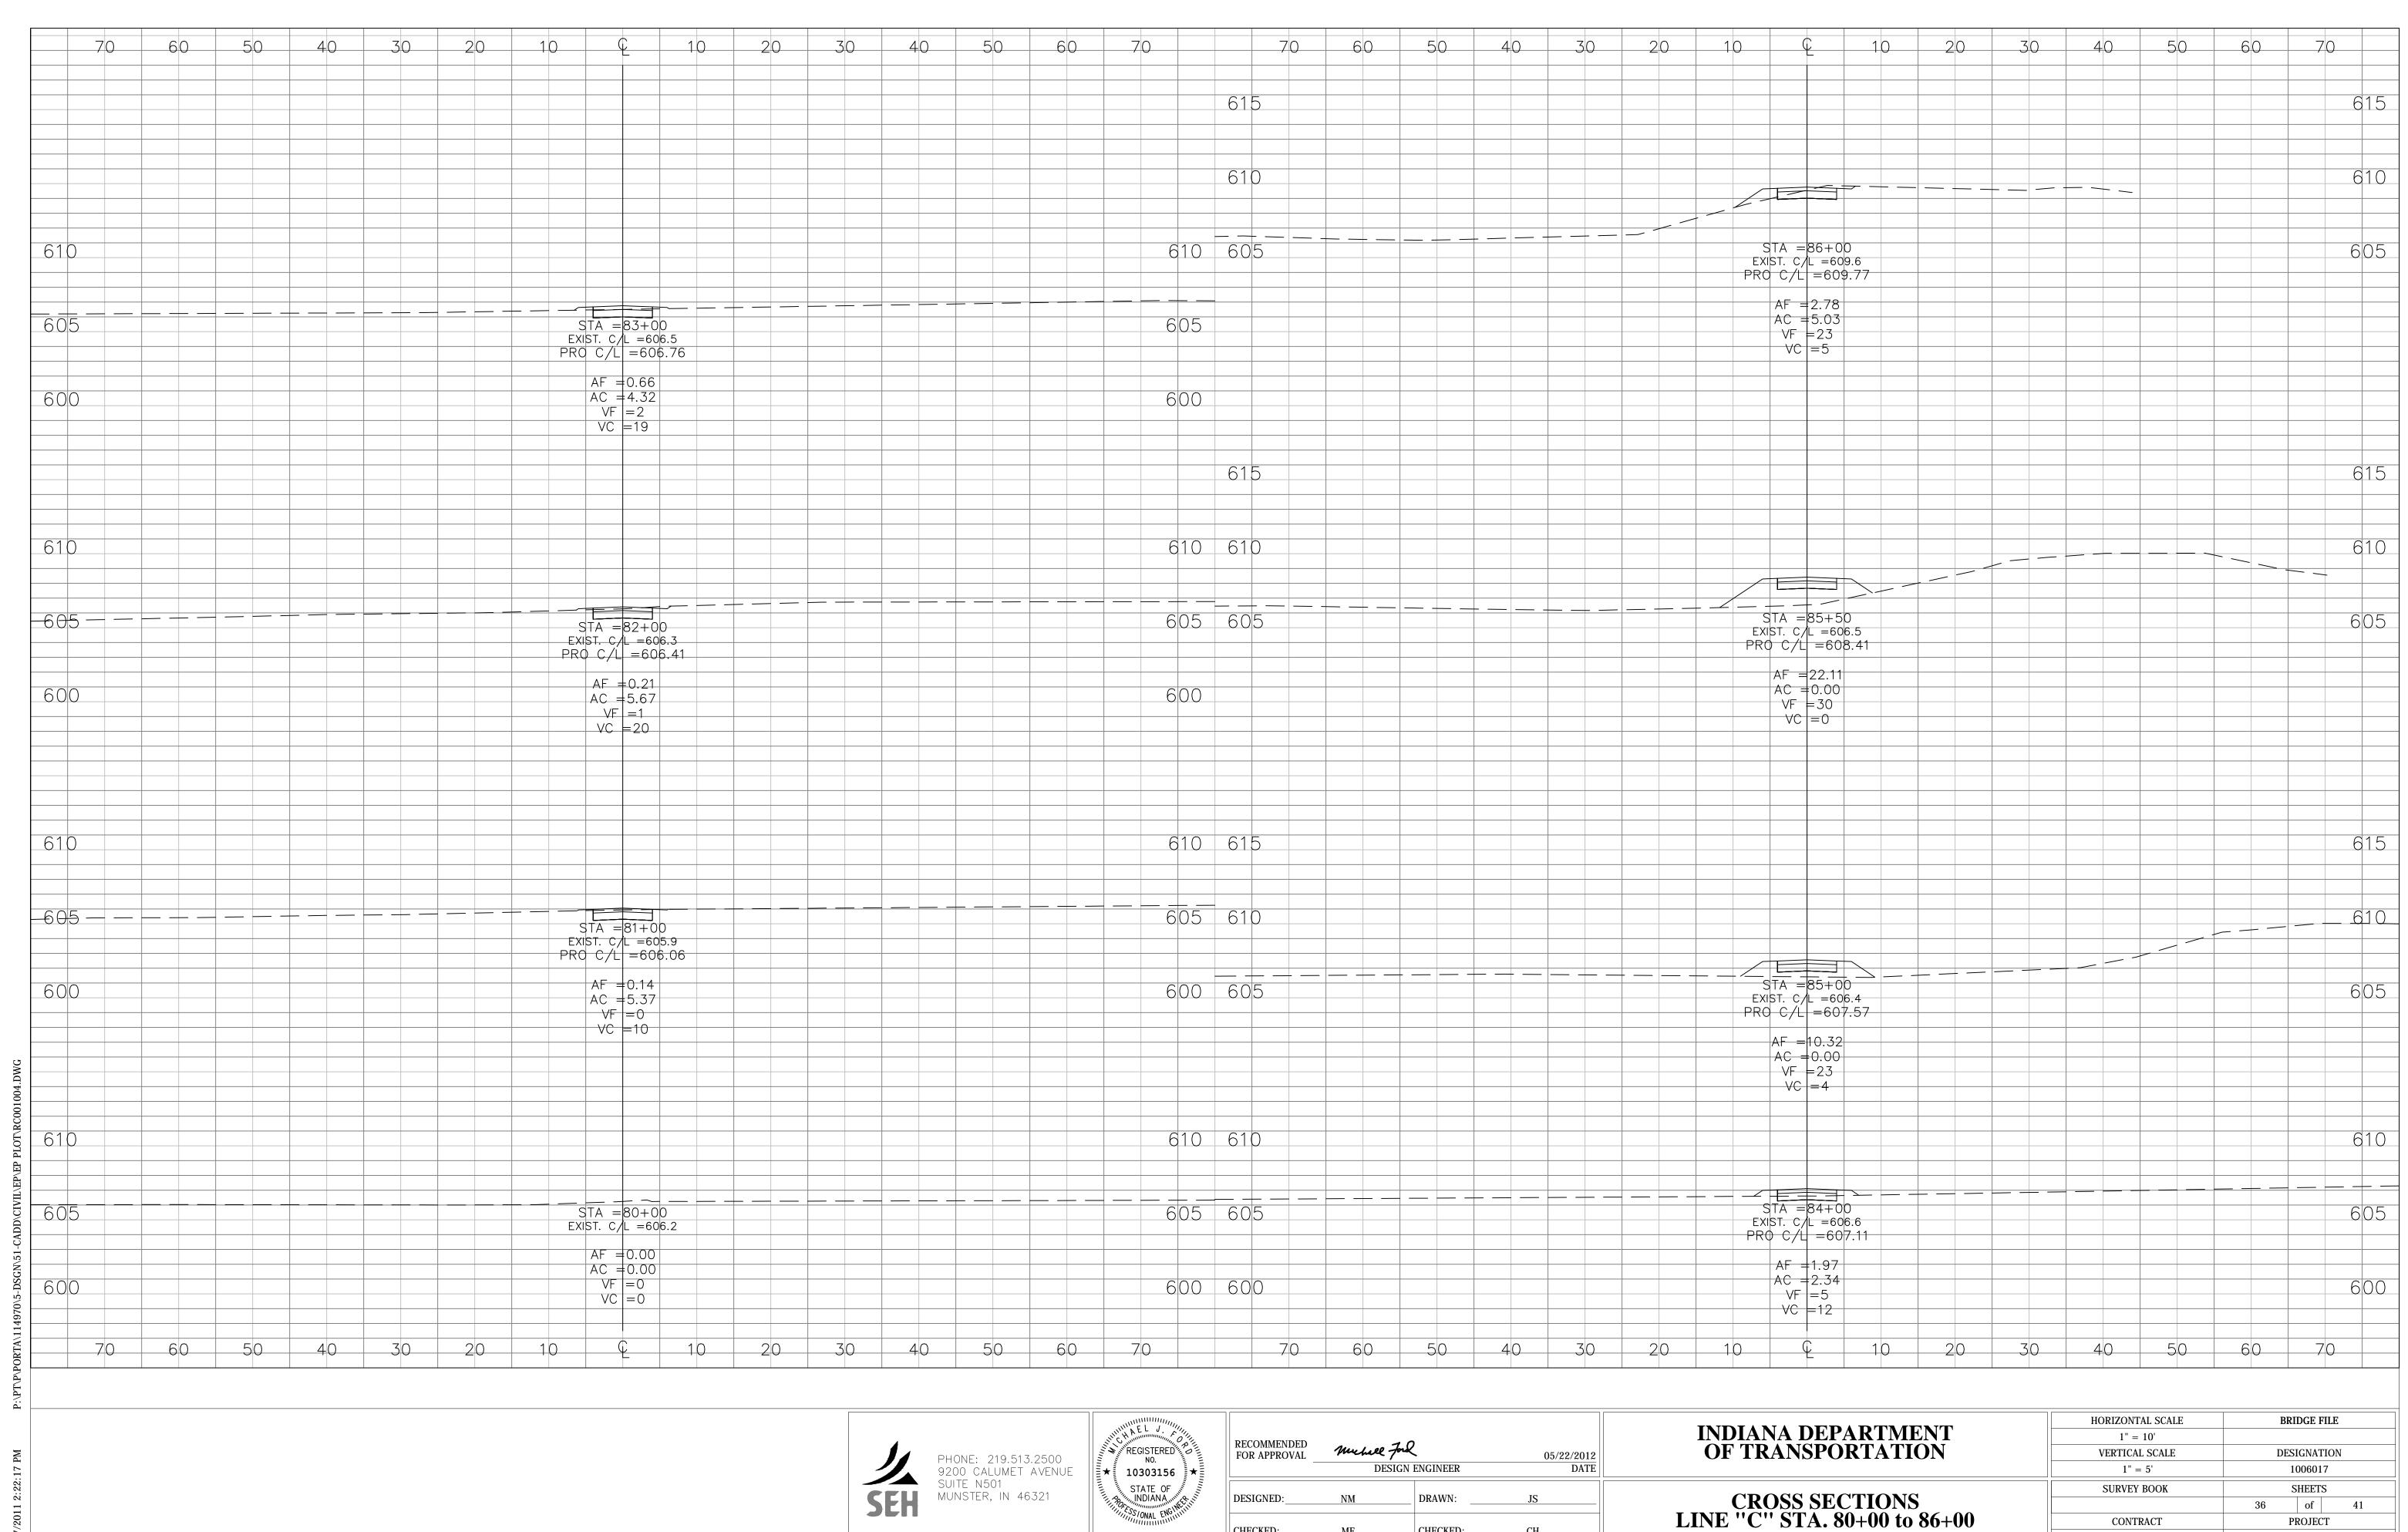





RECOMMENDED FOR APPROVAL	Muchell For DESIGN ENGINEER		05/22/2012 DATE
DESIGNED:	NM	DRAWN:	JS
CHECKED:	MF	CHECKED:	СН

HORIZONTAL SCALE	BRIDGE FILE		FILE
1" = 10'			
VERTICAL SCALE	DESIGNATION		ΓΙΟΝ
1" = 5'	1006017		17
SURVEY BOOK	SHEETS		S
	36	of	41
CONTRACT	PROJECT		CT
R-35164			

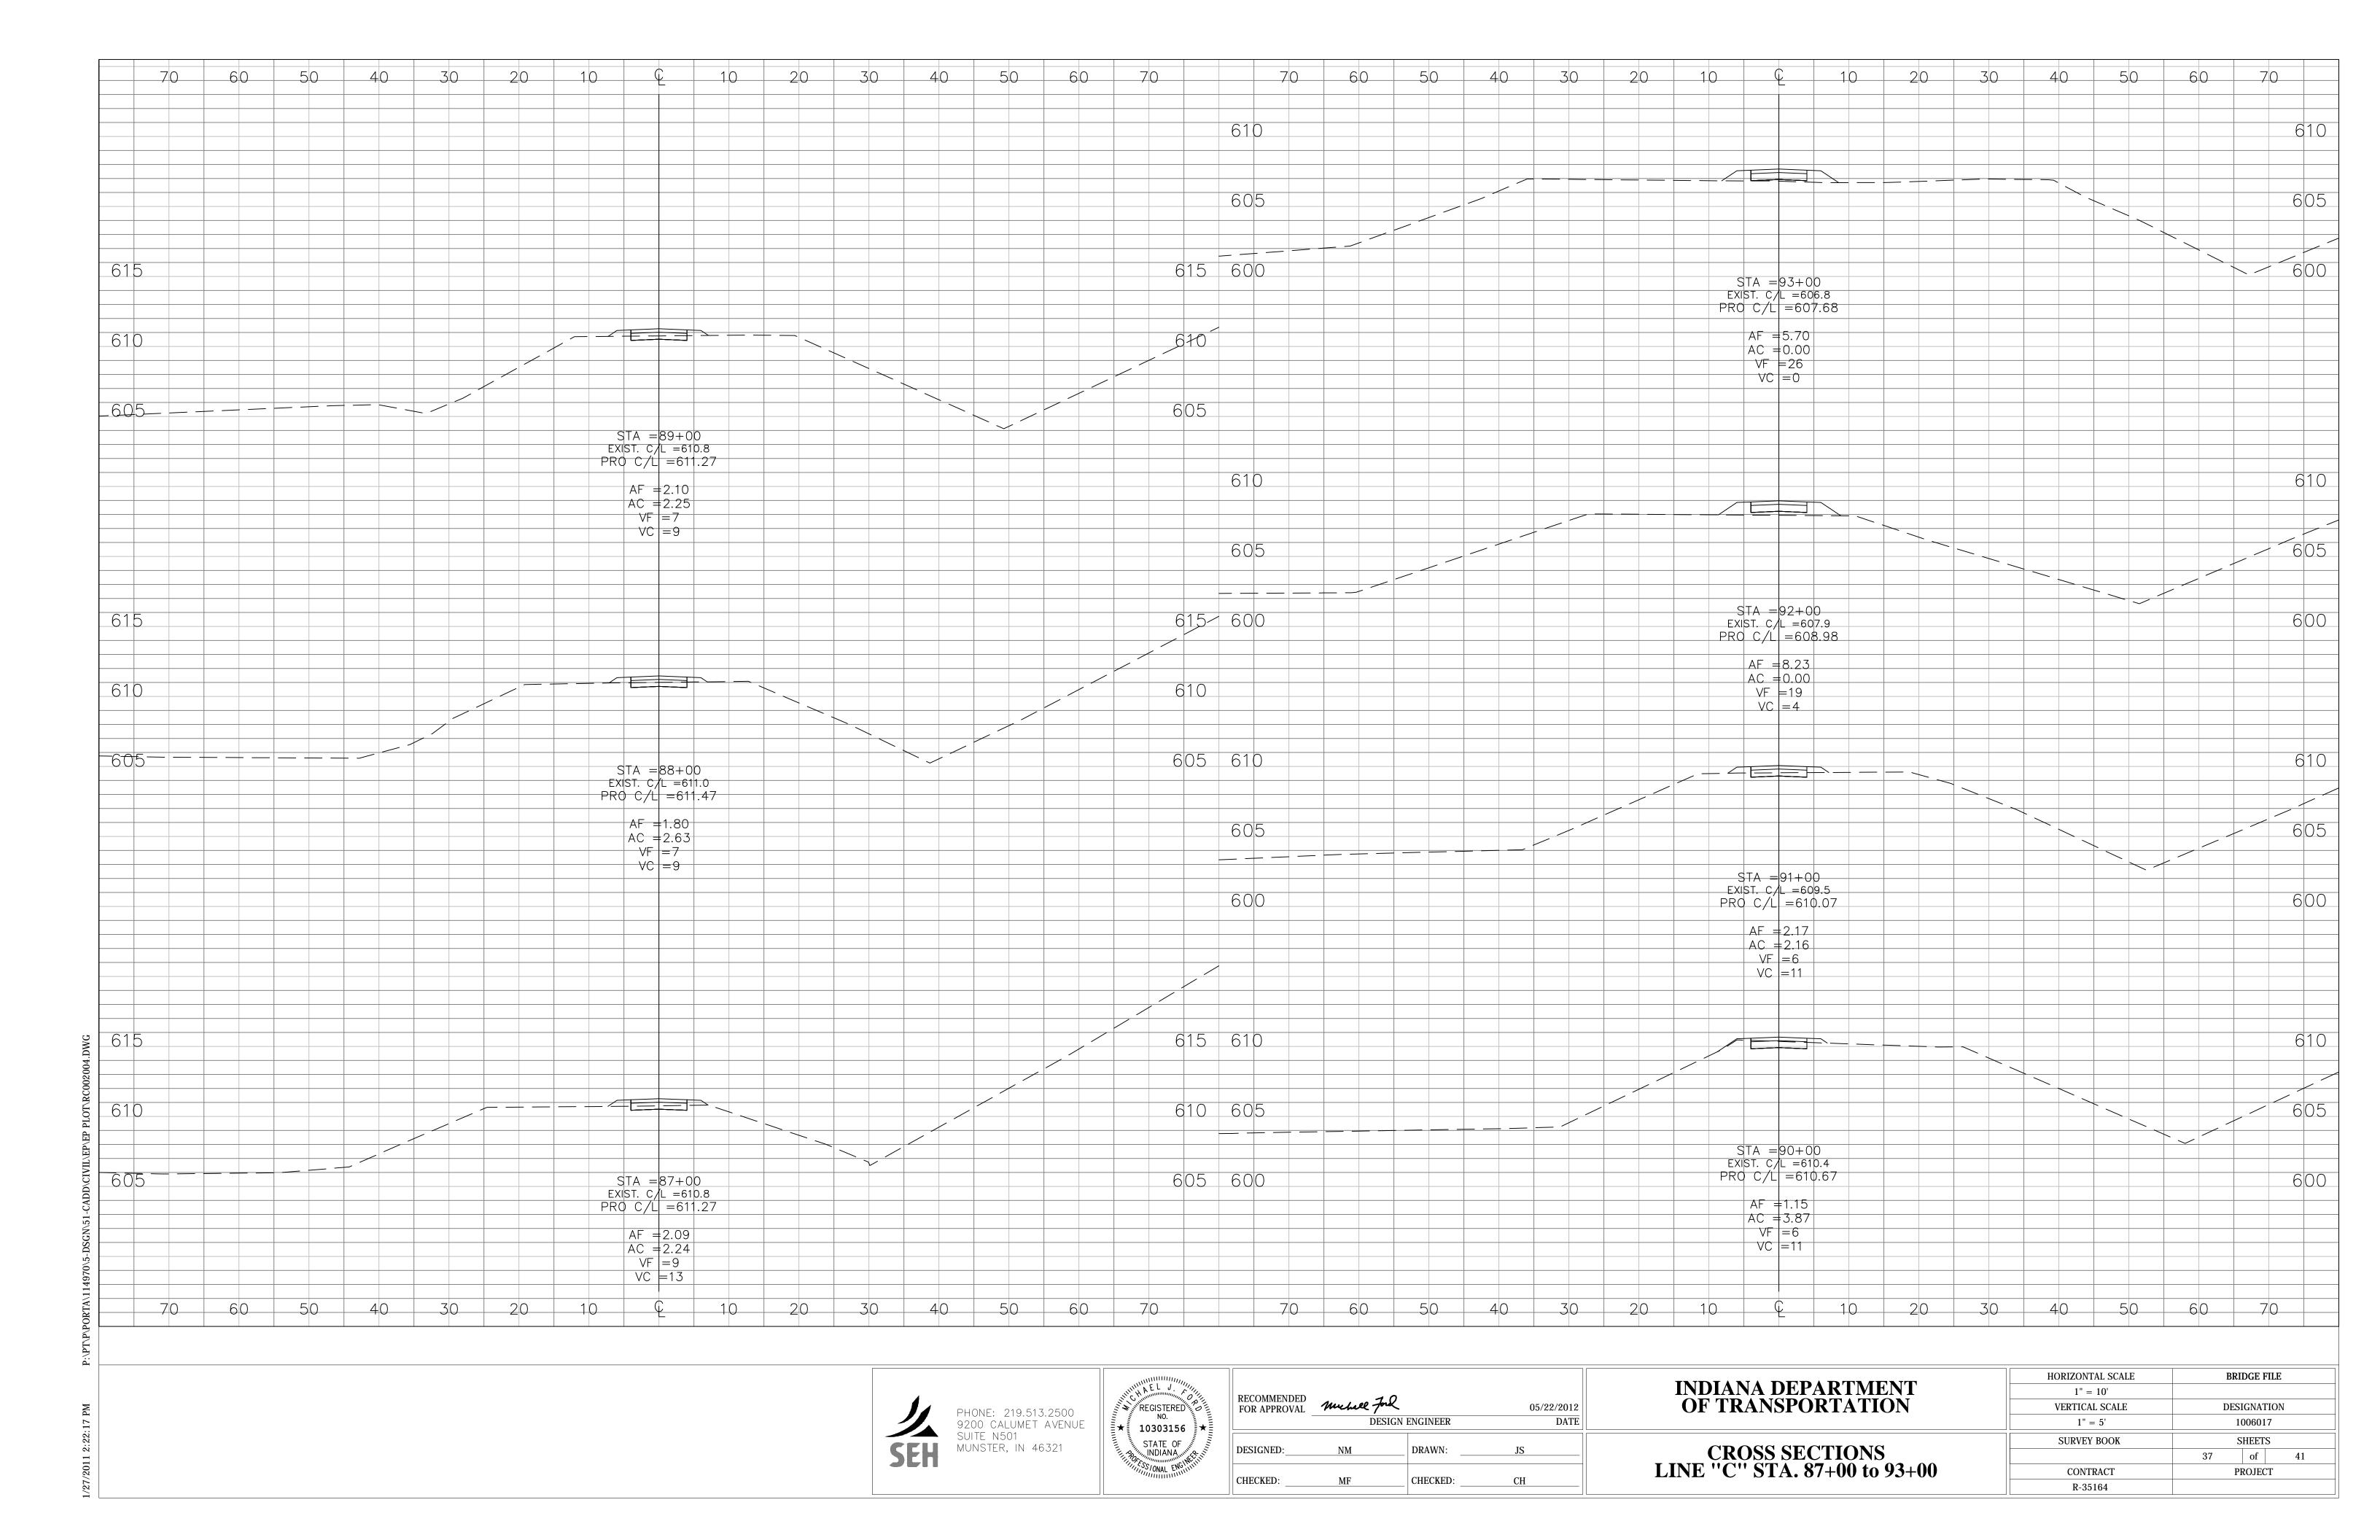

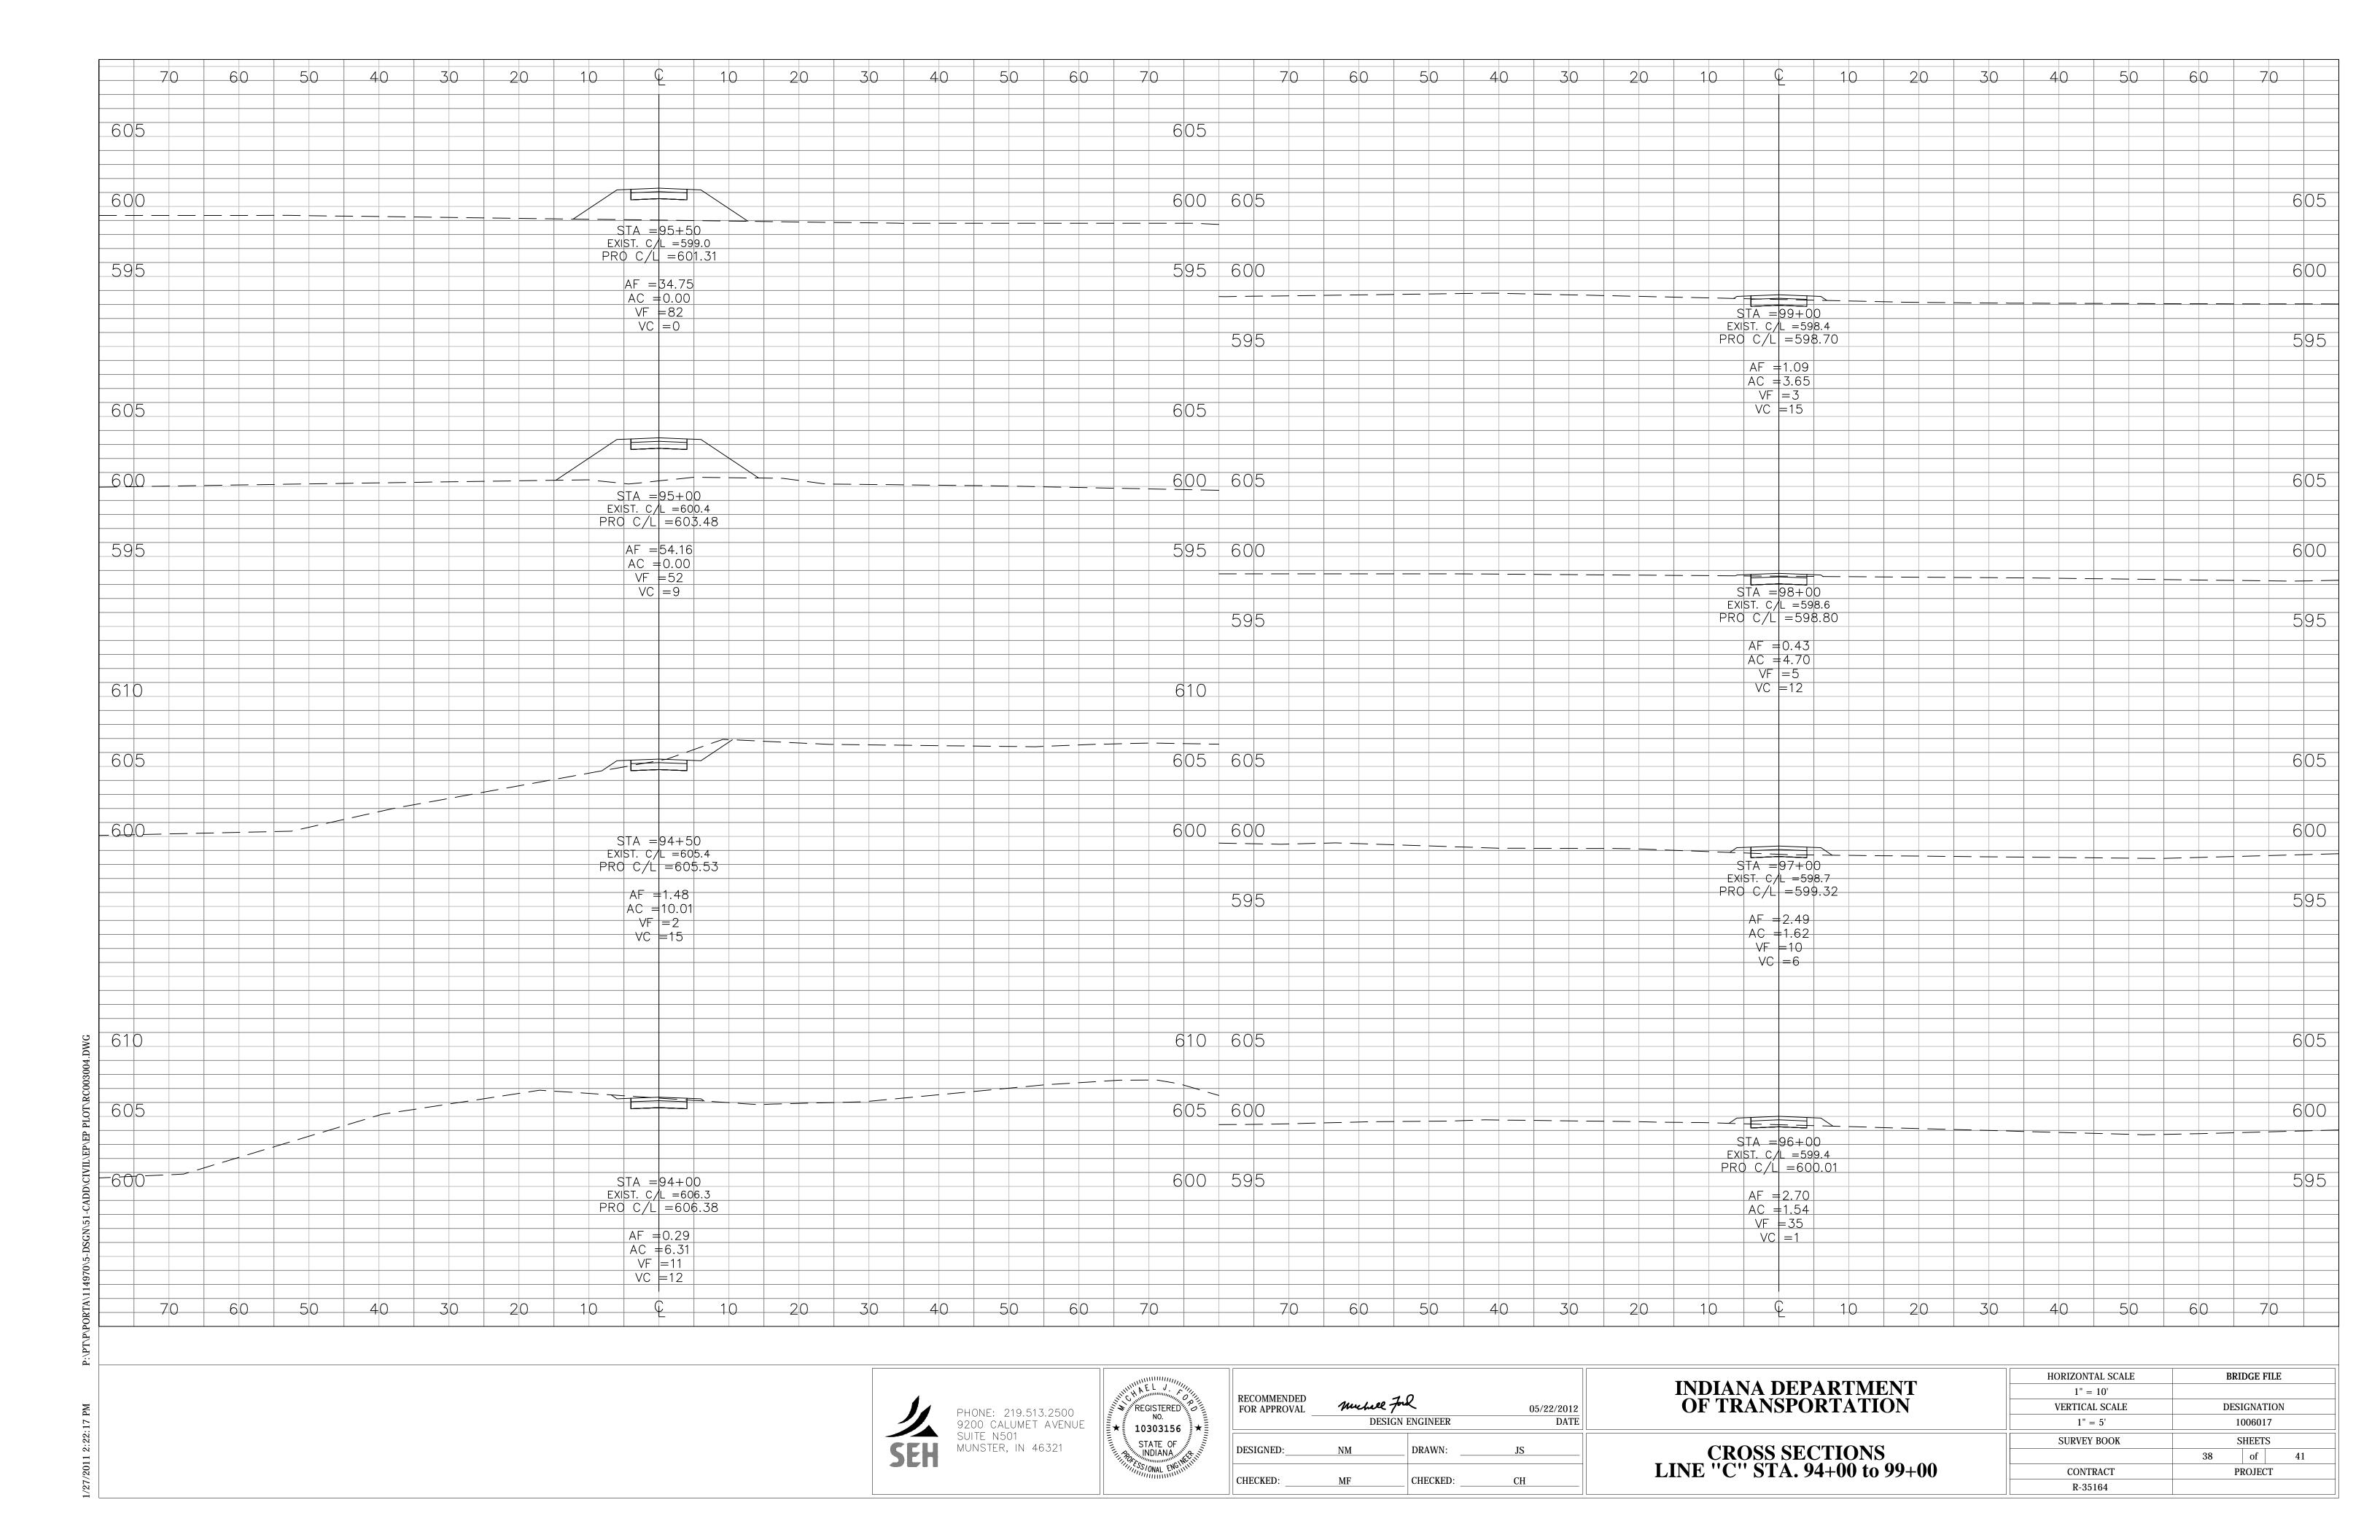

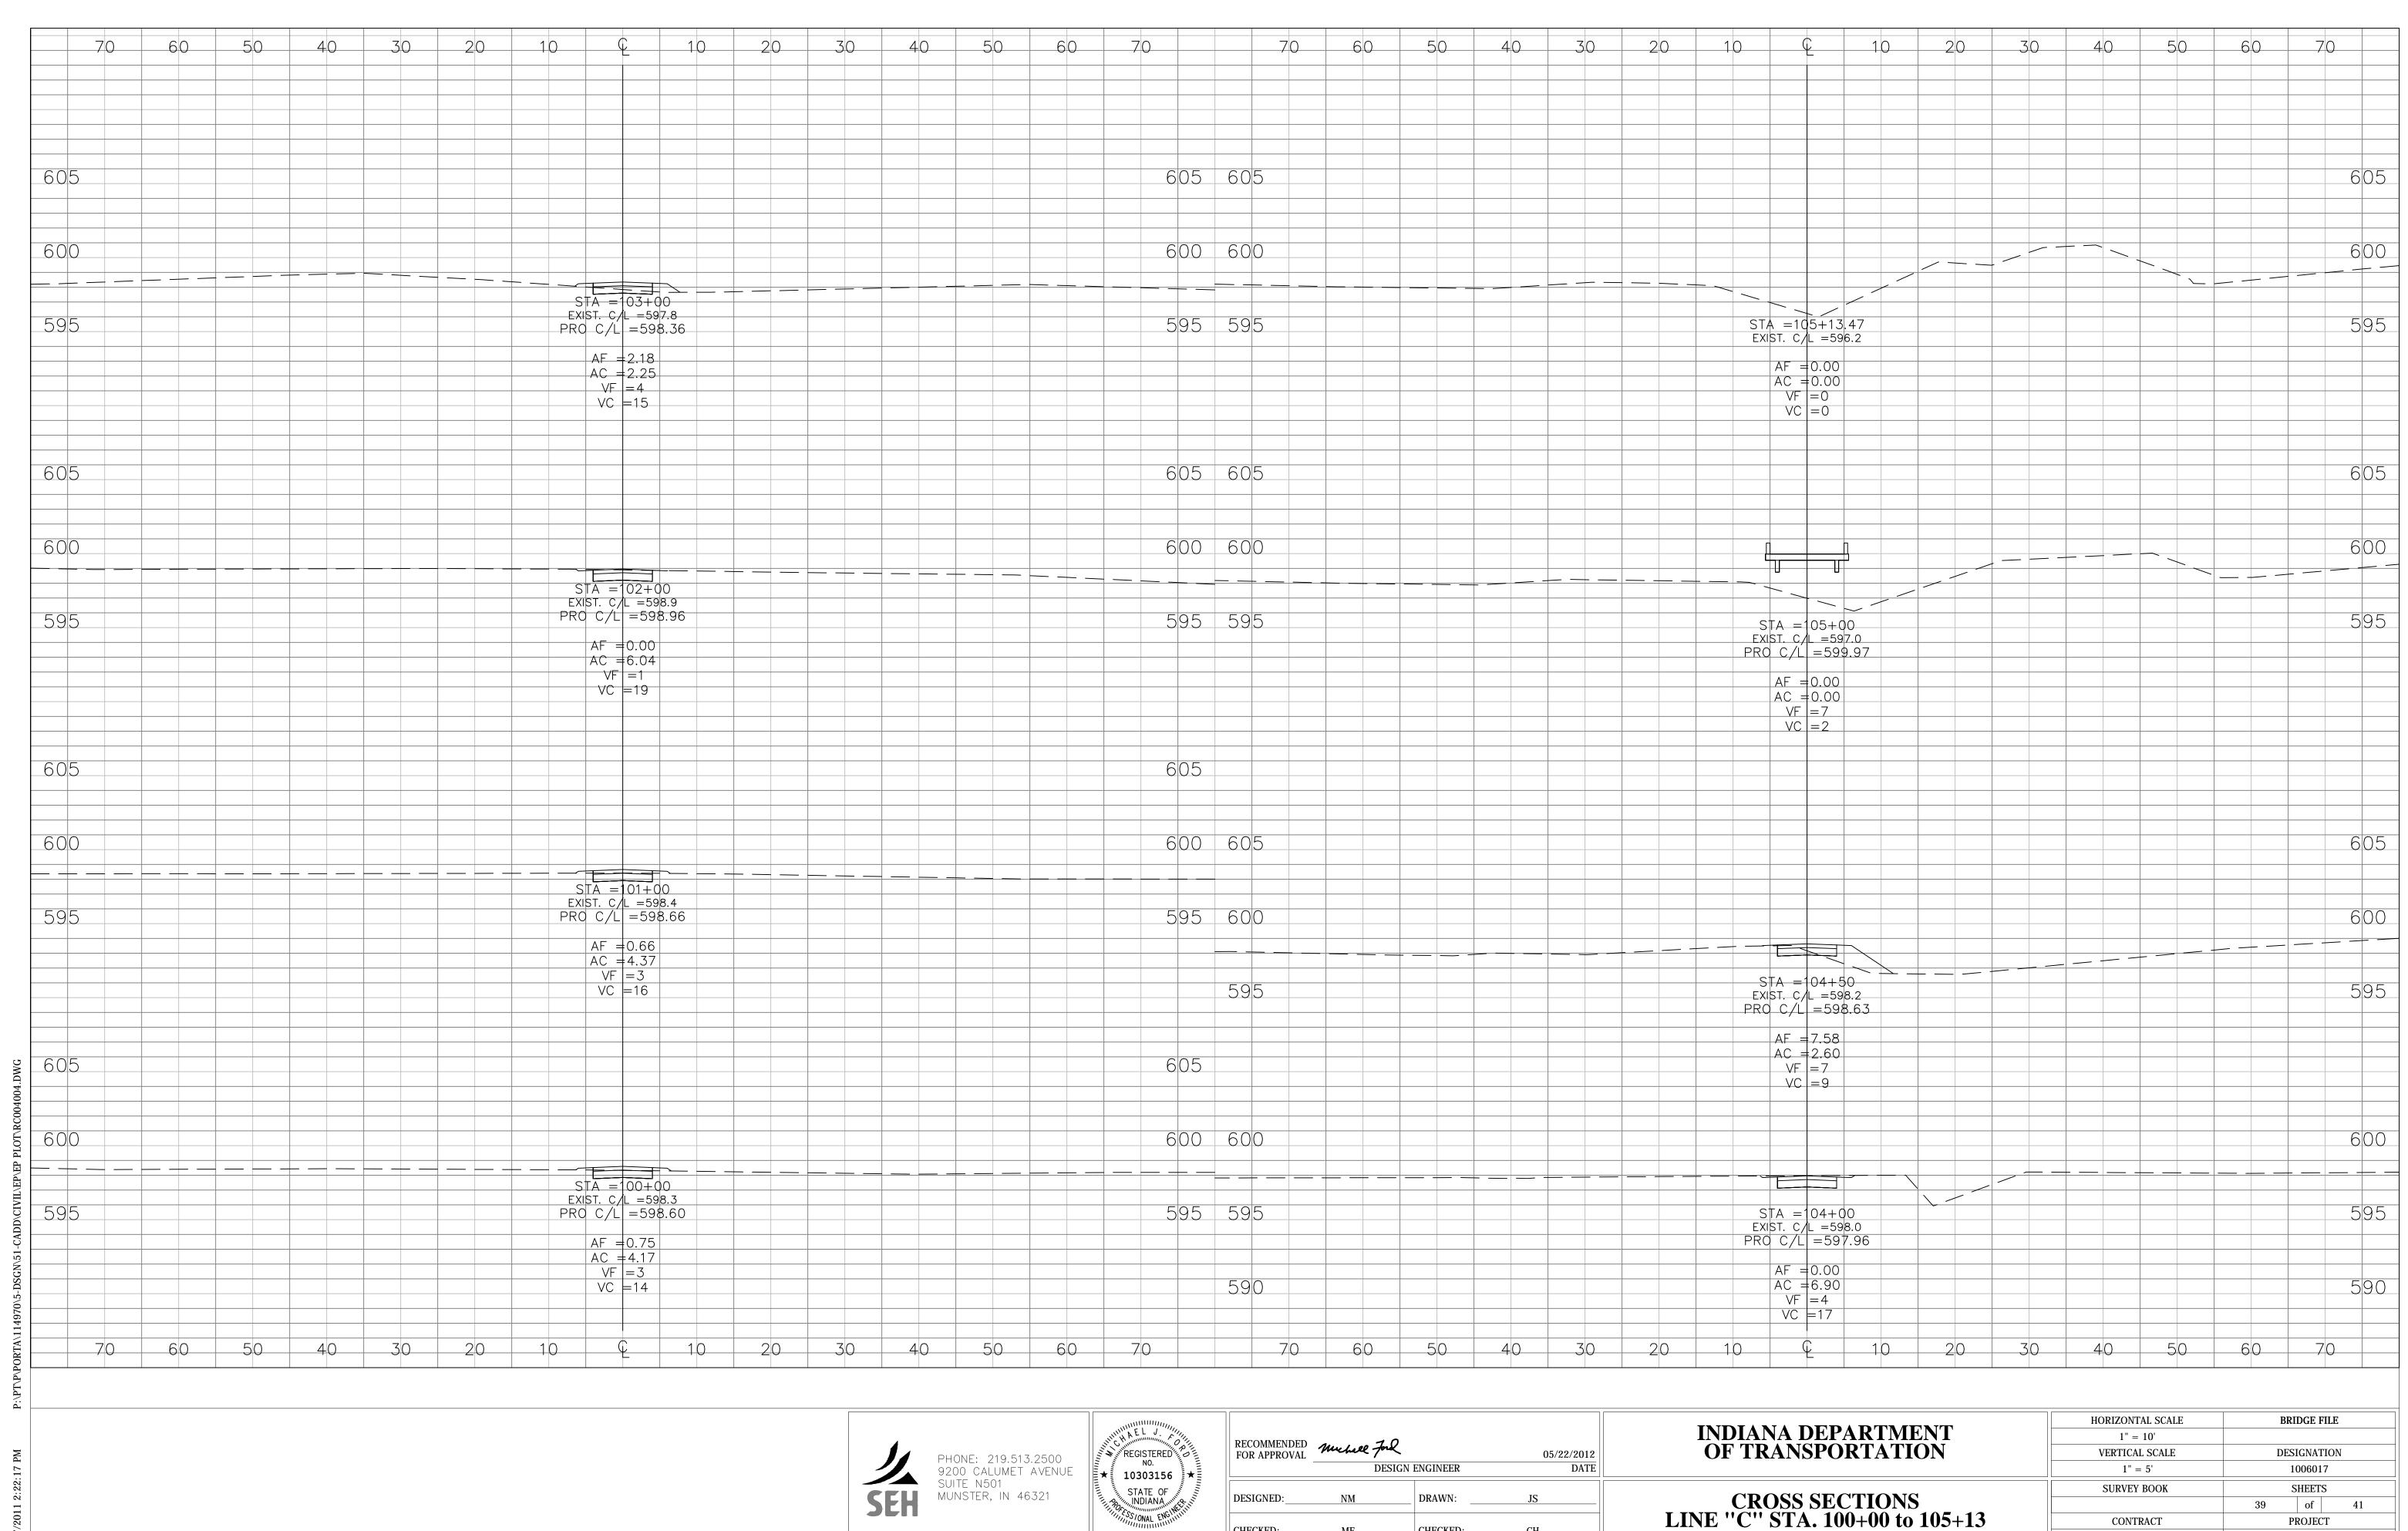



RECOMMENDED FOR APPROVAL	Muchel Fold DESIGN ENGINEER		05/22/2012 DATE
DESIGNED:	NM	DRAWN:	JS
CHECKED:	MF	CHECKED:	СН

CONTRACT PROJECT R-35164

