PROJECT	DESIGNATION
1701050	1701050
CONTRACT	
R-41469	

CULVERT ASSETS			
DES, NO.	CULVERT ASSET ID	WORK TYPE	
1701050	CV 058-047-86,77	Small Structure Replacement	

# INDIANA DEPARTMENT OF TRANSPORTATION




## **ROAD PLANS**


ROUTE: SR 58 FROM: RP 86+77 TO: RP 86 PROJECT NO. 170105000ST6 P.E.

KIN PROJECT INFORMATION			
DESIGNATION	DESIGNATION PROJECT DESCRIPTION		
1593092 Small Structure Replacement (Lead Des.)			
1701044	Small Structure Replacement		
1701050 Small Structure Replacement			

170105000ST6 R/W	
170105000ST6 CONST.	

Small Structure Replacement on SR 58 Located 9.23 Miles E of SR 37 Section 34, T-6-N, R-1-E, Pleasant Run Township, Lawrence County, Indiana

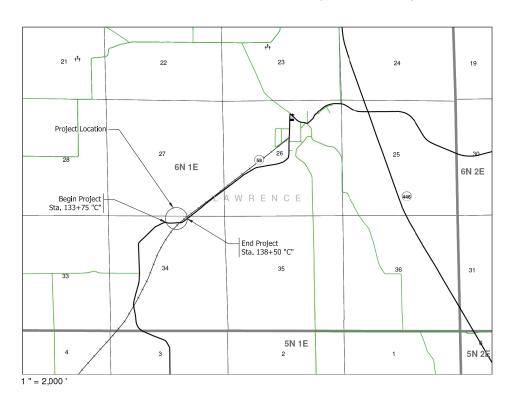

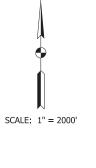


86+77

TRAFFI	TRAFFIC DATA				
A.A.D.T.	(2023)	649 V.P.D.			
A.A.D.T.	(2043)	649 V.P.D.			
D.H.V	(2043)	85 V.P.H.			
DIRECTIONAL DIST	RIBUTION	49.46 %			
TRUCKS		2.24 % A.A.D.T.			
		0.00 % D.H.V.			

#### **DESIGN DATA**

DESIGN SPEED	45 M.P.H.
PROJECT DESIGN CRITERIA	3R (NON-FREEWAY)
FUNCTIONAL CLASSIFICATION	STATE COLLECTOR
RURAL/URBAN	RURAL
TERRAIN	LEVEL
ACCESS CONTROL	NONE

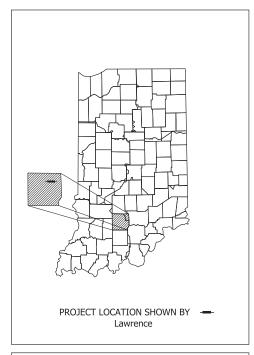

LATITUDE: N 38°55'3"	LONGITUDE: W 86°23'35"

GROSS LENGTH:	.09 MI.
NET LENGTH:	09_ MI.
MAX. GRADE:	1.11 %

INDIANA DEPARTMENT OF TRANSPORTATION STANDARD SPECIFICATIONS DATED 2020 TO BE USED WITH THESE PLANS

	DES	IGNA	TION
	1	70105	50
	SHEETS		S
	1	of	25
CONTRACT	P	ROJEC	CT
R-41469	1	70105	50

Preliminary

### UTILITIES

East Lawrence Water Authority 1009 Crawford Drive, Bedford Indiana 47421 812-279-9562 or 812-279-9996



REVISIONS			
SHEET NO.	SHEET NO. DATE REVISED		

#### **GENERAL NOTES**

Contractor shall verify the existing flow line elevation to set the appropriate sump depth


All earth shoulders, median areas, and cut and fill slopes shall be plain or mulch seeded except where sodding is specified


INDEX		
SHEET NO.	DRAWINGS INDEX	
1	TITLE	
2	INDEX AND GENERAL NOTES	
3-4	LOCATION CONTROL ROUTE SURVEY	
5	PLAT NO. 1	
6-7 TYPICAL SECTIONS		
8 MAINTENANCE OF TRAFFIC		
9 PLAN AND PROFILE		
10 CONSTRUCTION DETAILS		
11 GENERAL PLAN		
12	SUPERELEVATION	
13	EROSION CONTROL	
14-15	ROAD SUMMARY TABLES	
16	PIPE MATERIAL	
17-25	CROSS SECTIONS	

	1		
SHEET NO.	DATE	REVISED	

SCALE NA BRIDGE FILE INDIANA DEPARTMENT OF TRANSPORTATION DESIGNATION 1701050 DESIGN ENGINEER SHEETS
of 25
PROJECT DESIGNED: ROP Aprl 2021 DRAWN: ROP Apr**■** 2021 INDEX SHEET CHECKED: AKB April 2021 CHECKED: AKB Apr**il** 2021

Preliminary

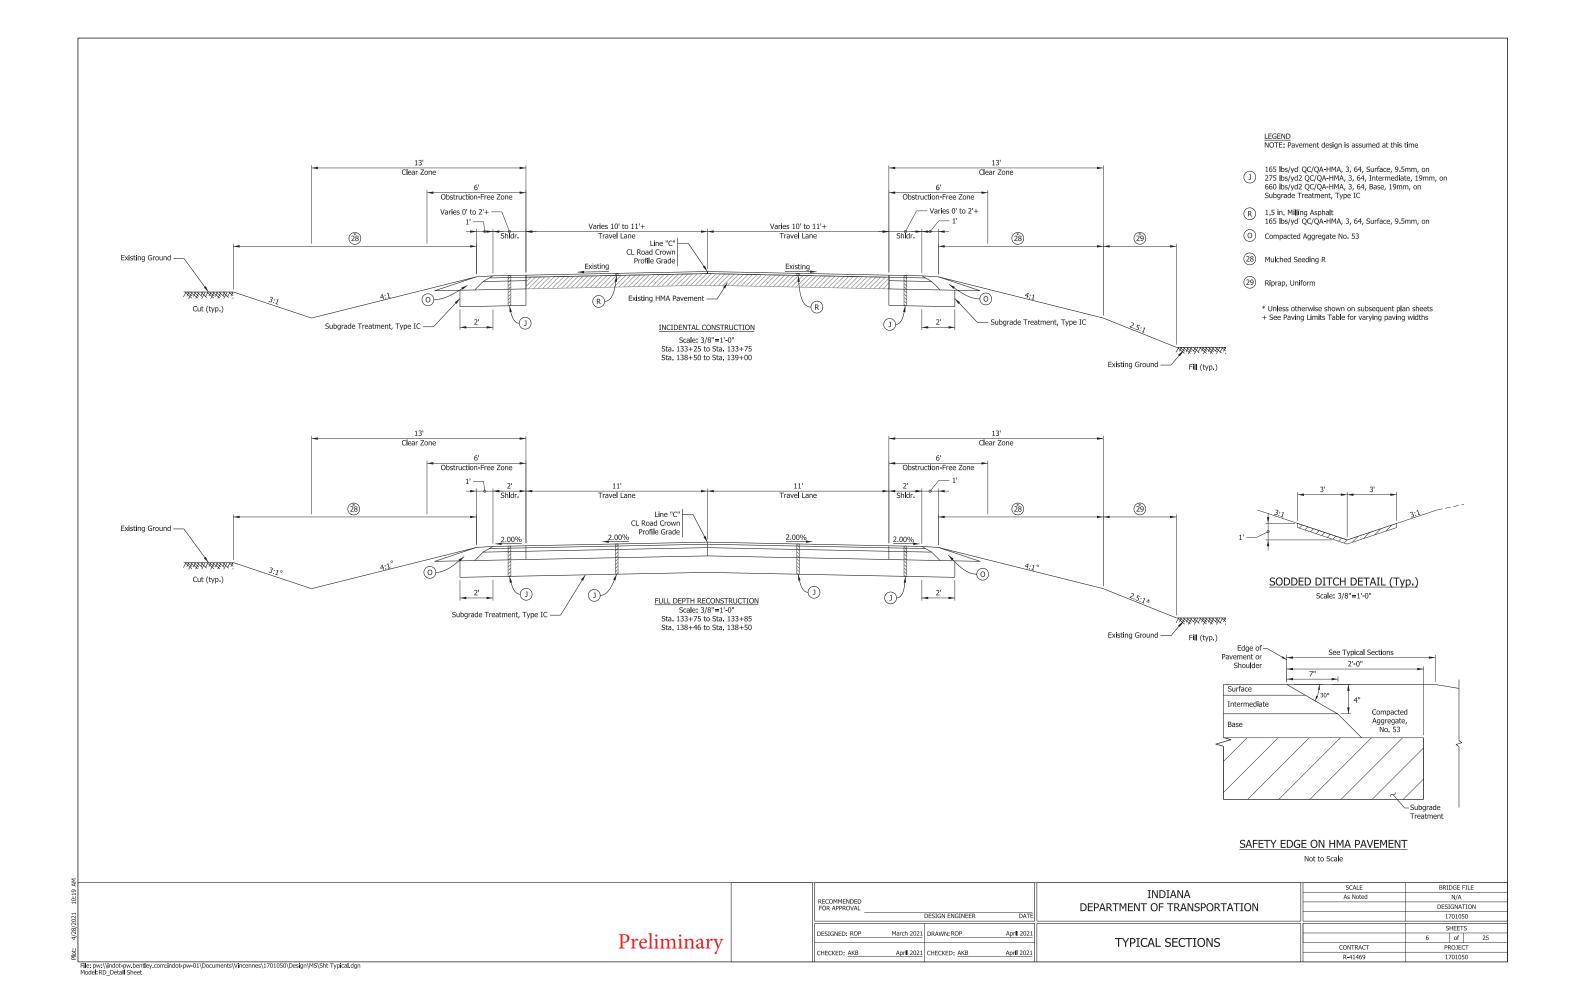

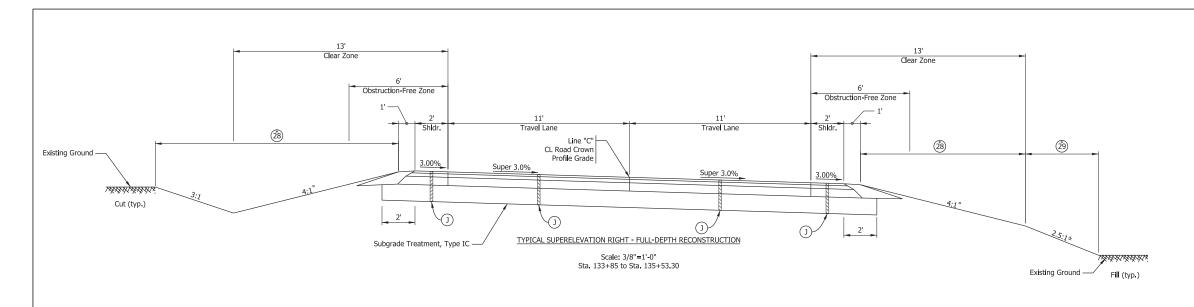

<u>LEGEND</u> NOTE: Pavement design is assumed at this time


- 165 lbs/yd' QC/QA-HMA, 3, 64, Surface, 9.5mm, on 275 lbs/yd2 QC/QA-HMA, 3, 64, Intermediate, 19mm, on 660 lbs/yd2 QC/QA-HMA, 3, 64, Base, 19mm, on Subgrade Treatment, Type IC
- R 1.5 in. Milling Asphalt 165 lbs/yd' QC/QA-HMA, 3, 64, Surface, 9.5mm, on
- O Compacted Aggregate No. 53
- 28 Mulched Seeding R
- 29 Riprap, Uniform
- \* Unless otherwise shown on subsequent plan sheets + See Paving Limits Table for varying paving widths

SCALE As Noted

BRIDGE FILE

DESIGNATION

1701050 SHEETS 25
PROJECT

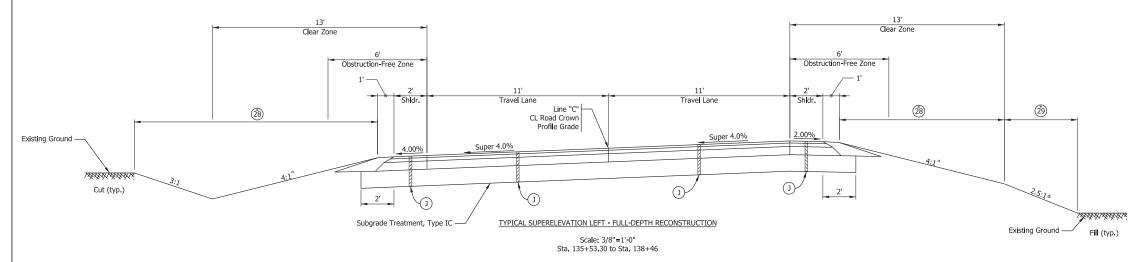

		CIE	ai Zuile i ulesi	ope mansition i	abic			
Slope - Left				Slope · Right				
From Station	Slope	To Station	Slope	From Station	Slope	To Station	Slope	
135+06.87	4:1	135+66.87	20:1	134+41.35	4:1	134+96.35	10:1	
135+66.87	20:1	136+16.69	20:1	134+96.35	10:1	135+45.37	10:1	
136+16.69	20:1	136+76.69	4:1	135+45.37	10:1	136+00.37	4:1	
		± Foreslo	pe Beyond Cle	ar Zone Transiti	on Table			
Slope - Left				Slope · Right				
135+36.87	3:1	135+66.87	3.61:1	134+41.35	3:1	134+96.35	2.18:1	
135+66.87	3.61:1	136+16.69	2.61:1	134+96.35	2.18:1	135+45.37	3.05:1	
136+16.69	2.61:1	136+51.69	3:1	165+45.37	3.05:1	136+00.37	2.5:1	
	-			136+00.37	2.5:1	137+20.00	2.5:1	

			+ Paving L	imits Table			
Travel Lane - Left				Travel Lane - Right			
From Station	Width (ft)	To Station	Width (ft)	From Station	Width (ft)	To Station	Width (ft)
133+25.00	9.09 Exist.	133+75.00	11	133+25.00	9.47 Exist.	133+75.00	11
138+50.00	11	139+00.00	9.94 Exist.	138+50.00	11	139+00.00	9.97 Exist.
Paved Shoulder - Left				Paved Shoulder - Right			
From Station	Width (ft)	To Station	Width (ft)	From Station	Width (ft)	To Station	Width (ft)
133+25.00	0	133+75.00	3.92	133+25.00	0	133+75.00	3.41
138+50.00	3.67	139+00.00	0	138+50.00	3.27	139+00.00	0

INDIANA DEPARTMENT OF TRANSPORTATION DESIGN ENGINEER DESIGNED: ROP March 2021 DRAWN: ROP Apr**∥** 2021 **Preliminary** TYPICAL SECTIONS CHECKED: AKB April 2021 CHECKED: AKB Apr**il** 2021

