

Posting Date: July 7, 2023

Request for Proposals Notification

Title: Johnson County Construction Engineering for Bridge 605 Replacement Project Fry Road over Pleasant Run Creek (Des # 2200136) in the Seymour District.

Response Due Date & Time: August 4, 2023 at 12:00 noon

This Request for Proposals (RFP) is official notification of needed professional services. This RFP is being issued to solicit a letter of Interest (LOI) and other documents from firms qualified to perform engineering work on federal aid projects. A submittal does not guarantee the firm will be contracted to perform any services but only serves notice the firm desires to be considered.

Contact for Questions: Daniel Johnston, P.E./Highway Engineer
1051 Hospital Road
Franklin, Indiana 46131
(317)346-4630
djohnston@co.johnson.in.us

Submittal Requirements:

1. Letter of Interest – submitted electronically (pdf) to Daniel Johnston at email address djohnston@co.johnson.in.us .

AND

2. One (1) signed Affirmative Action Certification and associated required documents for all items if the DBE goal is greater than 0% sent electronically (pdf) to Daniel Johnston at email address djohnston@co.johnson.in.us.

Submit To: Daniel Johnston, P.E./Highway Engineer
1051 Hospital Road
Franklin, Indiana 46131
(317)346-4630
djohnston@co.johnson.in.us

Selection Procedures:

Consultants will be selected for work further described herein, based on the evaluation of the Letter of Interest (LOI) and other required documents. The Consultant Selection Rating Form used to evaluate and score the submittals is included for your reference. Final selection ranking will be determined by:

- The weighted score totals with the highest score being the top ranked firm
- Rank totals with the lowest rank total being the top ranked firm

Requirements for Letters of Interest (LOI)

A. General instructions for preparing and submitting a Letter of Interest (LOI).

1. Provide the information, as stated in Item B below, in the same order listed and signed by an officer of the firm. Signed and scanned documents, or electronically applied signatures are acceptable. Do not send additional forms, resumes, brochures, or other material unless otherwise noted in the item description.
2. LOI's shall be limited to twelve (12) 8 ½" x 11" pages that include Identification, Qualifications, Key Staff, and Project Approach.
3. LOI's must be received no later than the "Response Due Date and Time"; as shown in the RFP header above. Responses received after this deadline will not be considered. Submittals must include all required attachments to be considered for selection.

B. Letter of Interest Content

1. Identification, Qualifications and Key Staff

- a. Provide the firm name, address of the responsible office from which the work will be performed, and the name and email address of the contact person authorized to negotiate for the associated work.
- b. List all proposed sub consultants, their DBE status, and the percentage of work to be performed by the prime consultant and each sub consultant. (See Affirmative Action Certification requirements below.) A listing of certified DBE's eligible to be considered for selection as prime consultants or sub-consultants for this RFP can be found at the "Prequalified Consultants" link on the Indiana Department of Transportation (INDOT) Consultants Webpage. (<https://www.in.gov/indot/doing-business-with-indot/consultants/consultants-prequalification/>).
- c. List the Project Manager and other key staff members, including key sub consultant staff, and the percent of time the project manager will be committed for the contract, if selected. Include project engineers for important disciplines and staff members responsible for the work. Address the experience of the key staff members on similar projects and the staff qualifications relative to the required item qualifications.

- d. Describe the capacity of consultant staff and their ability to perform the work in a timely manner relative to present workload.
2. Project Approach
 - a. Provide a description of your project approach relative to the advertised services. For project specific items confirm the firm has visited the project site. For all items address your firm's technical understanding of the project or services, cost containment practices, innovative ideas and any other relevant information concerning your firm's qualifications for the project.

Requirements for Affirmative Action Certification

A completed Affirmative Action Certification form is required for all items that identify a DBE goal greater than "0", in order to be considered for selection. The consultant must identify the DBE firms with which it intends to subcontract.

On the Affirmative Action Certification, include the contract participation percentage of each DBE and list what the DBE will be subcontracted to perform.

If the consultant does not meet the DBE goal, the consultant must provide documentation in additional pages after the form that evidences that it made good faith efforts to achieve the DBE goal.

All DBE subcontracting goals apply to all prime submitting consultants regardless of the prime's status of DBE.

INDOT DBE Reciprocity Agreement with KYTC

An Agreement between INDOT and the Kentucky Transportation Cabinet (KYTC) established reciprocal acceptance of certification of DBE firms in their respective states under the Unified Certification Program (UCP) pursuant to 49 CFR 26.81(e) and (f).

Copies of the DBE certifications, as issued by INDOT or the Kentucky Transportation Cabinet (KYTC), are to be included as additional pages after the AAC form for each firm listed on the AAC form. The following are DBE Locator Directories for each State Transportation Agency:

INDOT: <https://entapps.indot.in.gov/DBELocator/>

KYTC: <https://transportation.ky.gov/Civil-Rights-and-Small-Business-Development/Pages/Certified-DBE-Directory.aspx>

Information about the Indiana DBE Program is available at:
<https://www.in.gov/indot/about-indot/equity-initiative-services/>.

Information about the KYTC DBE Program is available at:
<https://transportation.ky.gov/Civil-Rights-and-Small-Business-Development/Pages/default.aspx>.

Work item details:

Local Public Agency: Johnson County Highway Department

Project Location: Bridge 605 is located on Fry Road over Pleasant Run Creek, approximately 100 feet west of the intersection of State Road 135 and Fry Road.

Project Description: Construction Engineering services for complete replacement of the existing bridge with a proposed continuous haunched reinforced concrete slab bridge. The bridge will remain a 2 lane section with a new pedestrian sidewalk on the south side. Full closure with detour will be used during construction. Letting is scheduled for 1/18/2024. INDOT profit calculation worksheet will be used.

INDOT Des #: 2200136

Phases Included: CE

Estimated Construction Amount: \$1.87 million

Funding: 80% Federal, 20% LPA

Term of Contract: Unit Project Completion

DBE goal: 5%

Required Prequalification Categories:

- | | |
|--|--|
| <input type="checkbox"/> 5.2 Environmental Document Preparation - CE | <input type="checkbox"/> 12.1 Project Management for Aquisition Services |
| <input type="checkbox"/> 6.1 Topographical Survey Data Collection | <input type="checkbox"/> 12.2 Title Search |
| <input type="checkbox"/> 8.1 Non-Complex Roadway Design | <input type="checkbox"/> 12.4 Appraisal |
| <input type="checkbox"/> 9.1 Level 1 Bridge Design | <input type="checkbox"/> 12.5 Appraisal Review |
| <input type="checkbox"/> 11.1 Right of Way Plan Development | <input checked="" type="checkbox"/> 13.1 Construction Inspection |
| <input type="checkbox"/> Additional Categories Listed Below: | |

[Click here to enter Additional Categories](#)

LPA Consultant Selection Rating Sheet

Sample:

RFP Selection Rating for:	Des. No.
(City, County, Town) or (Local Public Agency)	
Services Description:	
Consultant Name:	

Evaluation Criteria to be Rated by Scorers					
Category	Scoring Criteria	Scale	Score	Weight	Weighted
Past Performance	Performance evaluation score averages from historical performance data.				
	Quality score for similar work from performance database.			6	
	Schedule score from performance database.			3	
	Responsiveness score from performance database.			1	
Capacity of Team to do Work	Evaluation of the team's personnel and equipment to perform the project on time.				
	Availability of more than adequate capacity that results in added value.	1		20	
	Adequate capacity to meet the schedule.	0			
Insufficient available capacity to meet the schedule.	-1				
Team's Demonstrated Qualifications	Technical Expertise: Unique Resources that yield a relevant added value or efficiency			15	
	Demonstrated outstanding expertise and resources identified	2			
	Demonstrated high level of expertise and resources identified	1			
	Expertise and resources at appropriate level.	0			
	Insufficient expertise and/or resources.	-3			
Project Manager	Predicted ability to manage the project, based on: experience in size, complexity,			20	
	Demonstrated outstanding experience in similar type and complexity.	2			
	Demonstrated high level of experience in similar type and complexity.	1			
	Experience in similar type and complexity shown in resume.	0			
	Experience in different type or lower complexity.	-1			
	Insufficient experience.	-3			
Approach to Project	Project Understanding and Innovation that provides cost and/or time savings.			15	
	High level of understanding and viable innovative ideas proposed.	2			
	High level of understanding of the project.	1			
	Basic understanding of the project.	0			
	Lack of project understanding.	-3			
				Weighted Sub-Total:	

It is the responsibility of scorers to make every effort to identify the firm most capable of producing the highest deliverables in a timely and cost effective manner without regard to personal preference.

I certify that I do not have any conflicts of interest associated with this consultant.

I have thoroughly reviewed the letter of interest for this consultant and certify that the above scores represent my best judgment of this firm's abilities.

Signature: _____	Print Name: _____
Title: _____	Date: _____
(Form Rev. 1/27/2023)	

Des. #: [Click here to enter text.](#)

Affirmative Action Certification (AAC) for Disadvantaged Business Enterprises (DBE)

I hereby certify that my company intends to affirmatively seek out and consider Disadvantaged Business Enterprises (DBEs) certified by the State of Indiana’s DBE Program and the Kentucky Transportation Cabinet (KYTC) DBE Program to participate as part of this proposal. An Agreement between INDOT and KYTC established reciprocal acceptance of certification of DBE firms in their respective states under the Unified Certification Program (UCP) pursuant to 49 CFR §26.81(e) and (f).

I acknowledge that this certification is to be made an integral part of this proposal. I understand and agree that the submission of a blank certification may cause the proposal to be rejected. I certify that I have consulted the following DBE websites to confirm that the firms listed below are currently certified DBEs:

INDOT: <https://entapps.indot.in.gov/DBELocator/>

KYTC: <https://transportation.ky.gov/Civil-Rights-and-Small-Business-Development/Pages/Certified-DBE-Directory.aspx>

I certify that I have contacted the certified DBE’s listed below, and if my company becomes the CONSULTANT, these DBEs have tentatively agreed to perform the services as indicated. I understand that neither my company nor I will be penalized for DBE utilization that exceeds the goal. After contract award, any change to the firms listed in this Affirmative Action Certification to be applied toward the DBE goal must have prior approval by INDOT’s Economic Opportunity Division.

I. DBE Subconsultants to be applied toward DBE goal for the RFP item:

Certified DBE Name	Service Planned	Estimated Percentage to be Paid*
		%
		%
		%
		%

II. DBE Subconsultants to be utilized beyond the advertised DBE goal for the RFP item:

Certified DBE Name	Service Planned	Estimated Percentage to be Paid*
		%
		%
		%
		%

Estimated Total Percentage Credited toward DBE Goal: _____

Estimated Percentage of Voluntary DBE Work Anticipated over DBE Goal: _____

Company Name: _____

Signature: _____ **Date:** _____

* It is understood that these individual firm percentages are estimates only and that percentages paid may be greater or less as a result of negotiation of contract scope of work. My firm will use good faith efforts to meet the overall DBE goal through the use of these or other certified and approved DBE firms.

PROJECT	DESIGNATION
2200136	2200136
CONTRACT	BRIDGE FILE
B-44295	JOHNSON 605

STRUCTURE INFORMATION				
STRUCTURE	TYPE	SPAN AND SKEW	OVER	STATION
JOHNSON 605	CONTINUOUS HAUNCHED REINFORCED CONCRETE SLAB BRIDGE	3 SPANS: 45'-0", 56'-0", 45'-0" 25° SKEW RIGHT	PLEASANT RUN CREEK	13+03.50 "A"

No Kin Projects in this Contract.



APPROVED BY:
BOARD OF JOHNSON COUNTY COMMISSIONERS

CHAIRMAN: _____

MEMBER: _____

MEMBER: _____

LUCAS MASTIN, JOHNSON COUNTY HIGHWAY DIRECTOR

DANIEL JOHNSTON, JOHNSON COUNTY ENGINEER & ERC

ATTEST: _____ DATE: _____

COUNTY AUDITOR _____

PLANS PREPARED BY



TRANSPORTATION & DEVELOPMENT CONSULTANTS
115 N. 17TH AVENUE
BEECH GROVE, IN 46107
(317) 780-1555
CROSSROADENGINEERS.COM

INDIANA DEPARTMENT OF TRANSPORTATION

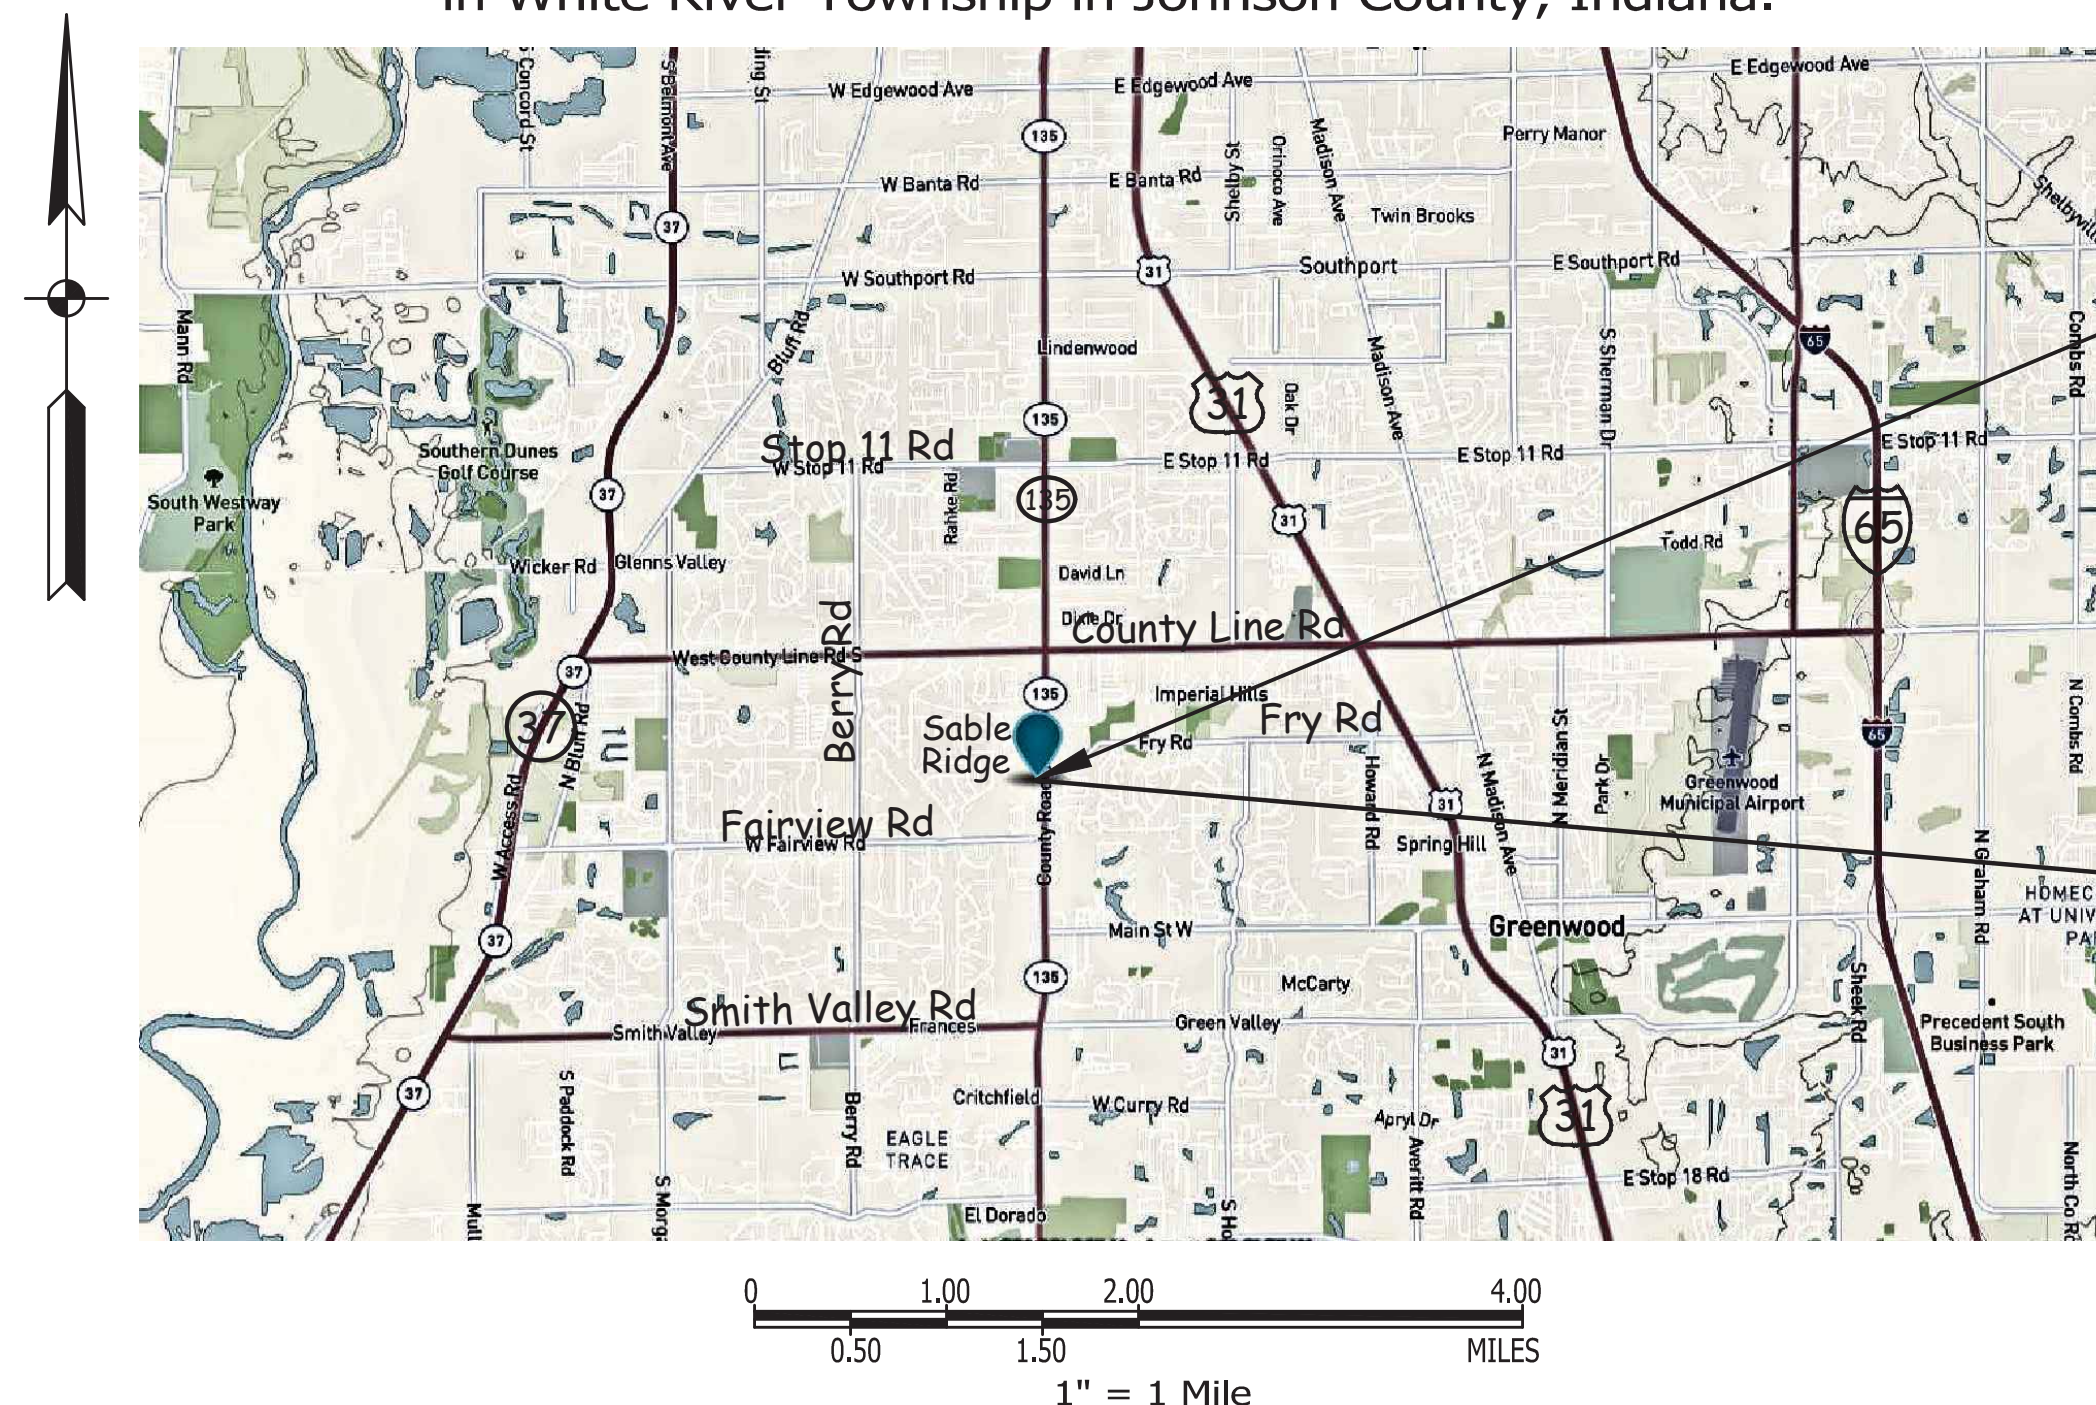


BRIDGE PLANS FOR SPANS OVER 20 FEET JOHNSON COUNTY BRIDGE NO. 605 FRY ROAD OVER PLEASANT RUN CREEK

PROJECT NO. 2200136 P.E.
R/W
2200136 CONST.

NO ADDITIONAL RIGHT-OF-WAY
REQUIRED FOR THIS PROJECT.

Bridge Replacement Project on Fry Road over Pleasant Run Creek located 0.03 miles west of SR 135 in Section 26, Township 14 North, Range 3 East in White River Township in Johnson County, Indiana.




PROJECT LOCATION

END PROJECT 2200136, 14+12.76 "A"
STR. NO. 41-00124
STA. 13+03.50 "A"
FRY ROAD OVER PLEASANT RUN CREEK
DES. NO. 2200136
BEGIN PROJECT 2200136, 11+66.12 "A"

TRAFFIC DATA	FRY ROAD
A.A.D.T. (2023)	620 V.P.D.
A.A.D.T. (2043)	685 V.P.D.
D.H.V. (2043)	125 V.P.H.
DIRECTIONAL DISTRIBUTION	50%
TRUCKS	2% A.A.D.T. 2% D.H.V.

DESIGN DATA	
DESIGN SPEED	35 MPH
PROJECT DESIGN CRITERIA	3R (NON-FREEWAY)
FUNCTIONAL CLASSIFICATION	LOCAL STREET
RURAL/URBAN	URBAN (BUILT-UP)
TERRAIN	LEVEL
ACCESS CONTROL	NONE

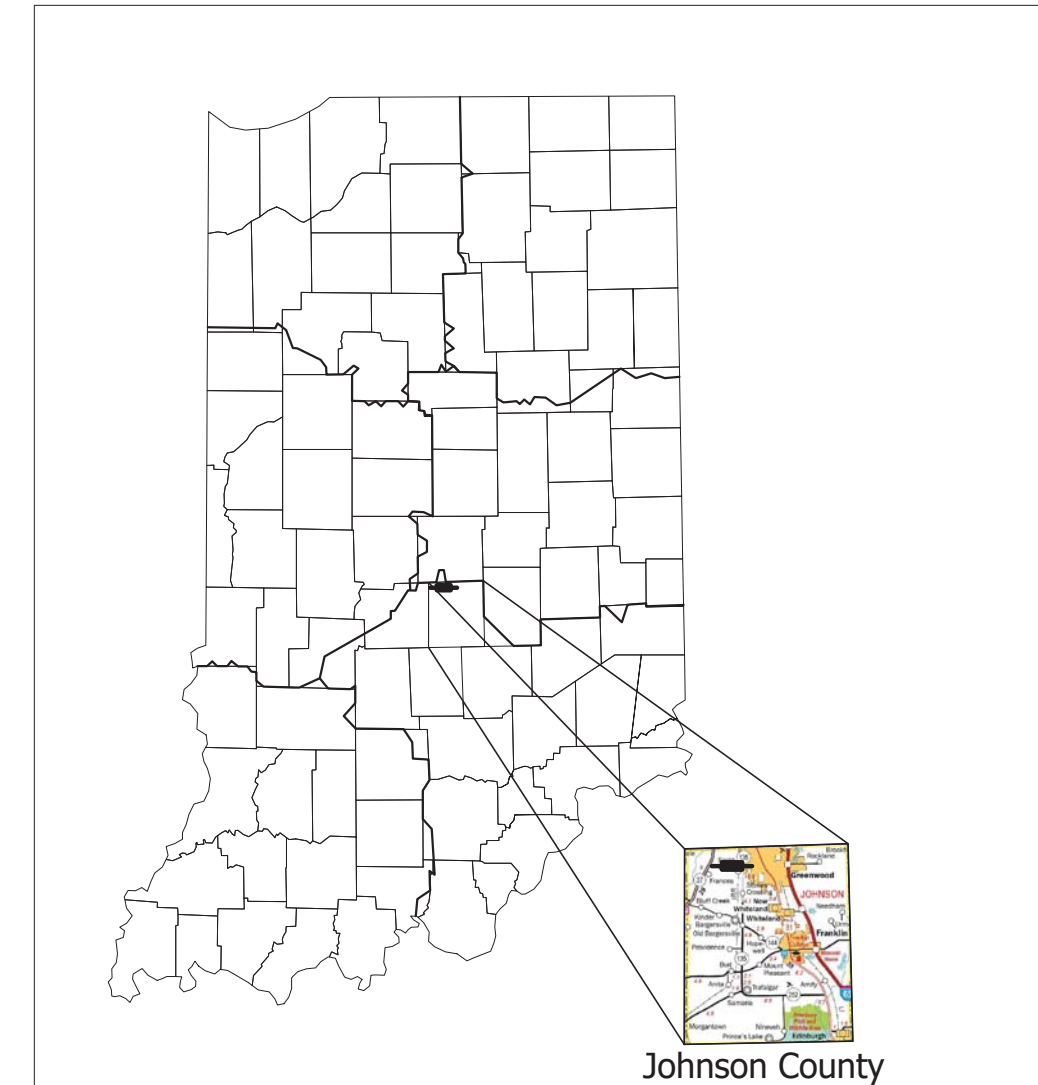

PROJECT LOCATION SHOWN BY —

LATITUDE: N 39°37'29.5" LONGITUDE: W 86°09'32.4"

BRIDGE LENGTH:	0.028	MI.
ROAD LENGTH:	0.019	MI.
TOTAL LENGTH:	0.047	MI.
MAX. GRADE:	2.072%	%

HUC: 05120201130110

STAGE 3 PLANS
MAY 2023


INDIANA DEPARTMENT OF TRANSPORTATION
STANDARD SPECIFICATIONS DATED 2024
TO BE USED WITH THESE PLANS.

NOT FOR CONSTRUCTION

PLANS PREPARED BY: **CrossRoad Engineers, P.C.** 317.780.1555
PHONE NUMBER
CERTIFIED BY: _____ 05/31/2023
DATE
APPROVED FOR LETTING: _____
INDIANA DEPARTMENT OF TRANSPORTATION DATE


BRIDGE FILE	
JOHNSON 605	
DESIGNATION	
2200136	
SURVEY BOOK	SHEETS
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CONTRACT	PROJECT
B-44295	2200136

DIRECTORY PATH: I:\Active\Johnson County\Bridges\605\Design\Coord\Plans
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FRY ROAD SECTION AT WEST PROJECT END

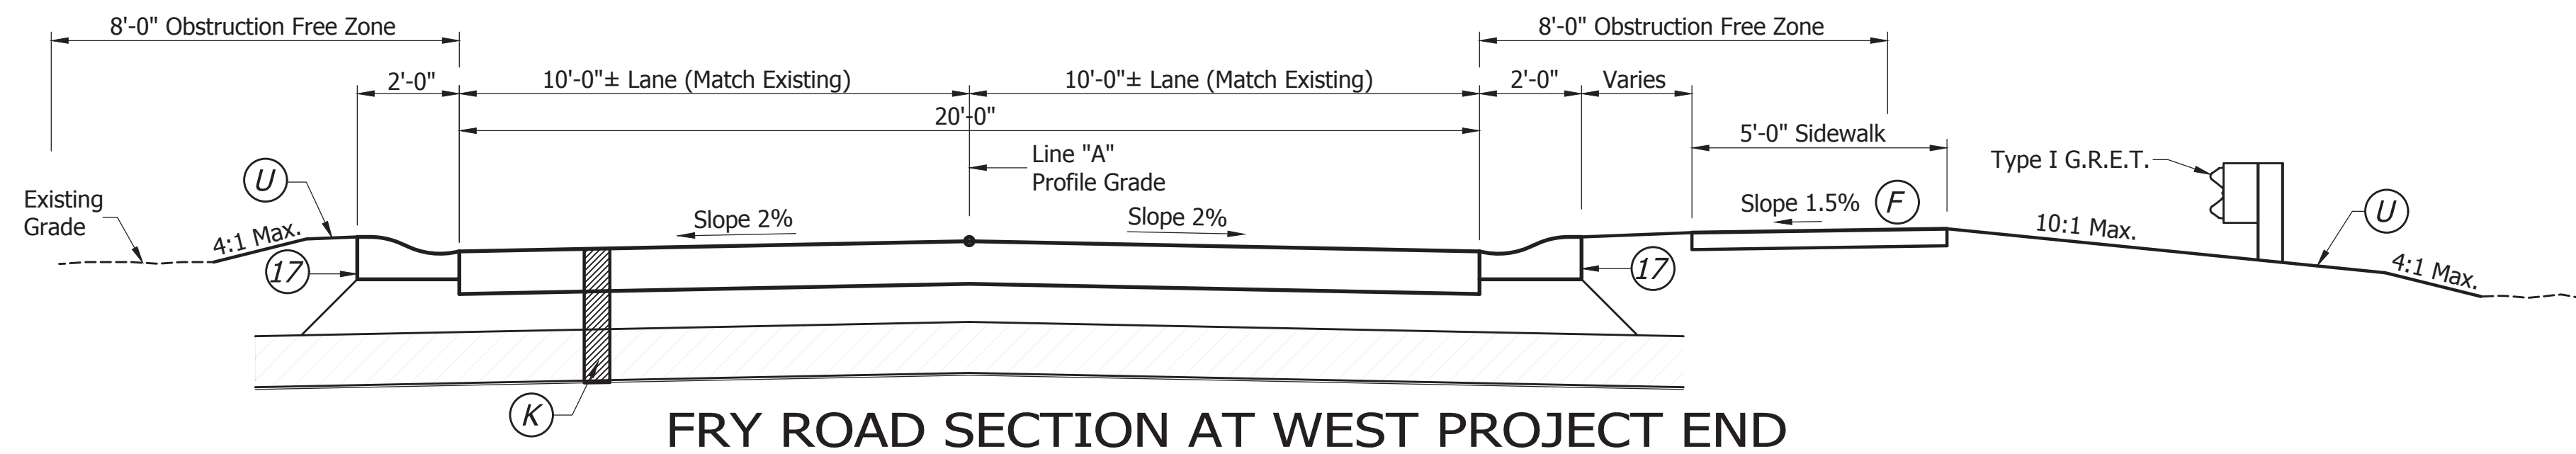
Scale: 3/8"=1'-0"
 STA. 11+66.12 "A" to 11+93.5 "A"



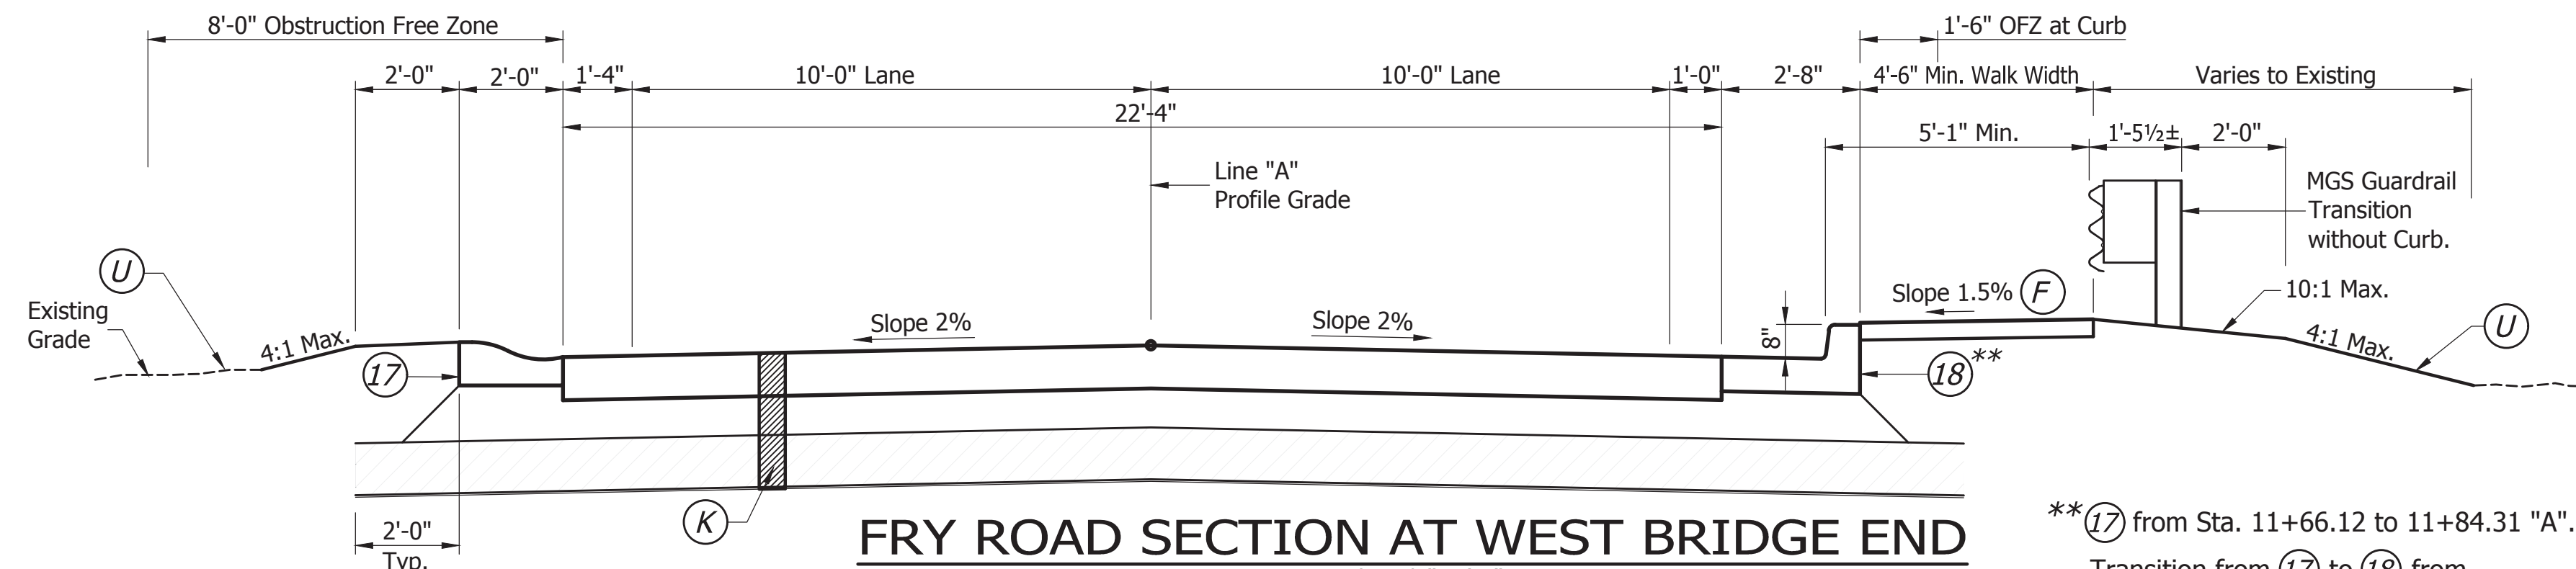FRY ROAD SECTION AT WEST BRIDGE END

Scale: 3/8"=1'-0"
 STA. 11+93.5 "A" to STA. 12+04.71 "A"
 See Notes to the Right

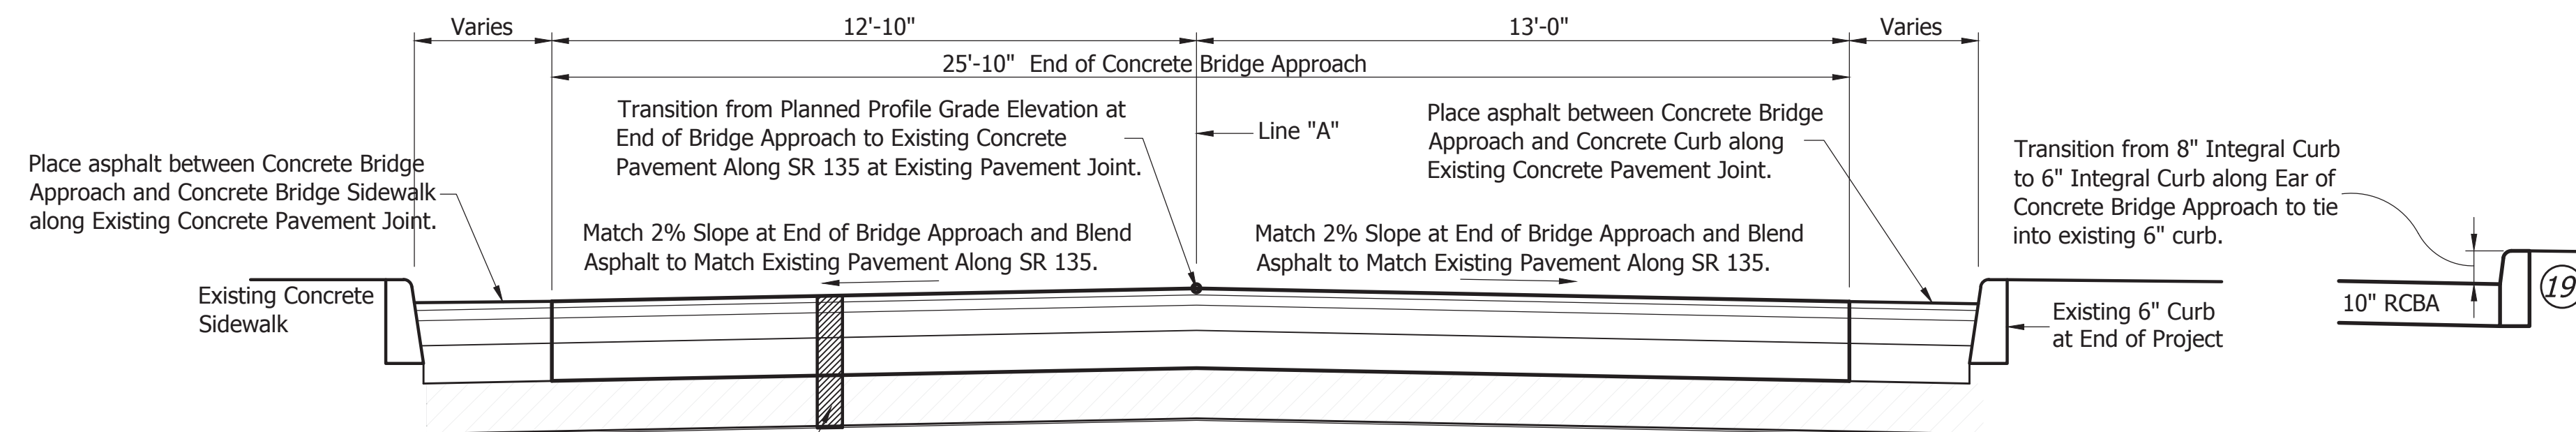
** (17) from Sta. 11+66.12 to 11+84.31 "A".
 Transition from (17) to (18) from
 11+84.31 to 11+93.5 "A".



FRY ROAD SECTION AT EAST PROJECT END


Scale: 3/8"=1'-0"
 STA. 14+04.09 "A" to STA. 14+12.76 "A"
 Concrete Sleeper Slab starts Sta. 14+08.7

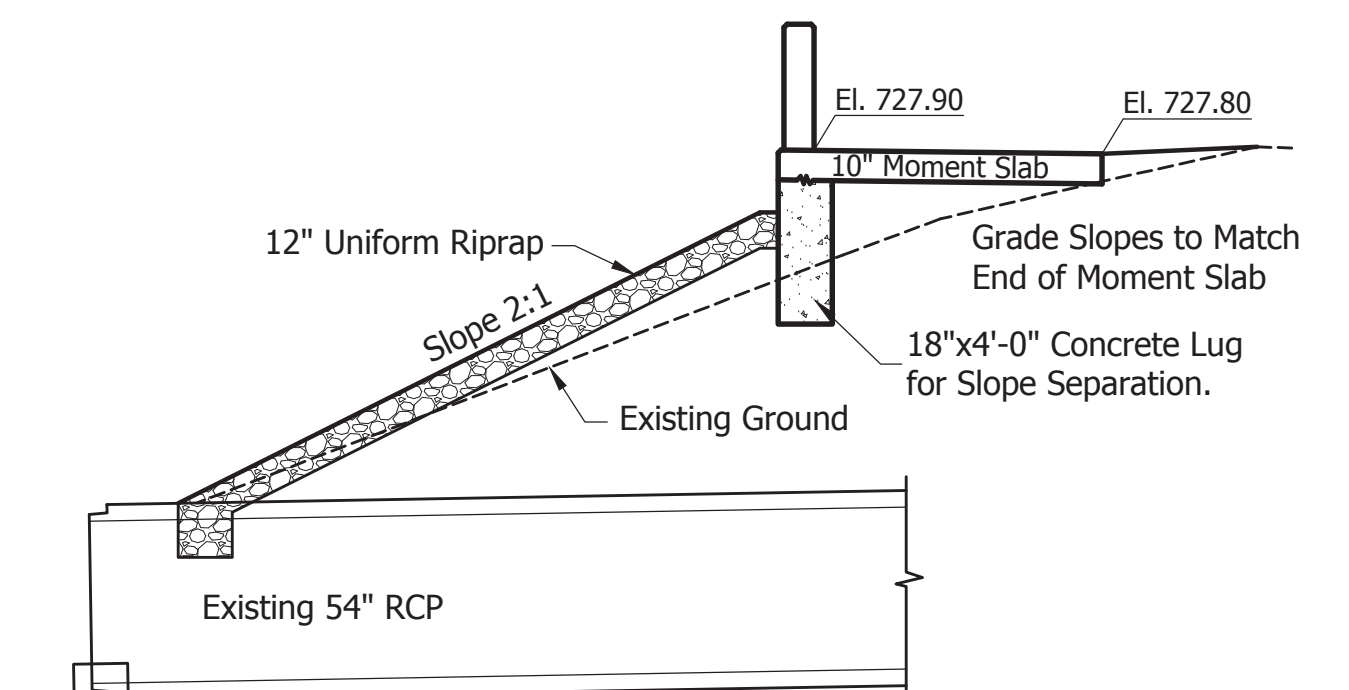- LEGEND**
- (K) **TERMINAL JOINT, TYPE PCCP**
 10" Jointed Reinforced Concrete Pavement on
 9" Subbase for PCCP on
 Subgrade Treatment, Type IC on
 Geotextile for Pavement, Type 2B
 - (J) **HMA FOR APPROACHES, TYPE B**
 165 lb/Syd. HMA Surface, Type B on
 275 lb/Syd. HMA Intermediate, Type B on
 660 lb/Syd. HMA Base, Type B on
 Subgrade Treatment Type IC on
 Geotextile for Pavement, Type 2B
 - (17) Concrete Rolled Curb
 - (18) Curb and Gutter, Concrete, Type C
 - (19) Integral Concrete Curb
 - (F) Concrete Sidewalk
 - (U) Seed Mix U with Fertilizer & Erosion Control Blanket




MOMENT SLAB SECTION

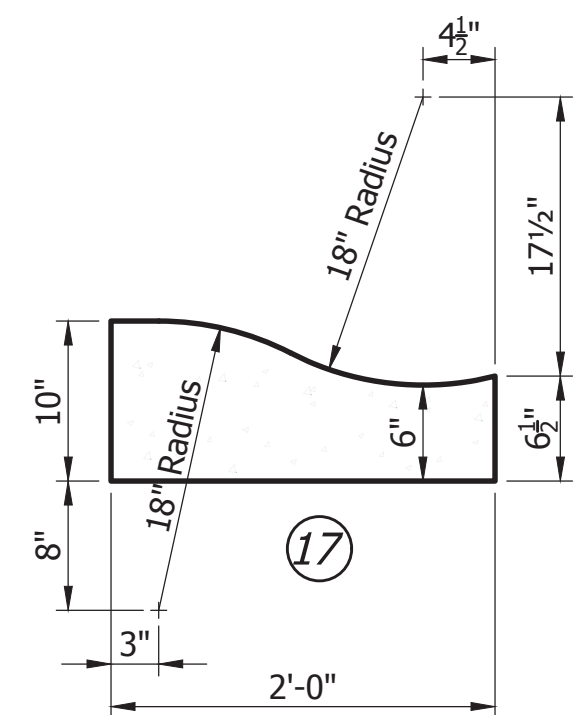
Scale: 3/16"=1'-0"
 EAST END OF PROJECT




CONCRETE ROLLED CURB

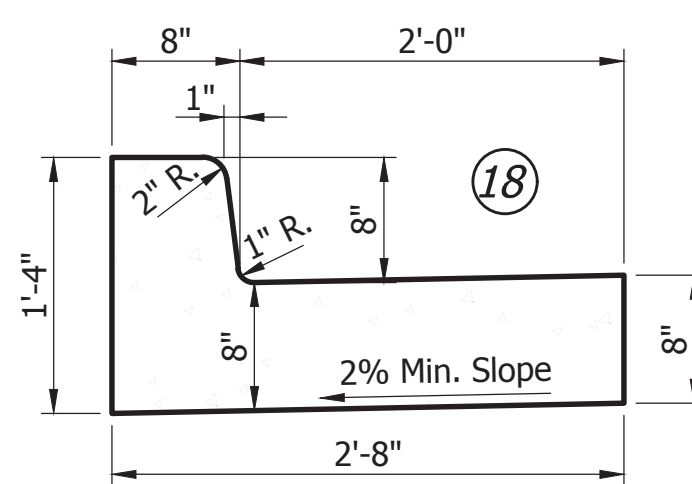

COMBINED CONCRETE CURB & GUTTER, TYPE C

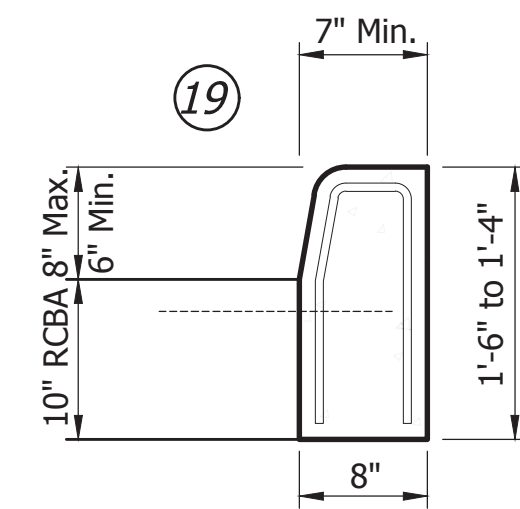

INTEGRAL CONCRETE CURB

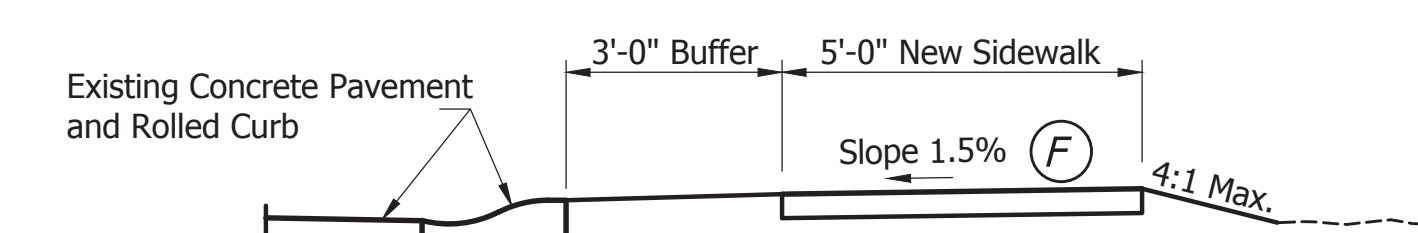

SIDEWALK SECTION

Scale: 3/8"=1'-0"
 Sta. 10+53 "A" to 11+83 "A"
 Buffer Varies Sta. 10+38 "A" to 10+53 "A"

Transition from Existing Sidewalk at Sta. 10+38 "A" with a 5'-wide angled walk to a 5'-0" Sidewalk with 3' Buffer at Sta. 10+53 "A".


NOT FOR CONSTRUCTION

RECOMMENDED FOR APPROVAL	DESIGN ENGINEER	DATE
	RDG	05/31/2023
DESIGNED: RDG	DRAWN: RDG	
CHECKED: MAM	CHECKED: MAM	

INDIANA DEPARTMENT OF TRANSPORTATION
 TYPICAL SECTIONS
 JOHNSON COUNTY BRIDGE NO. 605

SCALE	BRIDGE FILE
As Noted	JOHNSON 605
	DESIGNATION
	2200136
SURVEY BOOK	SHEETS
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CONTRACT	PROJECT
B-44295	2200136

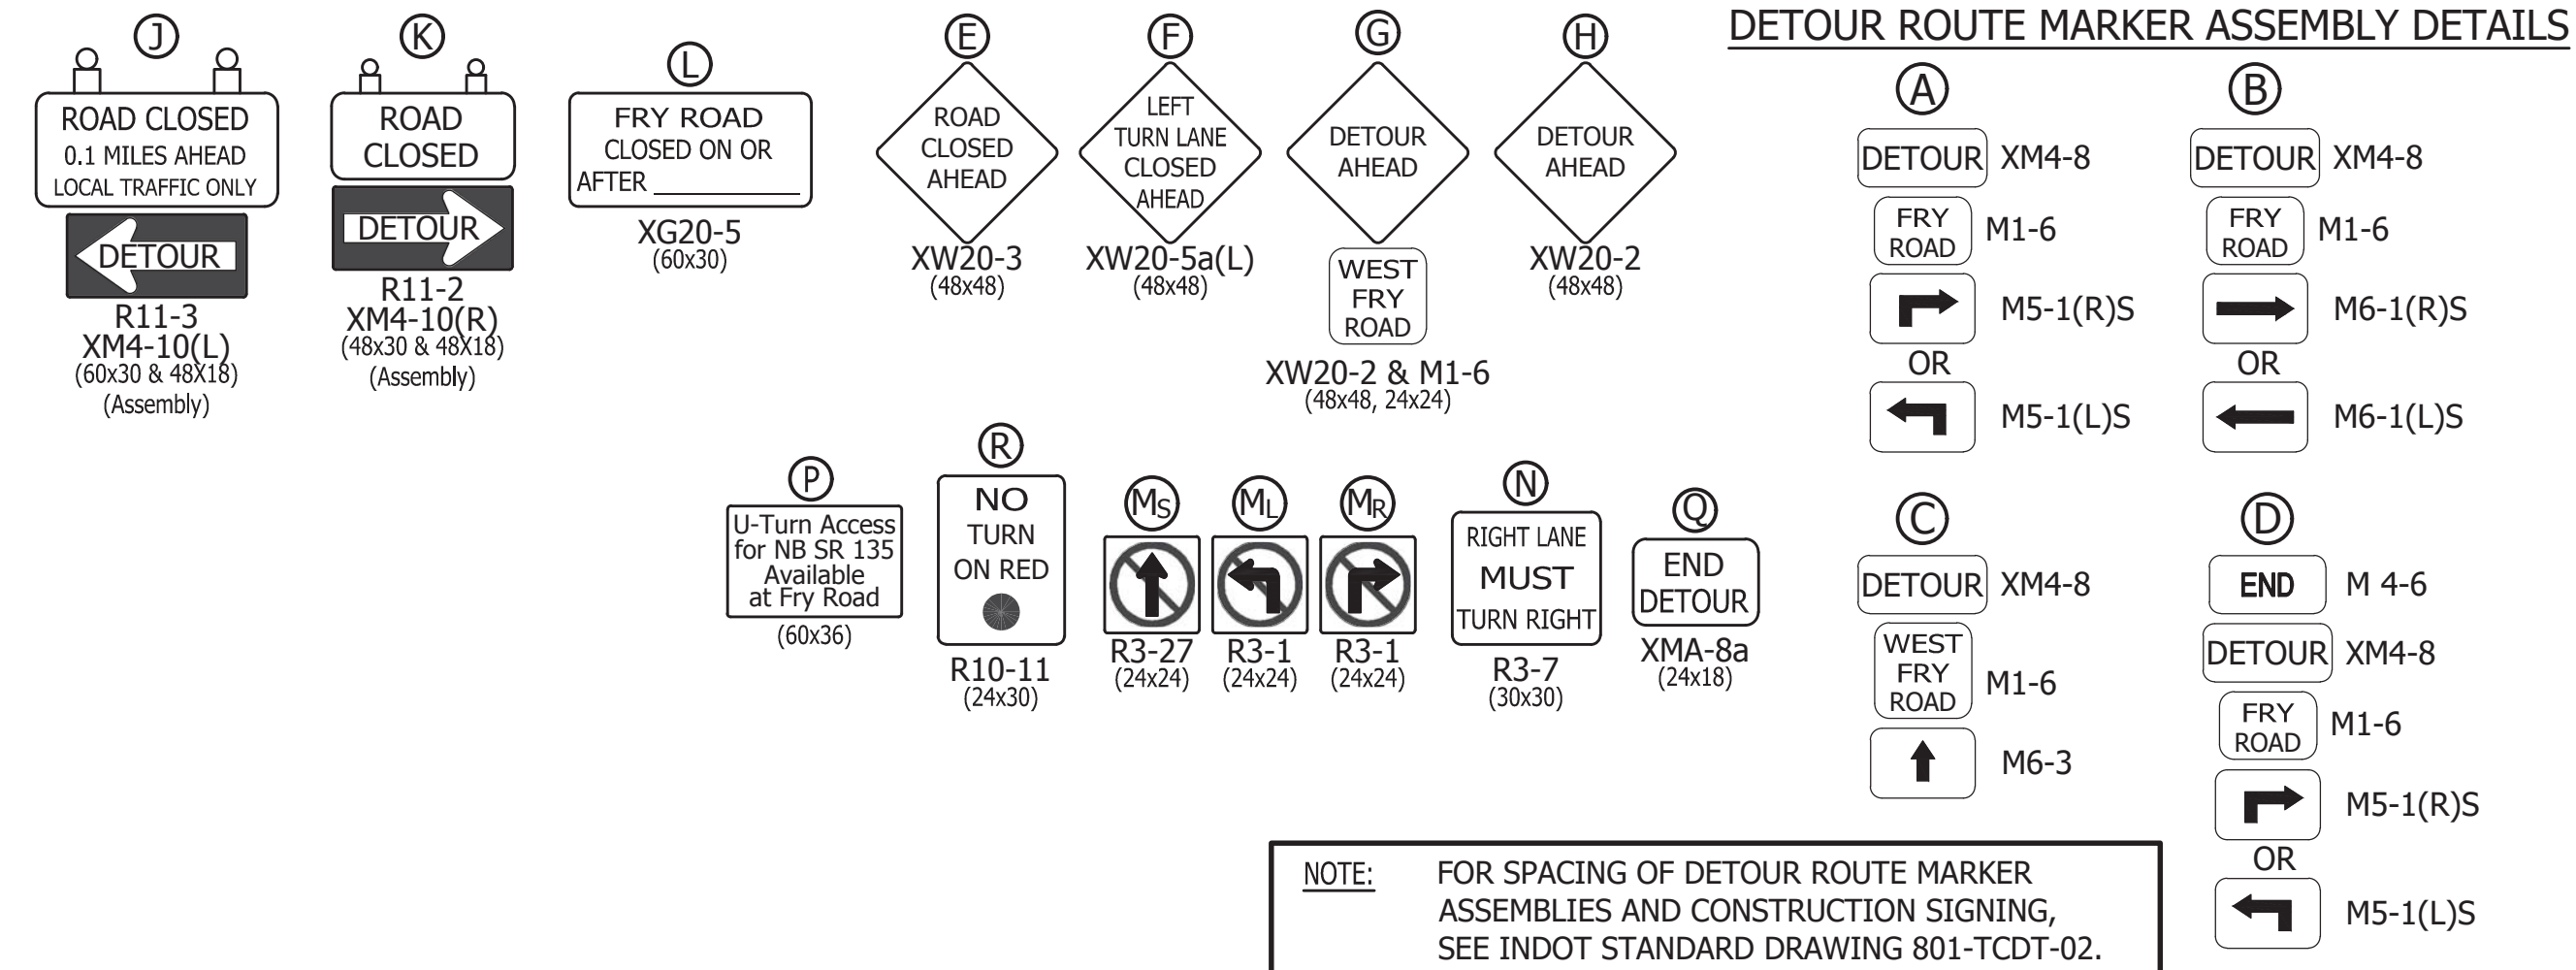DIRECTORY PATH : R:\Active\Johnson County\Bridge 605\Design\Cad\Plans
 DATE/USER : 5/31/2023 12:31 PM / Rgardner



NOTE: FOR SPACING OF DETOUR ROUTE MARKER ASSEMBLIES AND CONSTRUCTION SIGNING, SEE INDOT STANDARD DRAWING 801-TCDF-02.

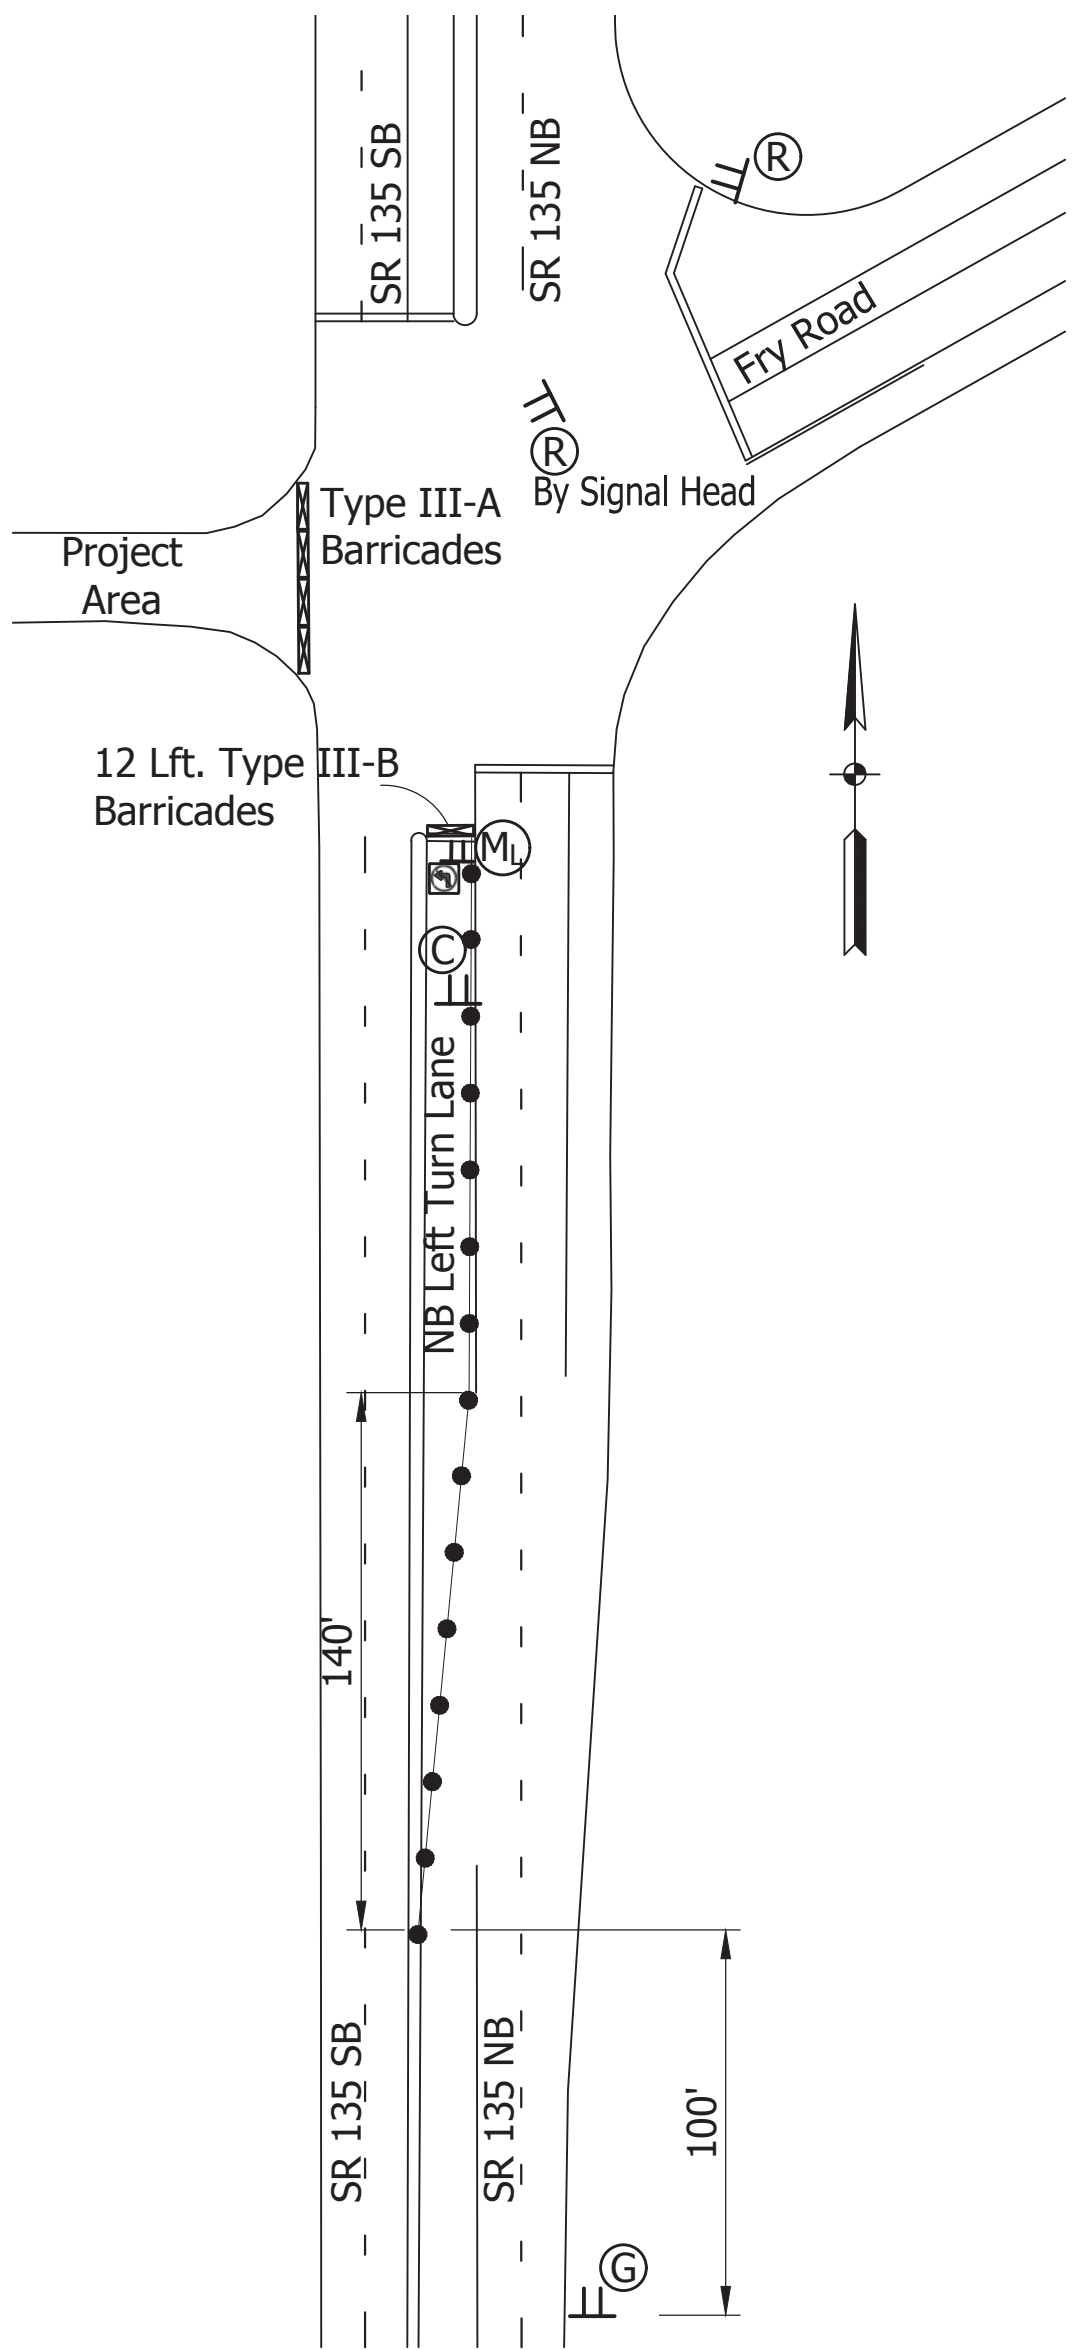
LEGEND

- TRAFFIC DRUM
- ▨ CONSTRUCTION AREA
- ➔ INDICATES TRAFFIC FLOW
- DETOUR ROUTE TRAFFIC FLOW
- ≡ TYPICAL CONSTRUCTION SIGN STANDARD
- ≡ ROAD CLOSURE SIGN ASSEMBLY
- ≡ TYPE III-A OR III-B BARRICADES
- ▨ TEMPORARY CONCRETE BARRIER, TYPE 2


(A) - (D) DETOUR ROUTE MARKER ASSEMBLY
(E) XW20-3, ROAD CLOSED AHEAD
(F) XW20-5, LEFT TURN LANE CLOSED AHEAD
(G) XW20-2, DETOUR AHEAD WITH M1-6 PLAQUE
(H) XW20-2, DETOUR AHEAD
(J) R11-3, ROAD CLOSED AHEAD SIGN ASSEMBLY
(K) R11-2, ROAD CLOSED SIGN ASSEMBLY
(L) XG20-5, ADVANCED ROAD CLOSURE NOTICE
Installed at least 14 Days prior to Road Closure with sign listing closing date at each end of Project Work Area.
(M) R3-1, NO LEFT (OR RIGHT, OR STRAIGHT) TURN
(N) R3-7, RIGHT LANE MUST TURN RIGHT
(Q) XMA-8a, END DETOUR
(P) TYPE C, U-TURN AVAILABLE SIGN
(R) R10-11, NO TURN ON RED

■■■■■■■ DETOUR ROUTE

NOTES:
 Type A Lights Required on all Construction Signs.
 Signing to be placed per Applicable Standard Drawings.
 Existing Pavement Markings to be Removed when in Conflict with M.O.T. Scheme.
 Channelizing Devices to be spaced per Standard Drawings.
 Signing to be placed per Applicable Standard Drawings.



SR 135 DETAIL "A"
Scale: 1"=50'

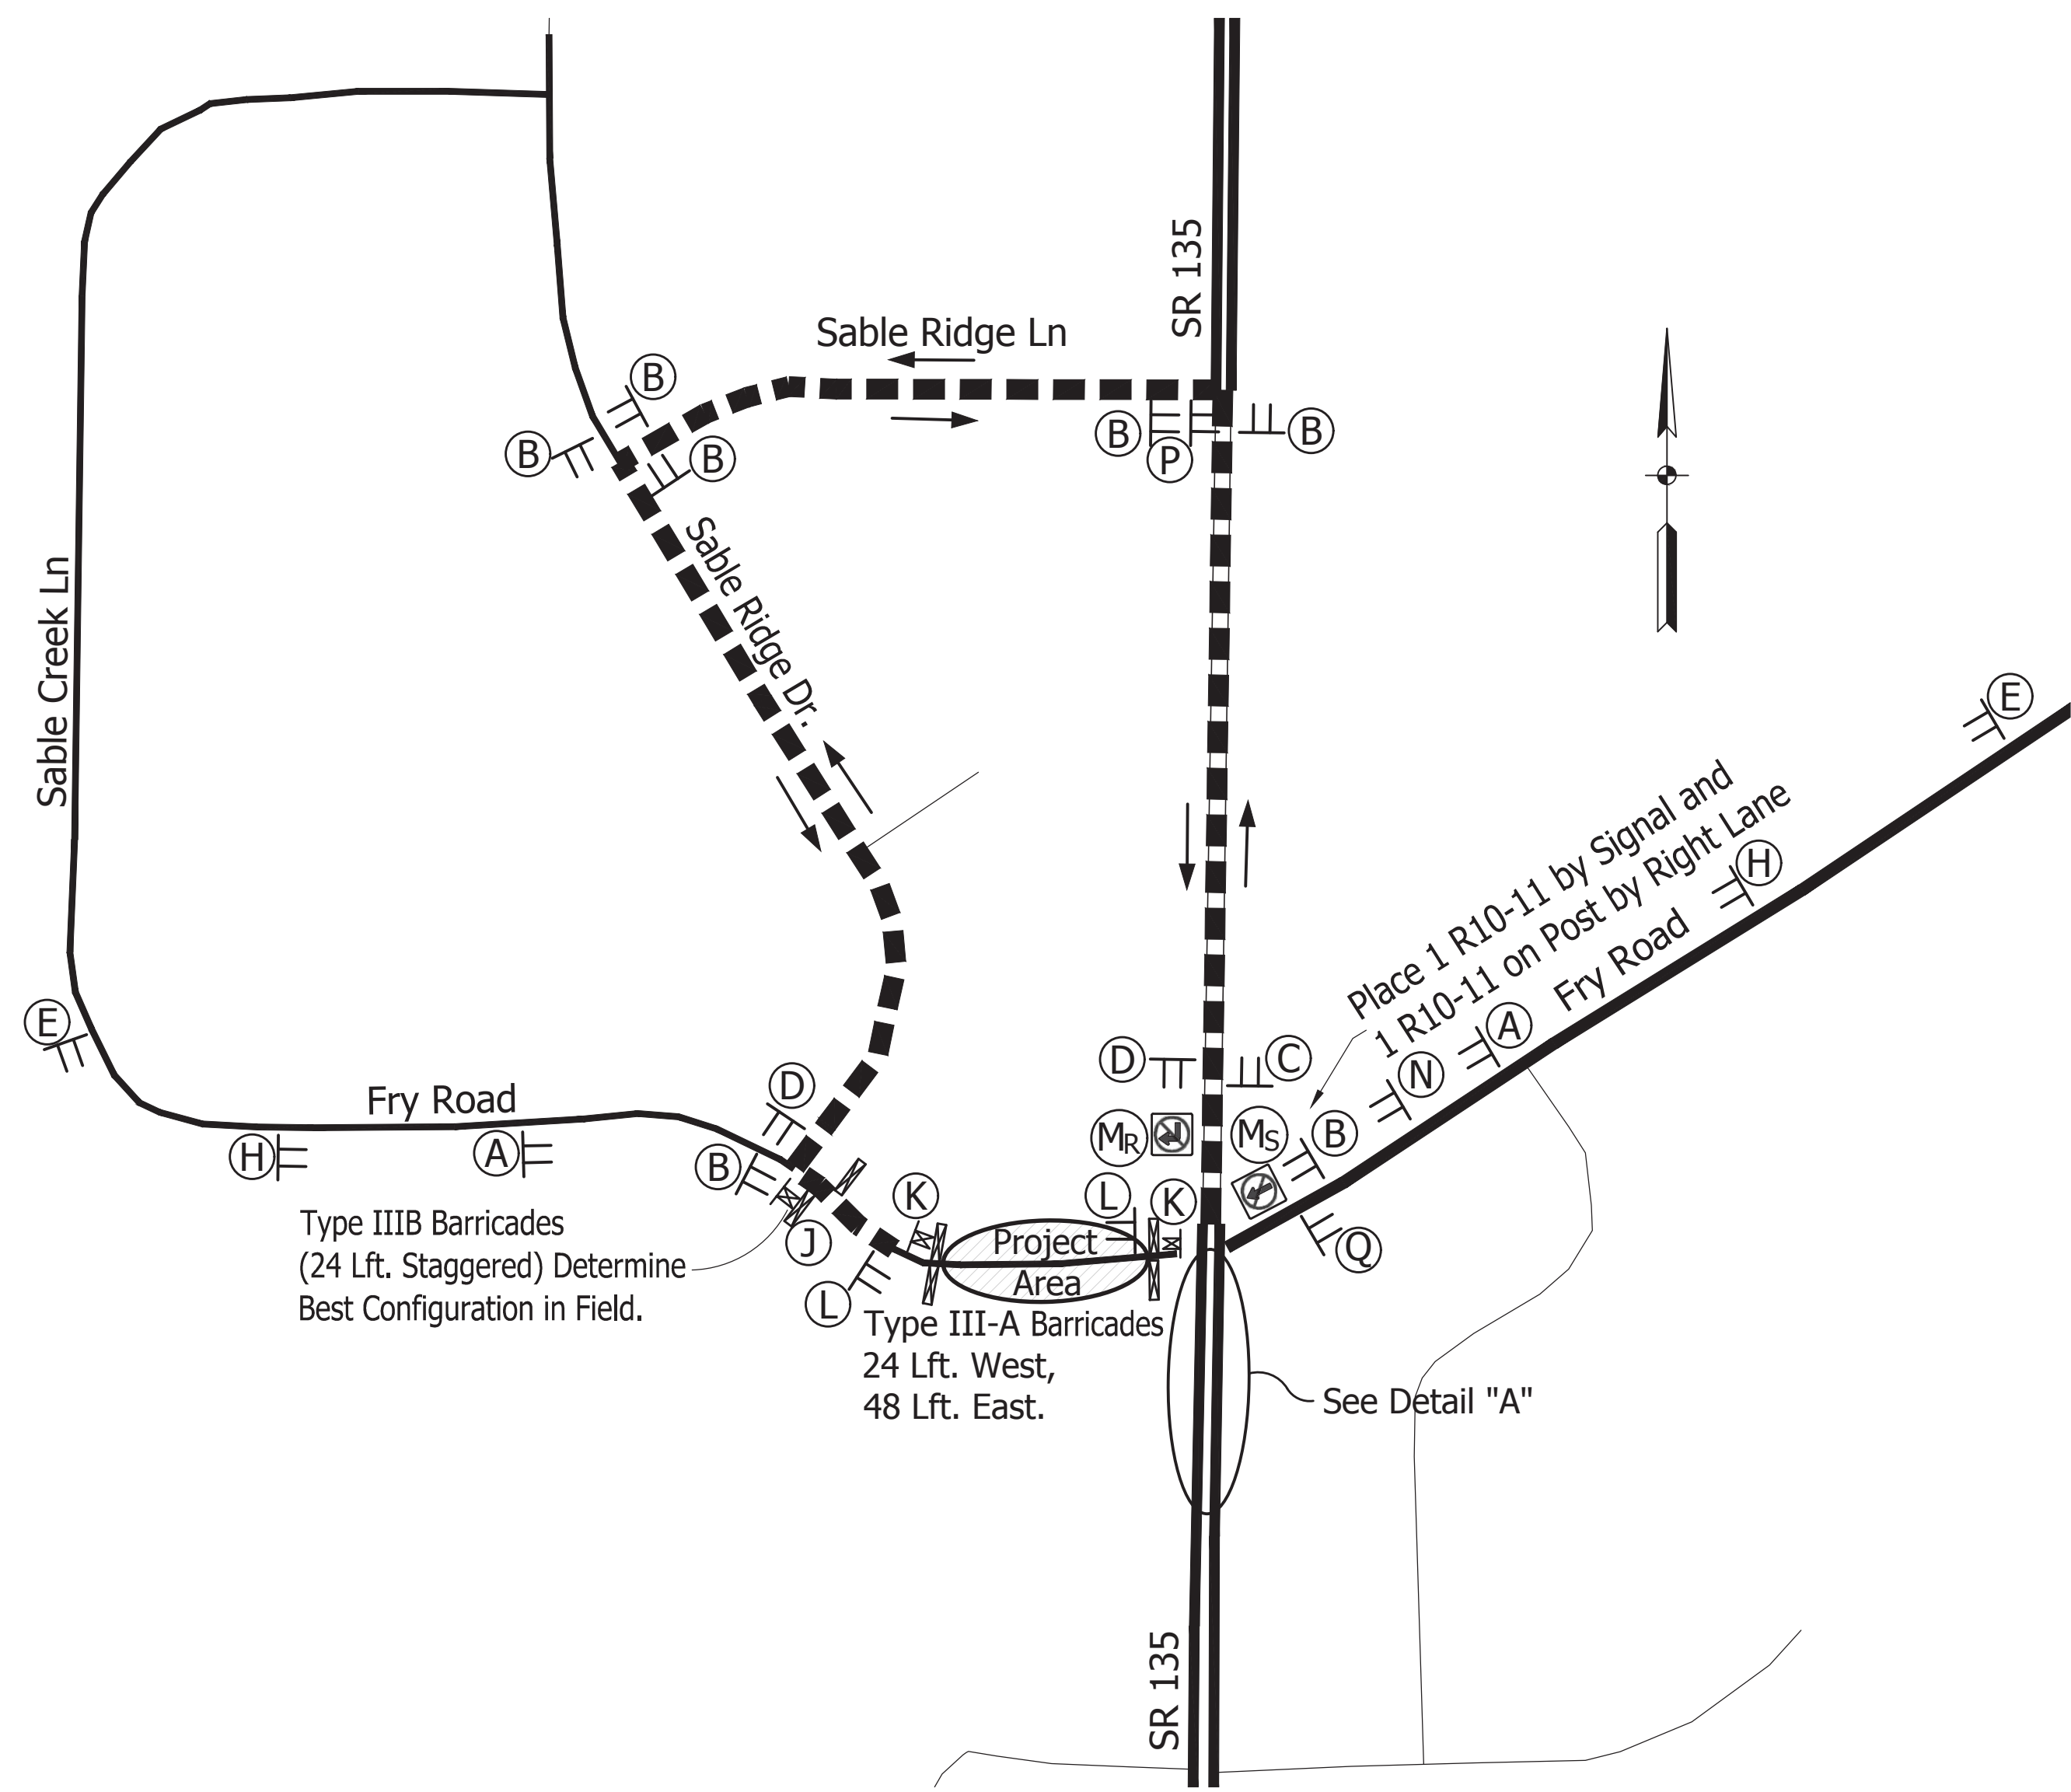

DETOUR ROUTE MAP & SIGNAGE
Scale: 1"=150'

Maintaining Traffic	1	LSum
Construction Sign, A	7	Each
Construction Sign, B	11	Each
Construction Sign, C	1	Each
Detour Route Marker Assembly	13	Each
Road Closure Sign Assembly	3	Each
Barricade, III-A	72	Lft.
Barricade, III-B	36	Lft.

M.O.T. ESTIMATE OF QUANTITIES




NOT FOR CONSTRUCTION

RECOMMENDED FOR APPROVAL	DESIGN ENGINEER	DATE
DESIGNED: RDG	DRAWN: RDG	05/31/2023
CHECKED: MAM	CHECKED: MAM	



INDIANA
DEPARTMENT OF TRANSPORTATION
MAINTENANCE OF TRAFFIC & DETOUR
JOHNSON COUNTY BRIDGE NO. 605

SCALE	BRIDGE FILE
As Noted	JOHNSON 605
	DESIGNATION
	2200136
SURVEY BOOK	SHEETS
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CONTRACT	PROJECT
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 DATE/USER : 05/31/2023 12:32 PM / Rlgardner

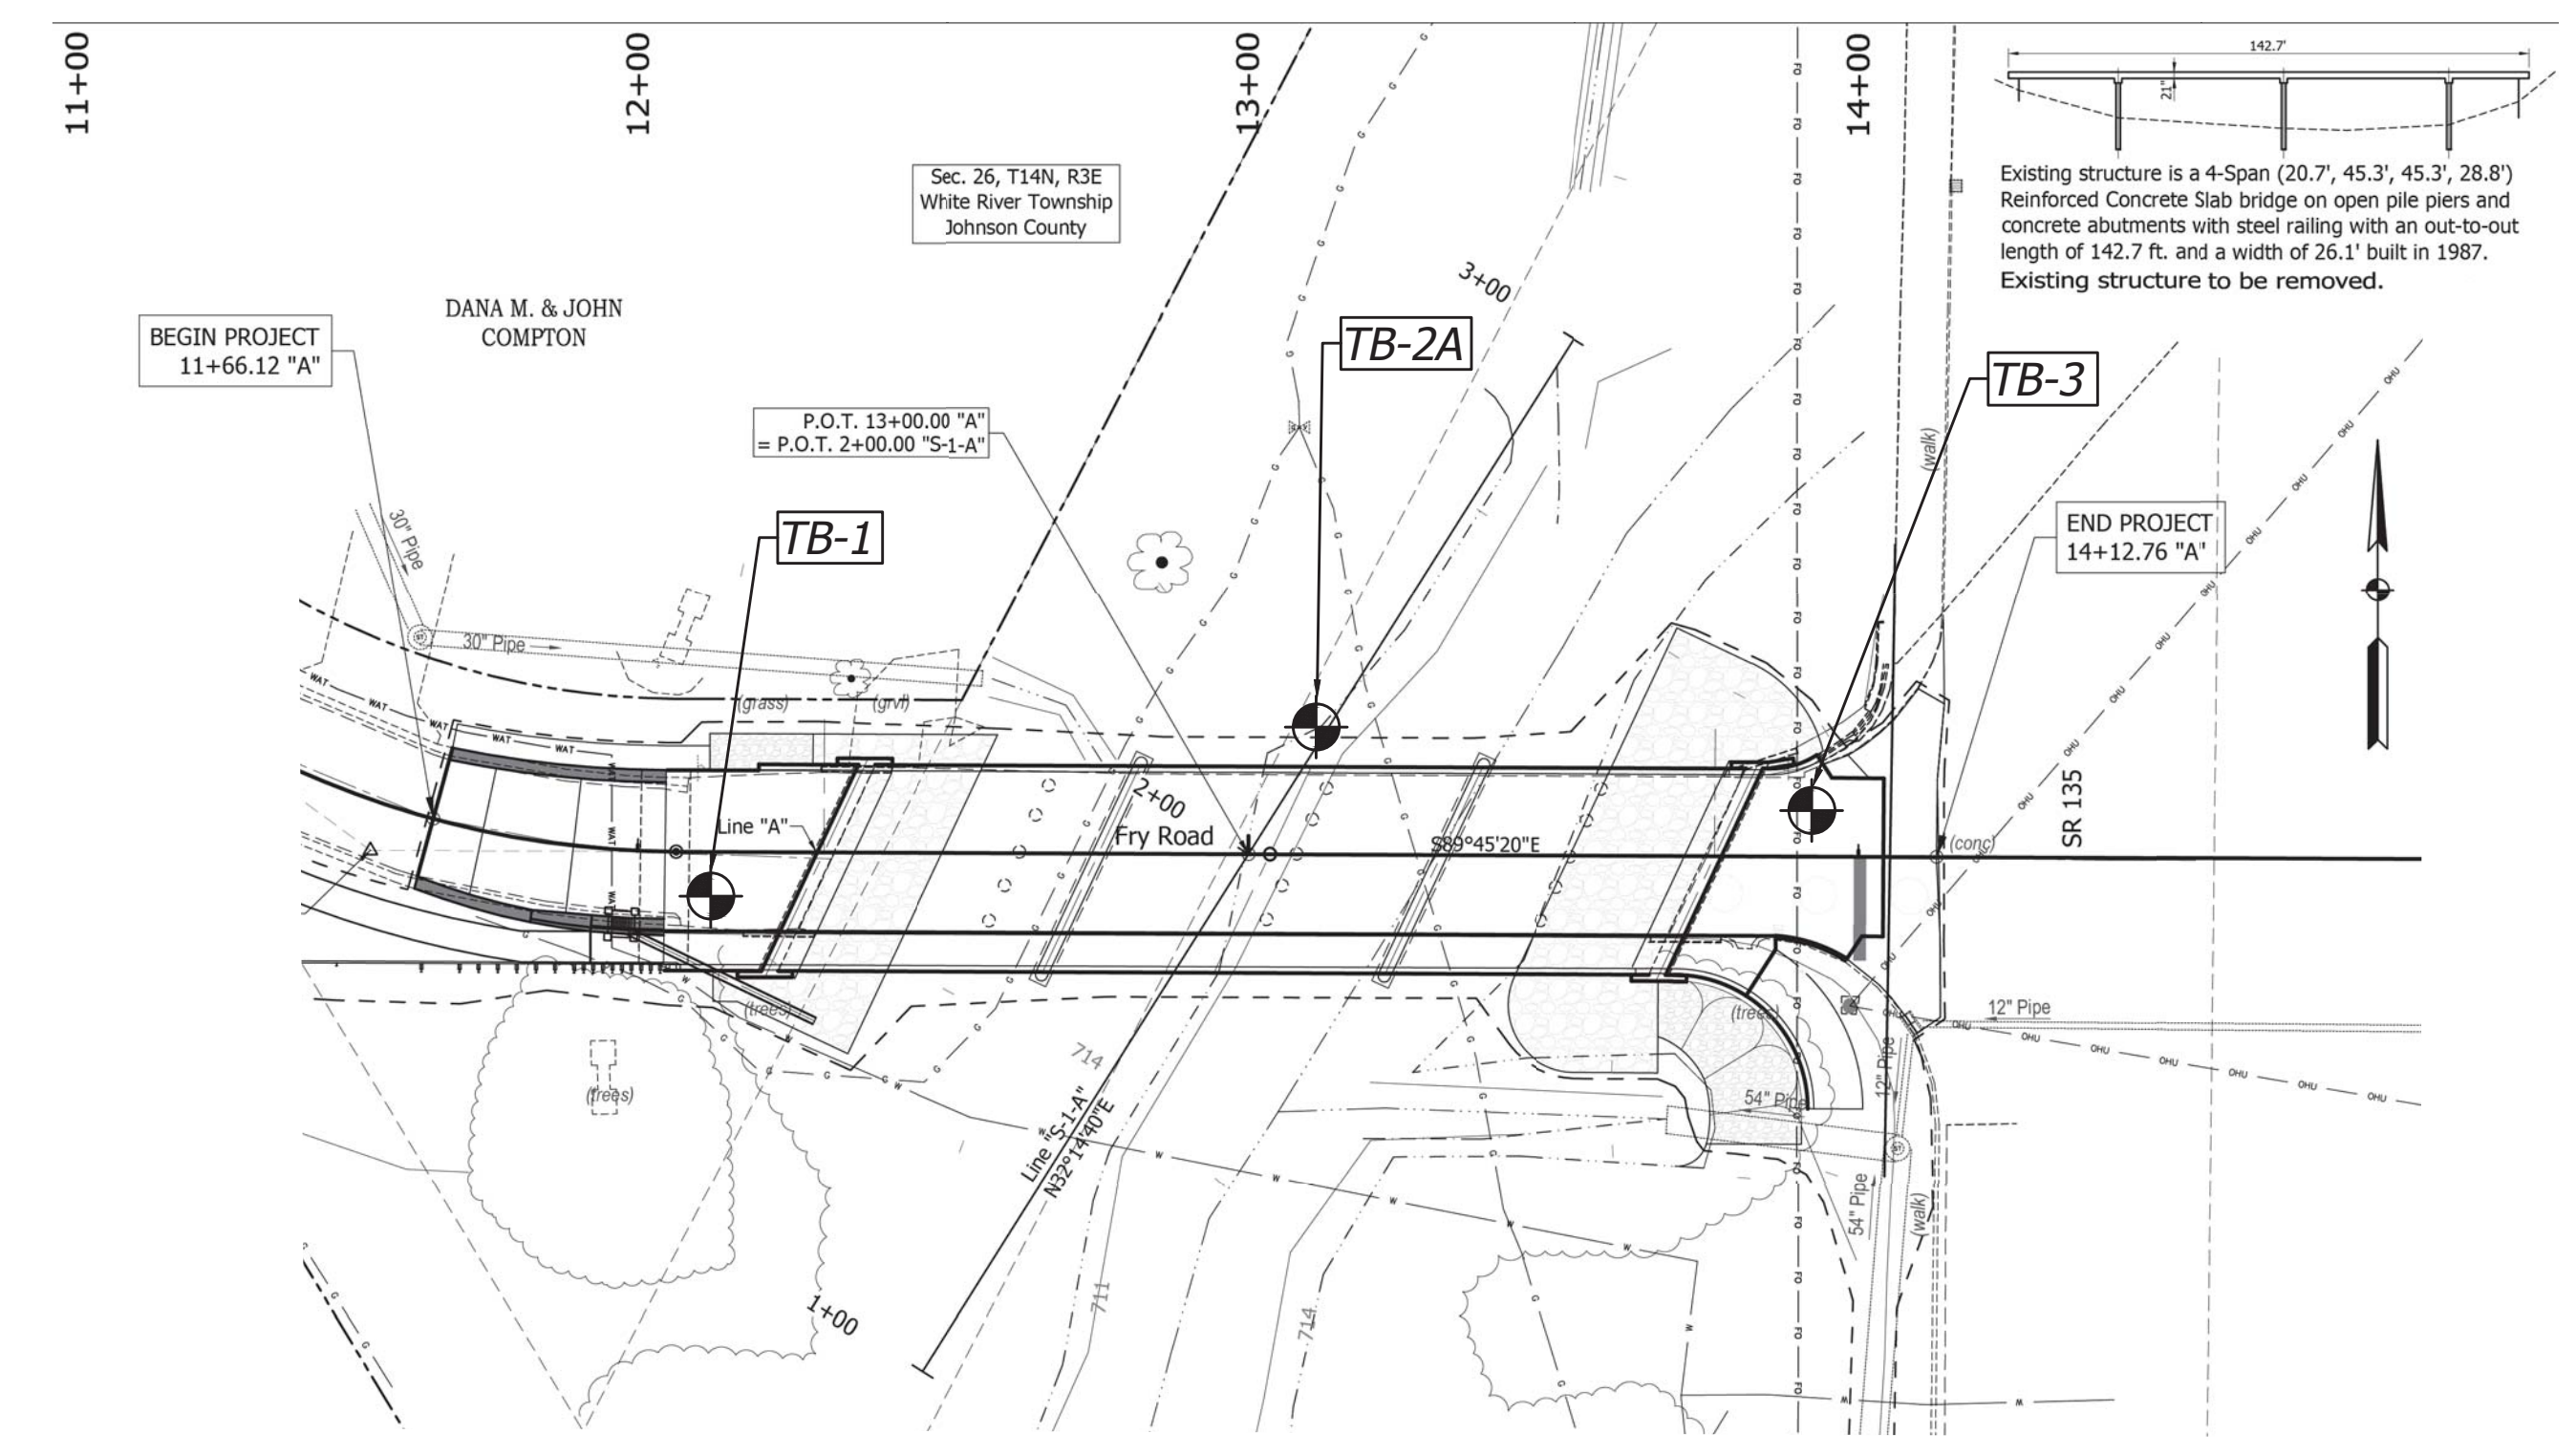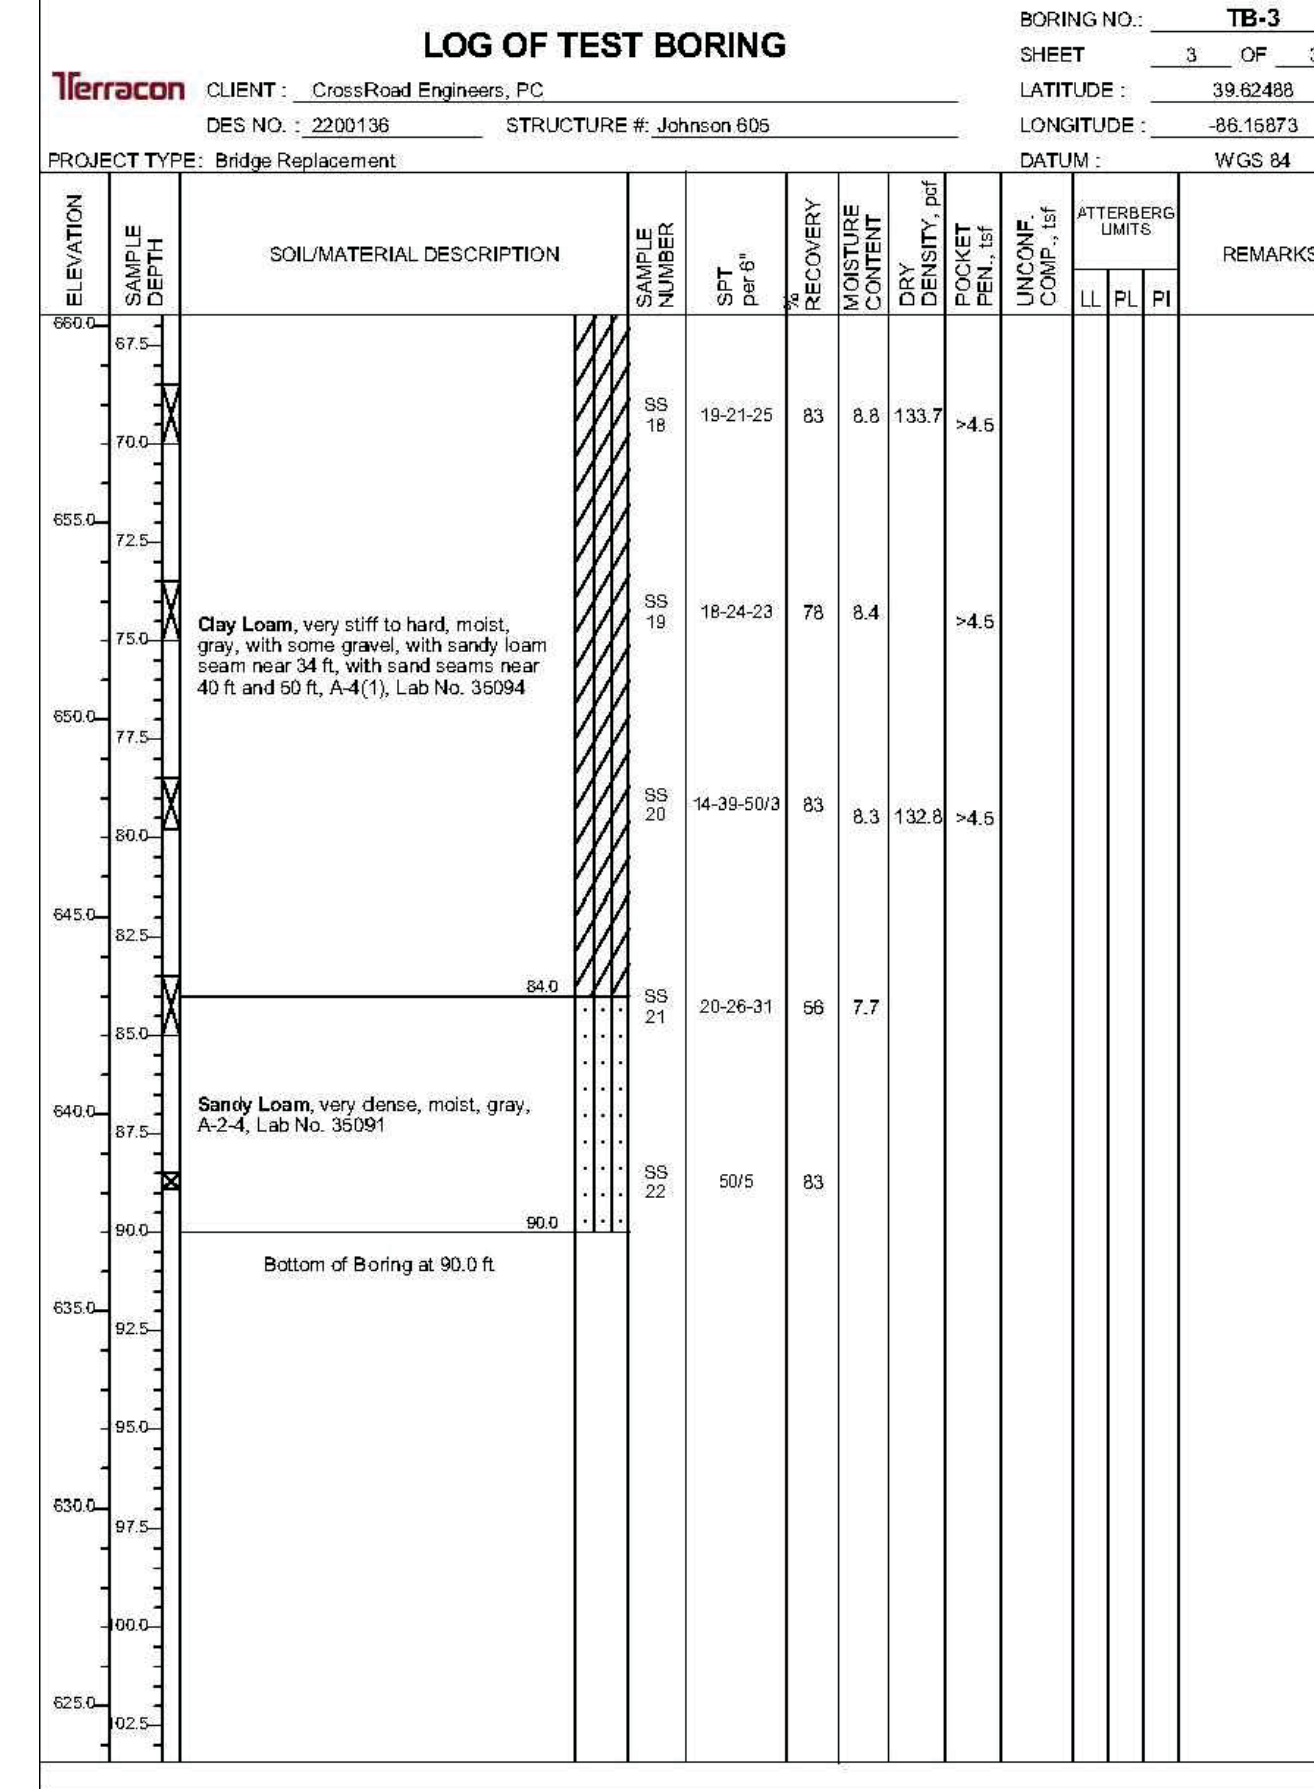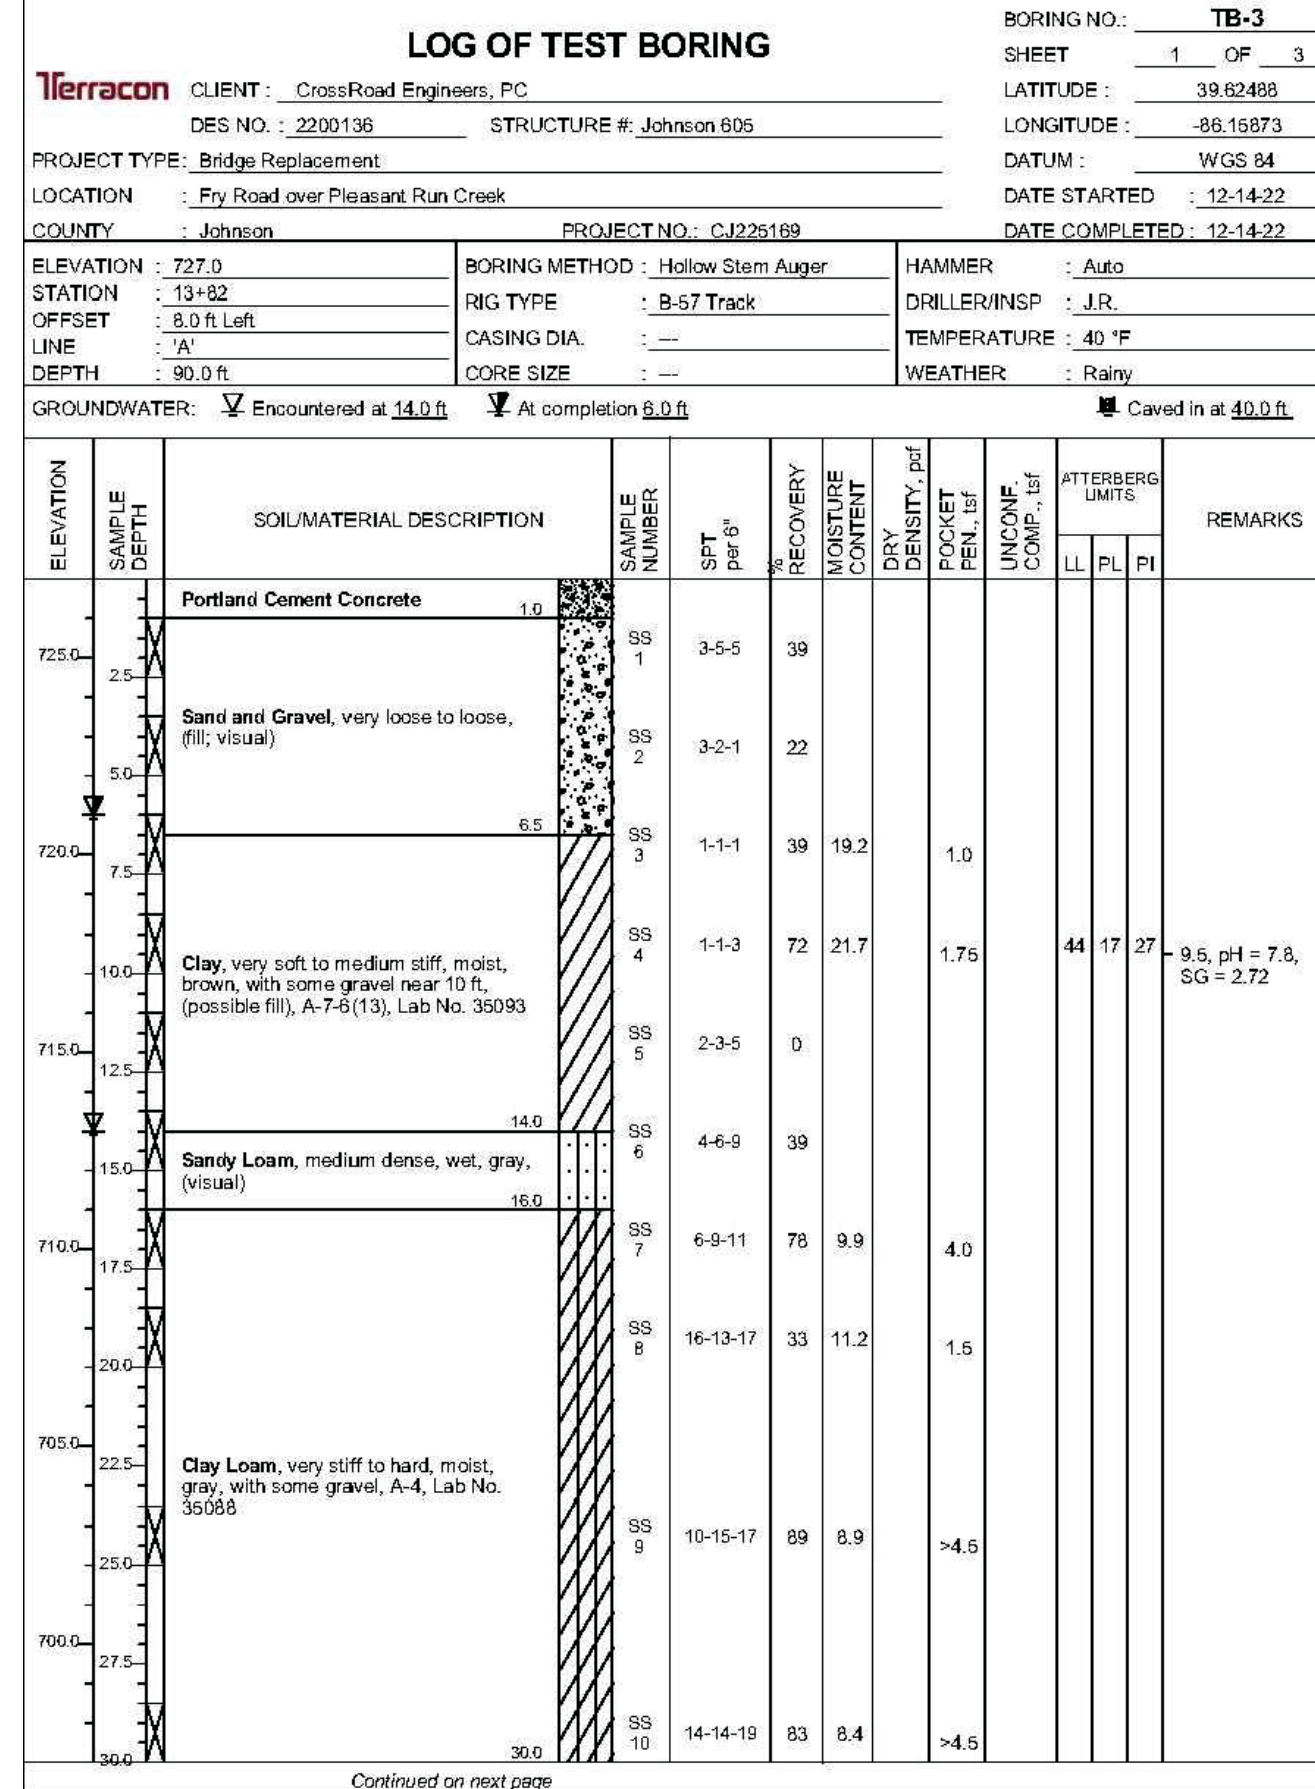

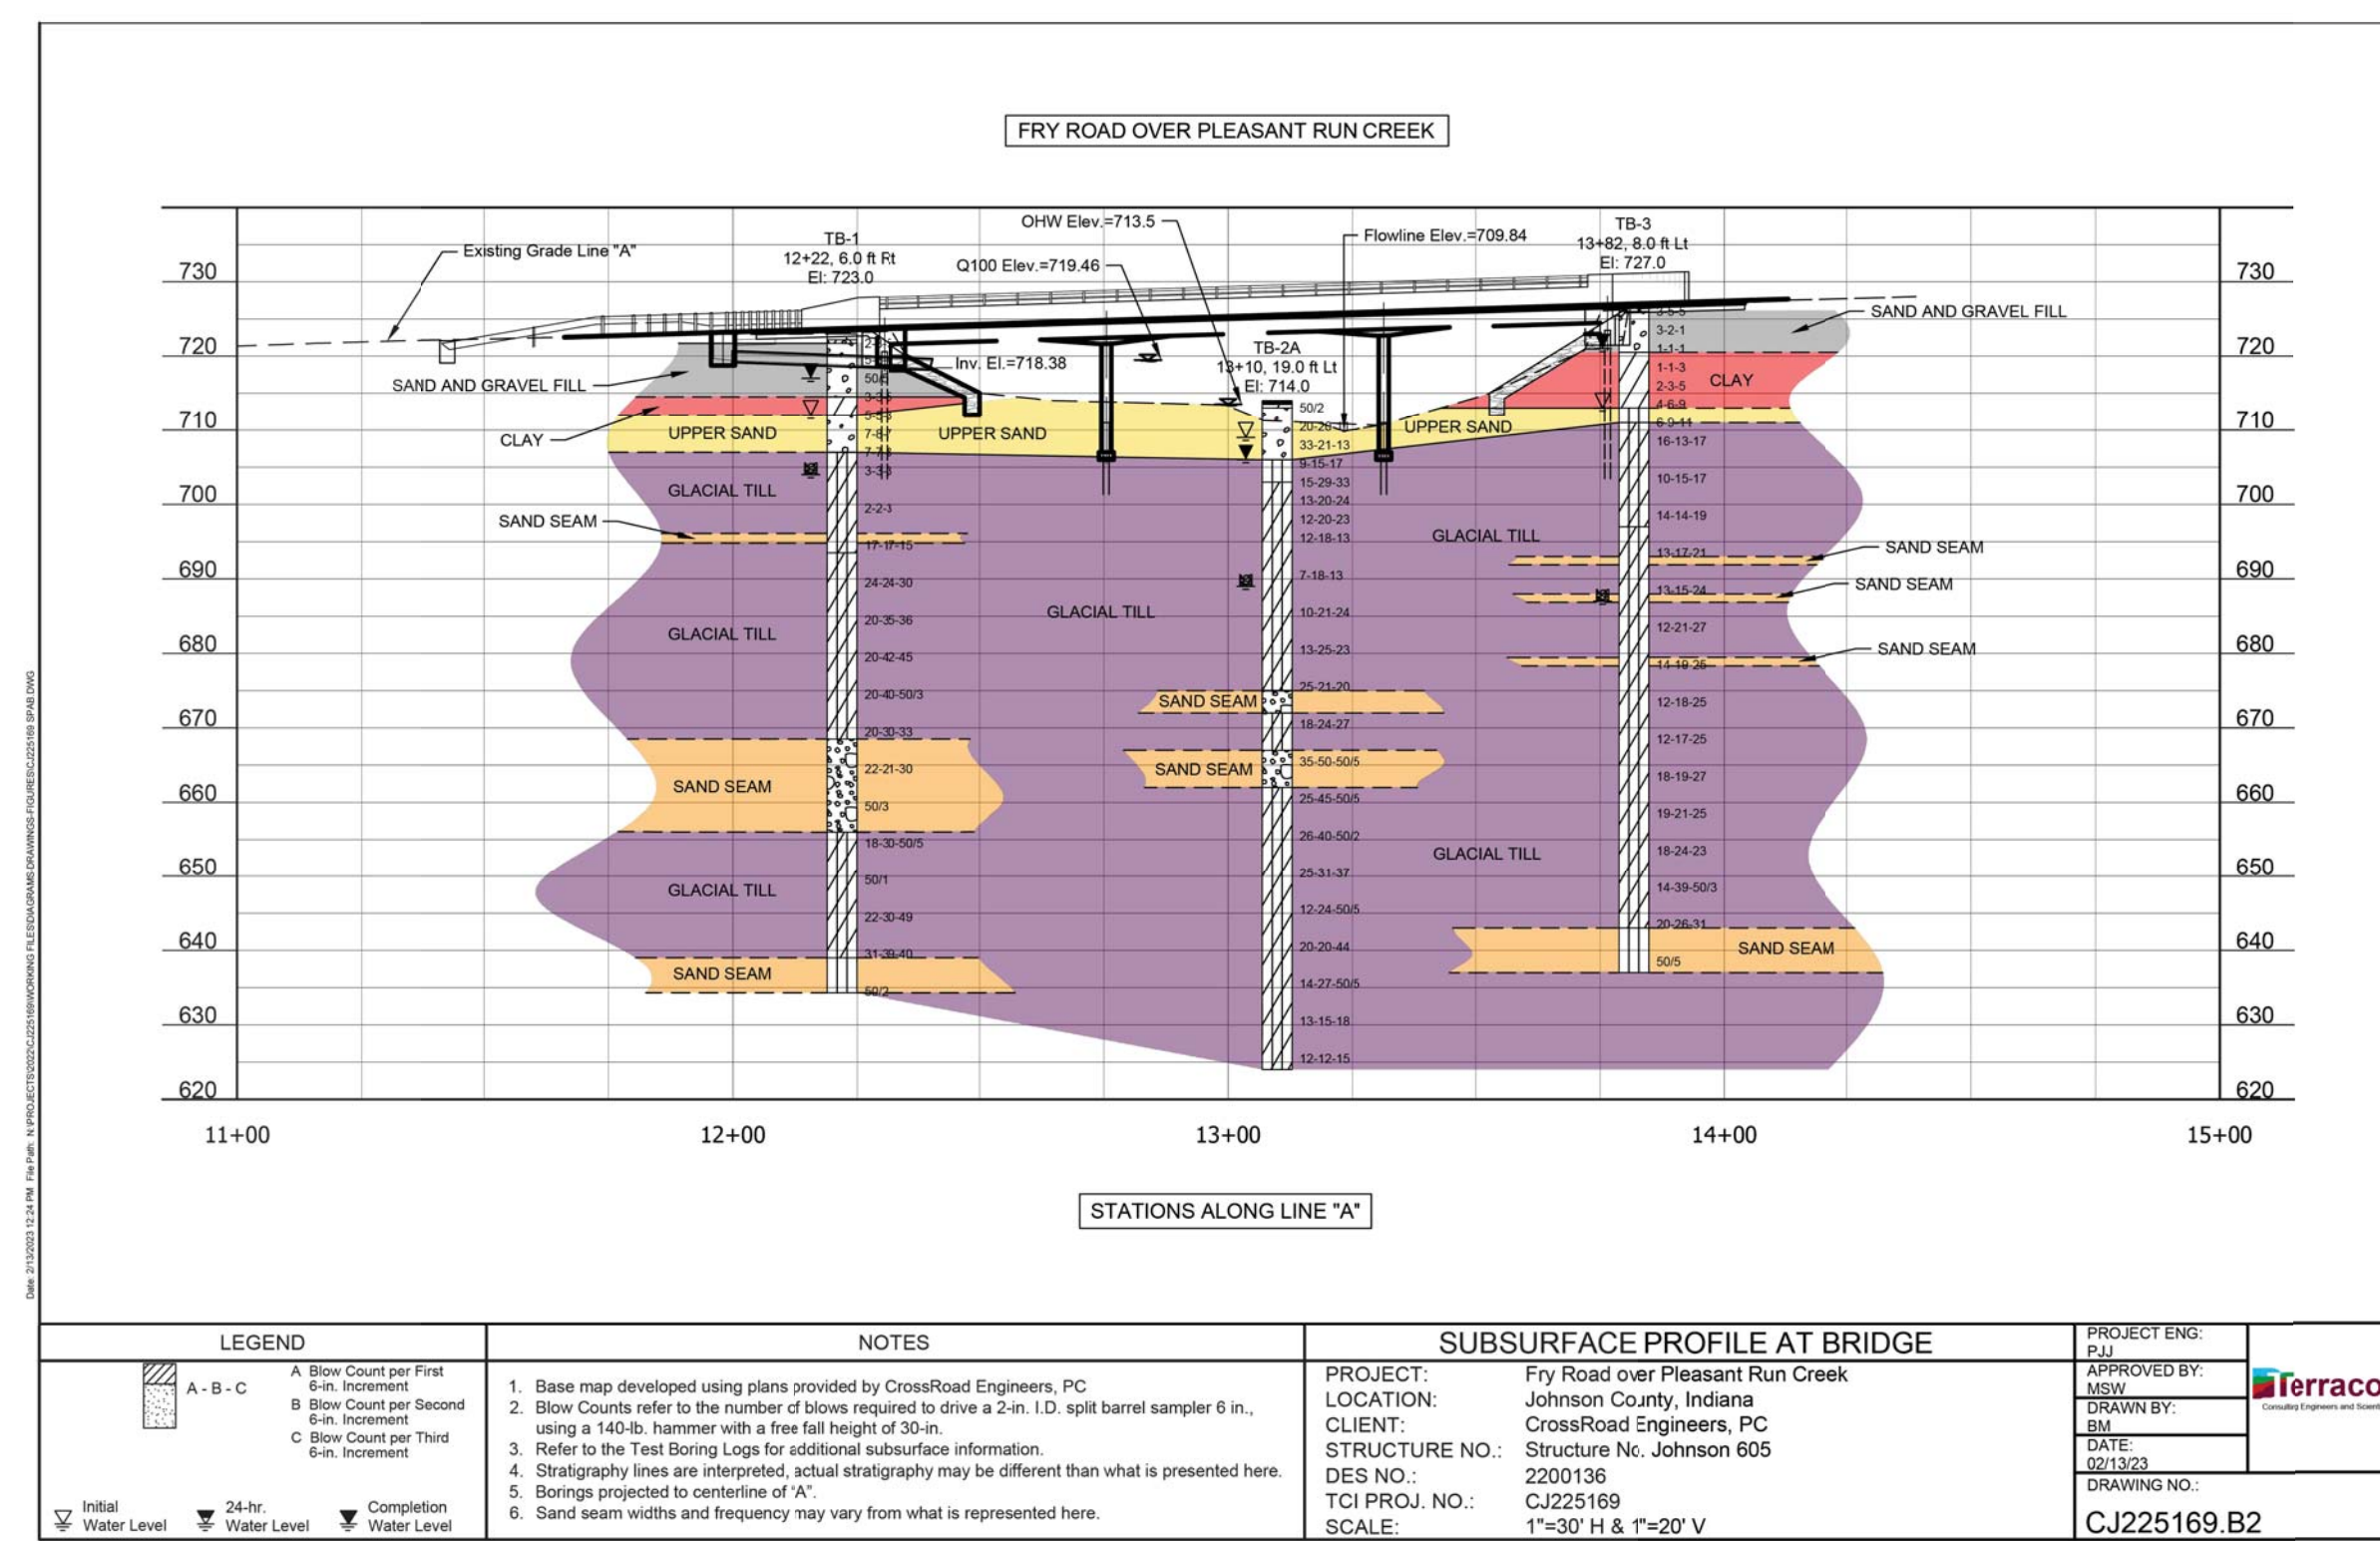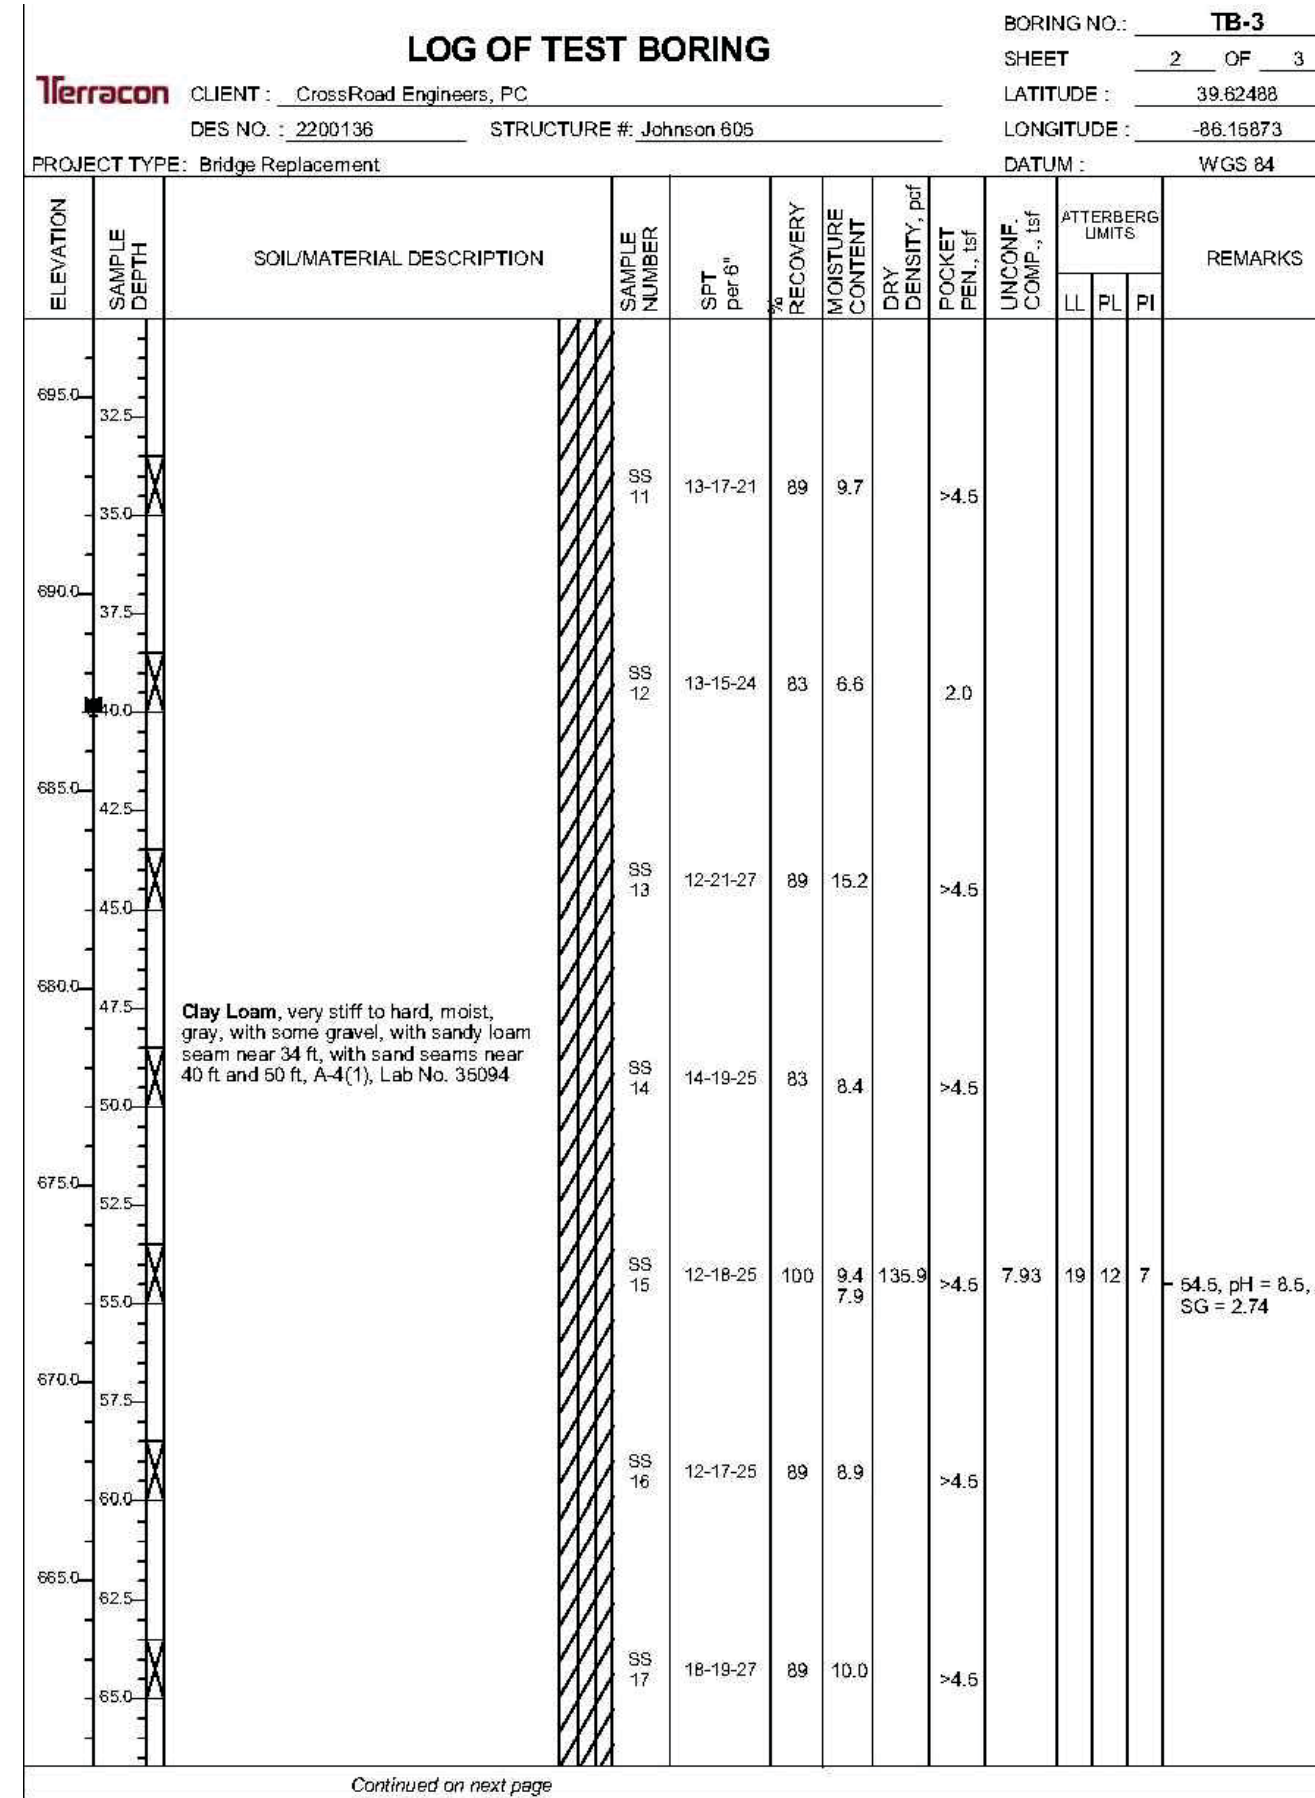SOIL BORING LOCATION PLAN
Scale : 1"=30'



PILE LOADING FOR GEOTECHNICAL TESTING				
Location	Bent No. 1	Pier No. 2	Pier No. 3	Bent No. 4
Pile Size and Type	14 in. x 0.375 in. Pipe Pile			
Factored Design Load - Q _f	130 Kips	200 Kips	200 Kips	130 Kips
Factored Soil Resistance - R _s	130 Kips	200 Kips	200 Kips	130 Kips
Resistance Factor Φ _m *	0.55	0.55	0.55	0.55
Factored Downdrag Load - D _D	Negligible			
Nominal Soil Resistance R _n	236 Kips	364 Kips	364 Kips	236 Kips
Downdrag Friction - R _{sdd}	Negligible			
Scour Zone Friction - R _s scour	N/A	55 Kips	55 Kips	N/A
Relaxation in Shale	N/A	N/A	N/A	N/A
Nominal Driving Resistance R _{ndr}	236 Kips	419 Kips	419 Kips	236 Kips
Estimated Pile Tip Elevation	698	681	681	701
Prebore with 12"Ø Hole to Elevation:	708	686	686	N/A
Method of Testing	Standard Specifications Section 701.05(a)			
One Indicator Test Pile with Restrike after 72 hours at Bent No. 1 and Pier No. 3.				
Minimum pile spacing is 3'-6" center to center of piling.				
*Based on 701.05(a)				

See Sheets 5 for Additional Test Boring Logs.

DIRECTORY PATH : G:\Active\Johnson County\Design\605\Design\Cod\Plans
 DATE/USER : 5/31/2023 12:33 PM / Bgardner

DATE	REVISION



NOT FOR CONSTRUCTION

RECOMMENDED FOR APPROVAL	DESIGN ENGINEER	DATE
	RDG	05/31/2023
DESIGNED: RDG	DRAWN: RDG	
CHECKED: MAM	CHECKED: MAM	

INDIANA
DEPARTMENT OF TRANSPORTATION

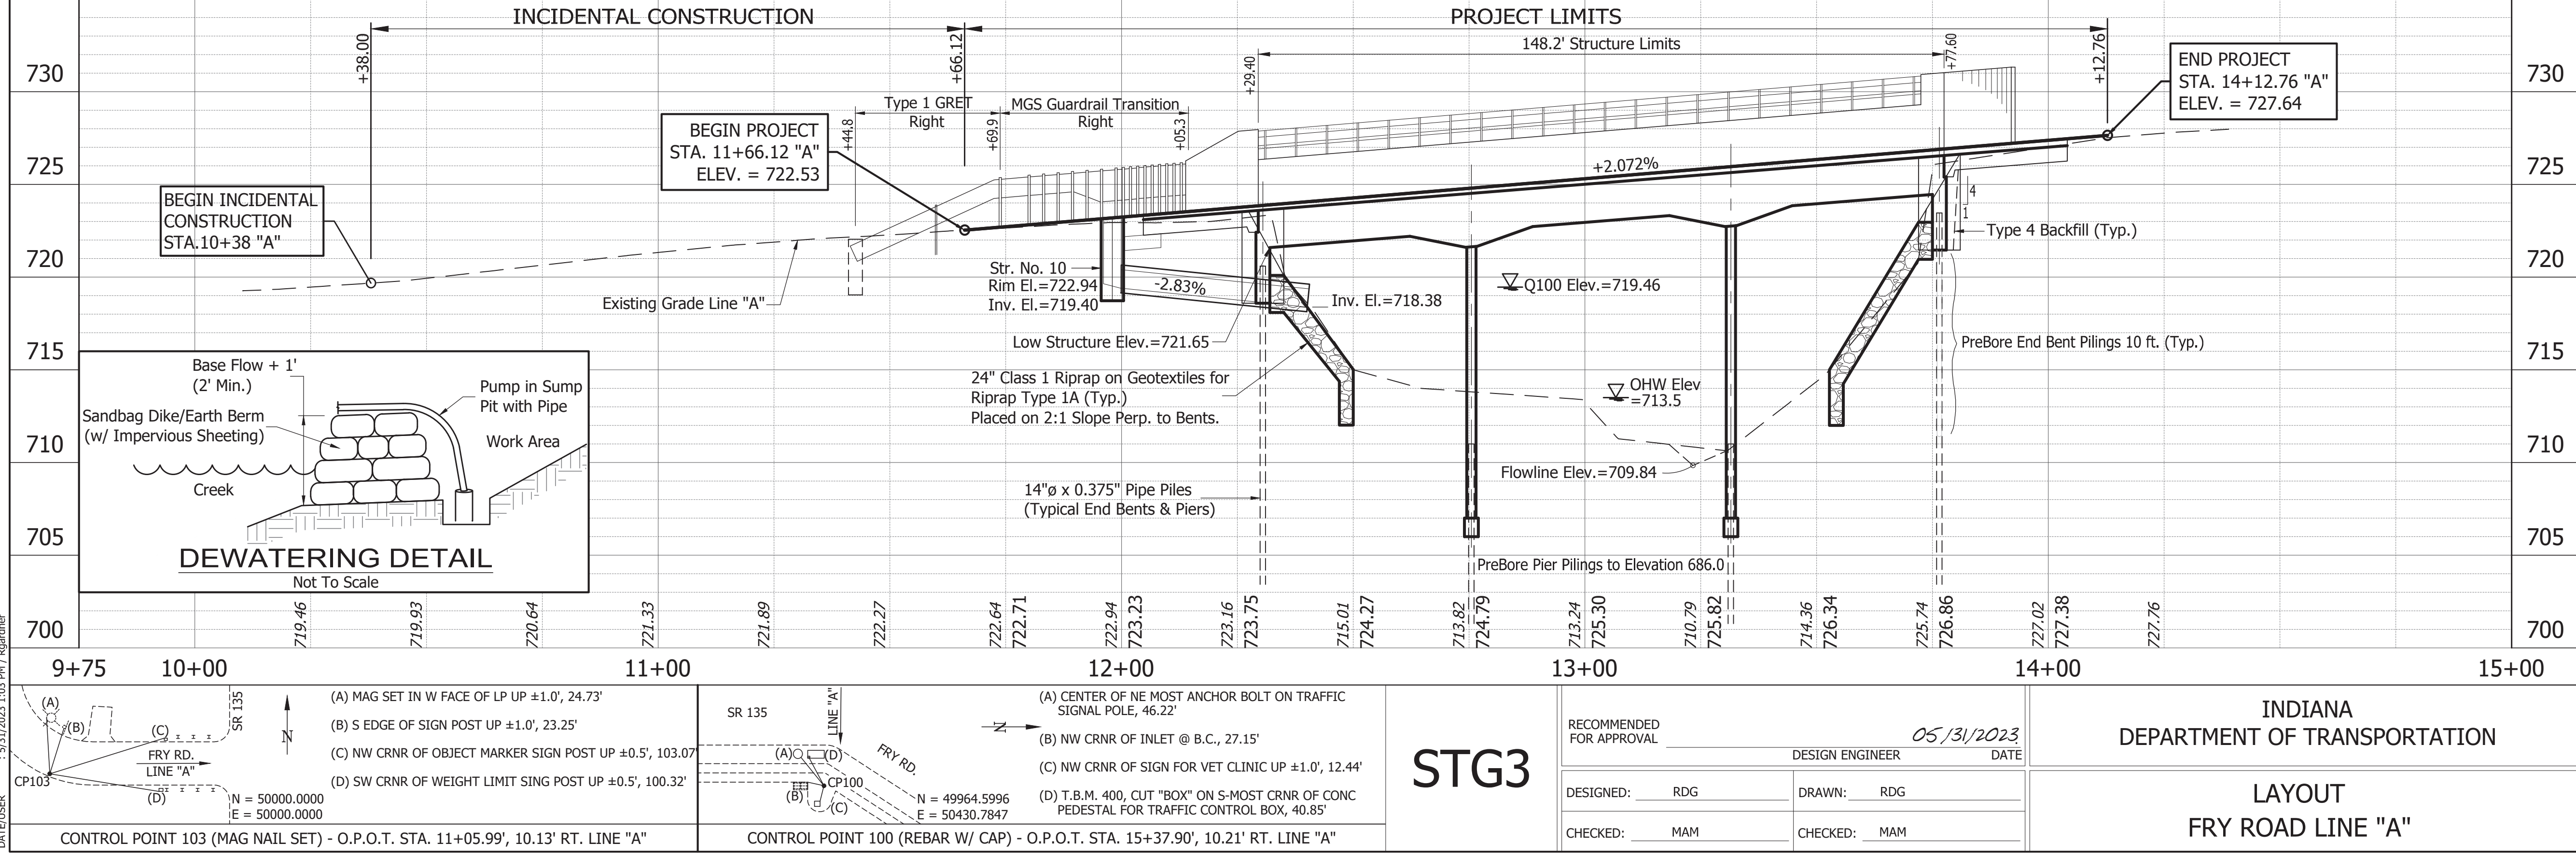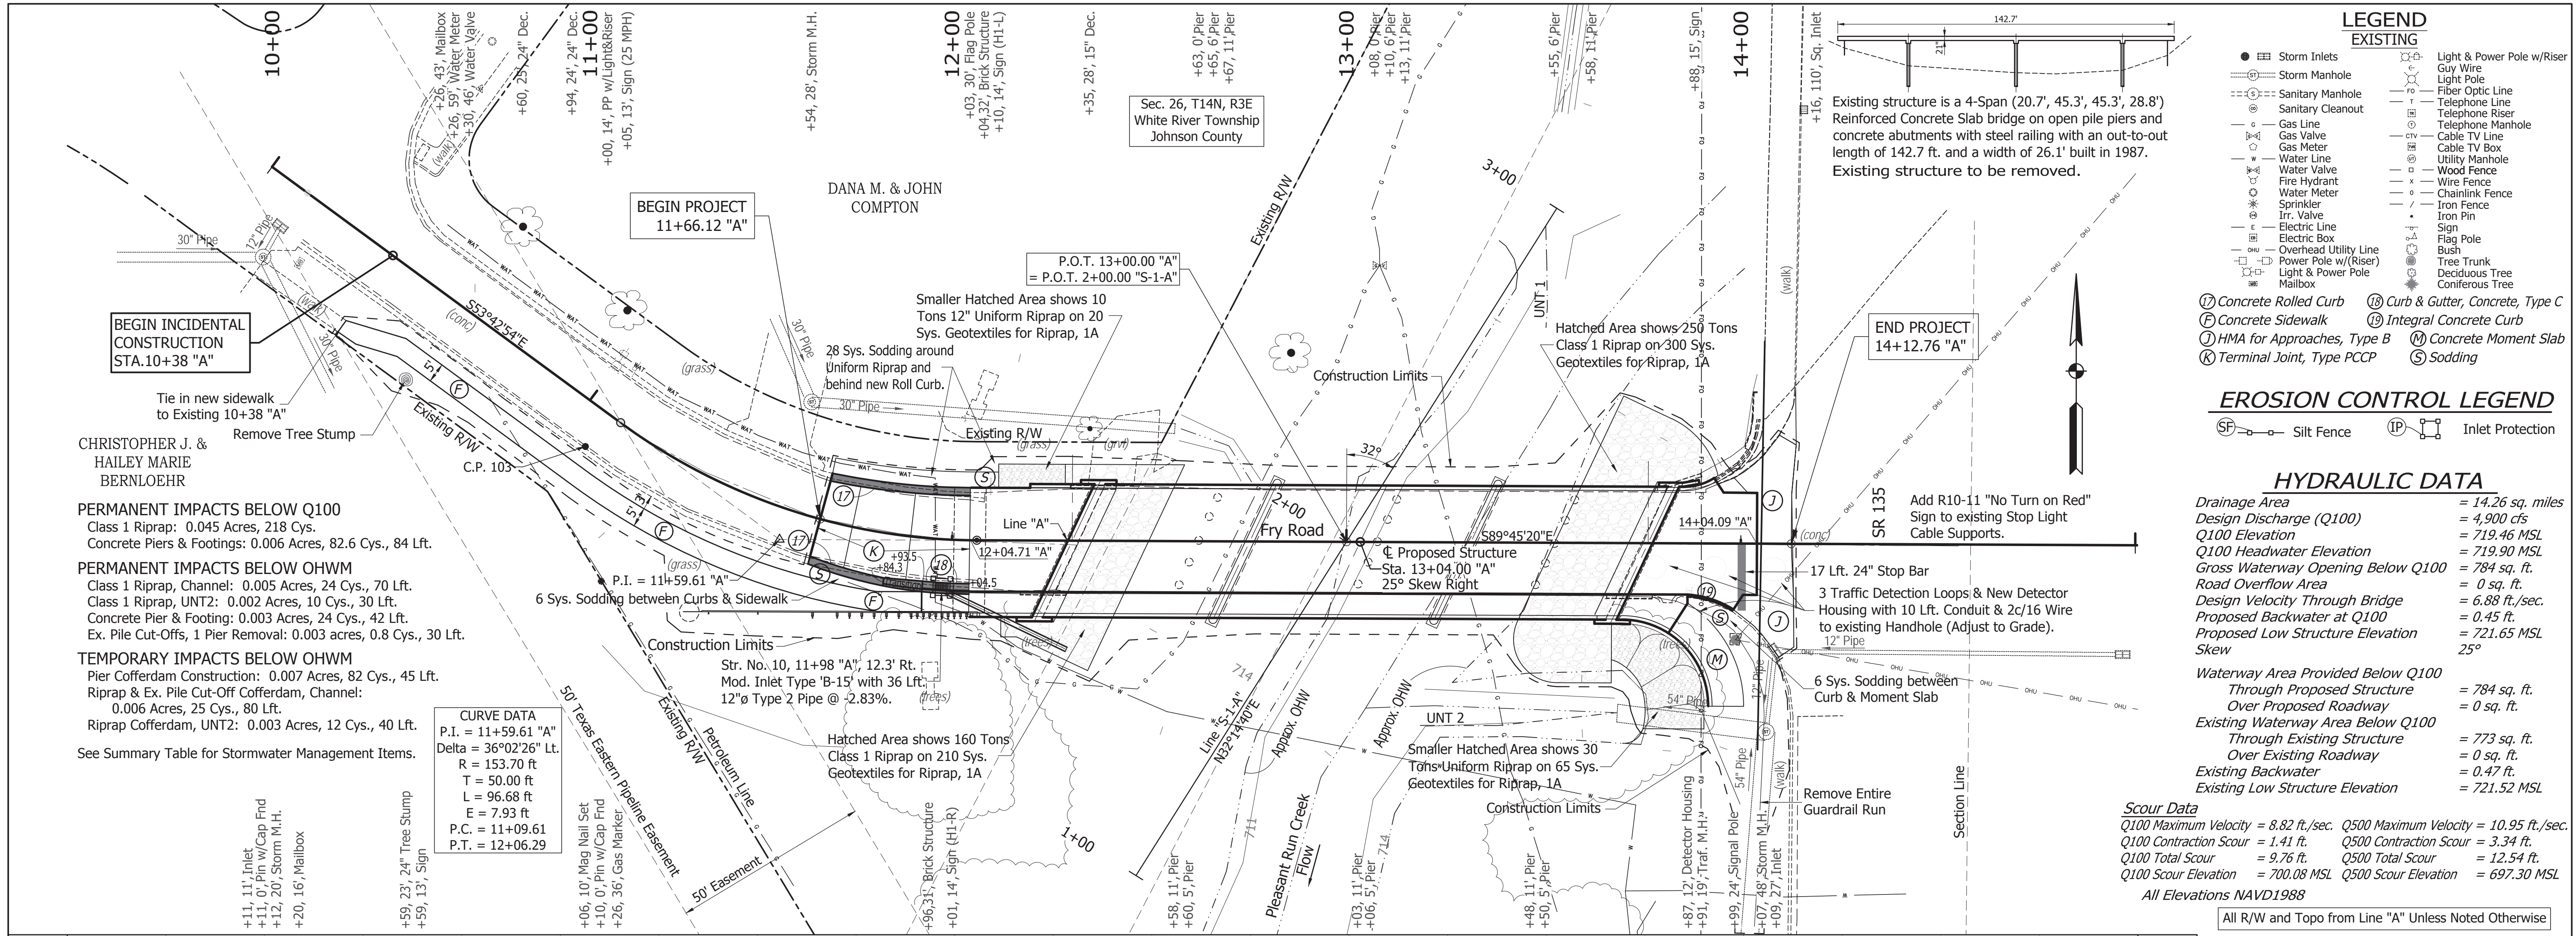SOIL BORINGS - SHEET 2
JOHNSON COUNTY BRIDGE NO. 605

SCALE	BRIDGE FILE
As Noted	JOHNSON 605
	DESIGNATION
	2200136
SURVEY BOOK	SHEETS
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TBM #400	Cut "Box" on south-most corner of concrete pedestal for traffic control box.
TBM #401	Cut on west side on concrete pedestal for light pole.
TBM #402	SE corner of decorative brick wall south of Sable Ridge Lane.
ORIGINATING BENCHMARK	Designation - X 13 PID-KA0010 State/County - IN/Morgan USGS Quad - Mooresville East (1980) Vert Order - First Class II
715	Described by Coast and Geodetic Survey 1946 1.2 mi N from Waverly, IN Johnson County, 1.2 miles north along State Highway 37 from the intersection of State Highway 144 at Waverly, Morgan County, 125 yards north of the Morgan-Johnson County line, 26 feet west of the centerline of the highway, in line with the west right-of-way fence, 1.5 feet south of a white wooden witness post, and about 2 feet higher than the highway. A standard disk, stamped 686.370 X 13 1930 and set in the top of a concrete post projecting 7 inches above ground.
710	Recovery Note by IN Dept of Natural Resources 1985 New Desc- At the intersection of New State Road 144 and Old State Road 37, in the southwest quarter of the intersection, witness post is gone, right-of-way fence is gone, all other information appears to be correct.
705	ELEVATION = 685.94 (NAVD 88)
HAUNCHES CONTINUOUS REINFORCED CONCRETE SLAB BRIDGE	
3 SPANS: 45'-0", 56'-0", 45'-0" 25° SKEW RIGHT	
26'-4" CLEAR ROADWAY	
FRY ROAD OVER PLEASANT RUN CREEK	
HORIZONTAL SCALE	BRIDGE FILE
1"=20'	JOHNSON 605
VERTICAL SCALE	DESIGNATION
1"=5'	2200136
SURVEY BOOK	SHEETS
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NOT FOR CONSTRUCTION