

# INDIANA DEPARTMENT OF ADMINISTRATION (IDOA) INDIANA DEPARTMENT OF NATURAL RESOURCES (IDNR)


## PROJECT No. ENG2303758614 MIAMI BOAT RAMP REPLACEMENT MISSISSINEWA RESERVOIR

BUTLER TOWNSHIP, MIAMI COUNTY, INDIANA SECTION 15, T-26-N, R-5-E

	DRAWING INDEX					
SHEET NO.	DESCRIPTION					
1	TITLE SHEET					
2	LEGEND AND GENERAL NOTES					
3	3 EXISTING CONDITIONS PLAN AND SURVEY CONTROL					
4	SITE PLAN					
5	CONSTRUCTION DETAILS					
6	WELL POINT PLAN					
7	GRADING PLAN					
8	JOINT LAYOUT PLAN					
9	EROSION CONTROL PLAN					

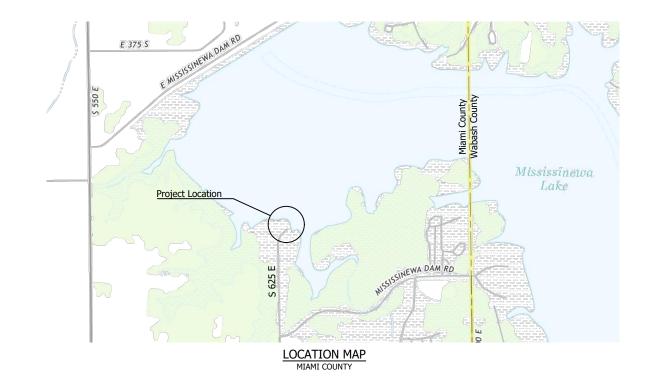

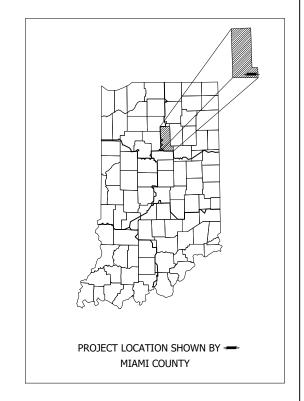

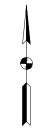











NDIANA DEPT. OF NATURAL RESOURCES
MIAMI BOAT RAMP REPLACEMENT
MISSISSINEWA RESERVOIR

TITLE SHEET

	REVISIONS	HORIZONTAL SCALE	PROJECT NUMBER			
		BARSCALE				
		VERTICAL SCALE	202	221	7.00	
					,	
	DRAWN: JAJ	SURVEY BOOK		SHEET	rs	
	DRAWN. JAJ		_		_	
	CHECKED: BRW	DATE	1	OF	9	
1	CILCRED. DRW	ALICUCT 2022	_	- 1		

BRW - 9/12/2023 4:06 PM - U:\2022\202

#### LEGEND:

● Benchmark
● Control Point
● Soil Boring
○ Iron Found

☆ Light Pole

⊞ Electric Handhole

Electric Handhole

oF0 Fiber Optic Marker

⊙ Post

Telephone Pedestal

Guy Pole
Guy Anchor
Power Pole
Water Valve
Curb Stop
Storm Inlet/Catch Basin

Storm ManholeCombined Sewer Manhole

Sanitary Manhole
Sign - Single Post

#### UTILITY PATTERNS

Ex. Electrical Line

F0 Ex. Fiber Optic Line

Ex. Gas Line

Ex. Water Line

Ex. Water Line

Ex. Sanitary Sewer

Ex. Storm Sewer

- - OH - Ex. Overhead Line

#### R/W PATTERNS

\_\_\_\_\_\_ Ex. Existing R/W \_\_\_\_\_ Property Line \_\_\_\_\_ Section Line \_\_\_\_\_ Easement

### MISCELLANEOUS LINES

Tree/Vegetation Line

--> --> --> Centerline of Ditch

Ex. Chain-Link Type Fence

Ex. Riprap

Proposed Centerline of Ditch

#### PUBLIC UTILITY

The existing utilities listed below and shown on these plans represent the best information available as obtained on our surveys. This information does not relieve the contractor of the responsibility to be satisfied as to its accuracy and the location of existing utilities.

OWNER

UTILITY

INDIANA 811



Per Indiana State Law IC-8-1-26-16: It is against the law to excavate without notifying the underground location service two (2) working days before commencing work.

INDIANA 811 1-800-382-5544 OR CALL 811 24 HOURS A DAY 7 DAYS A WEEK

Note: Utility locations are shown based upon information (maps and paint marks) supplied by others, and there is not guarantee of the accuracy or completeness of said locations.

#### **GENERAL NOTES:**

- 1. All items shown are existing unless otherwise indicated as required.
- The contractor shall locate all underground utilities prior to starting work and shall conduct his operation in such manner as to insure that those utilities will not be disturbed.
- Any damage to access roads, bridges, private or public property, and to existing structure not specified to be altered and caused by the contractor during construction shall be repaired at the expense of the contractor.
- Prior to starting construction the contractor shall conduct check surveys on each aspect of the work as provided in the specifications. The results of the check surveys may affect the quantities.
- 5. If any errors become apparent, they shall be brought to the attention of the engineer prior to construction so that clarification or redesign may occur.
- Contractor shall power wash all equipment upon arriving on site in order to decrease the spread of any invasive species.
- Contractor shall not remove trees between April 1st to October 1st due to date restrictions with the endangered Indiana bat species.
- 8. Contractor shall seed and mulch all disturbed areas within the construction limits unless noted otherwise.
- 9. INDOT Standard Specification latest edition, shall be used with these plans.

LAWSON-FISHER ASSOCIATES P.C.

525 W. WASHINGTON AVENUE
SOUTH BEND, INDIANA 46601

PH. (574) 234-3167






INDIANA DEPT. OF NATURAL RESOURCES MIAMI BOAT RAMP REPLACEMENT MISSISSINEWA RESERVOIR

LEGEND AND GENERAL NOTES

	REVISIONS	HORIZONTAL SCALE	PROJE	CT N	UMBER
		VERTICAL SCALE	2022	21	7.00
_	DRAWN: JAJ	SURVEY BOOK	S	HEET	rs
		DATE	2	OF	9
	CHECKED: BRW	AUGUST 2023	_		

M — U:\2022\202217 IDOA Miami Boat Rmp\Cad\Plan Set\Civ

10000 VIII NO 30. 10000/ 01/ 0

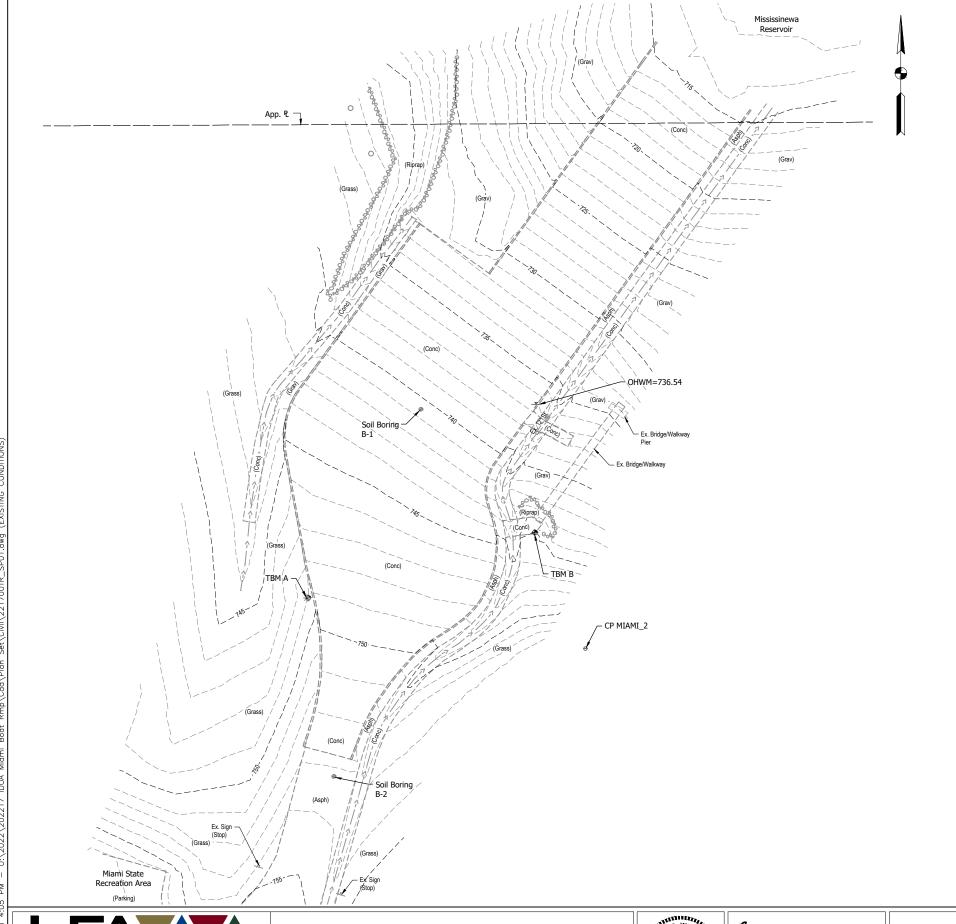

#### SURVEY NOTES:

- 1. Unless noted otherwise, all bearings, distances, areas, and coordinates shown hereon are based upon the Indiana State Plane Coordinate System (InSPC) East Zone (1301) per NAD 83 (2011) Epoch 2010.00 and are reported in U.S. Survey Feet and decimal parts thereof.
- Unless noted otherwise, all elevations shown hereon are based upon the North American Vertical Datum of 1988 (NAVD 88) as established on National Geodetic Survey (NGS) marker Y 172 (PID LA1631) elevation; 783.76
- According to the National Geodetic Survey (NGS) Coordinate Conversion and Transformation Tool (NCAT), the difference between the vertical datums NAVD 88 and NGVD 29 is 0.41 feet at the location of this project site.
- 4. U.S. Army Corps of Engineers (USACE) reports the normal pool elevations as follows: summer pool elevation is 737 (NGVD29) and winter pool elevation is 712 (NGVD29). The normal pool elevations equate to this project datum as follows: summer pool elevation is 736.6 (NAVD 88) and winter pool elevation is 711.6 (NAVD 88).
- 5. The project is located in Section 15, T26N R5E (Butler Twp.), Miami County, State of Indiana.
- 6. Horizontal Control Points (CP) Miami 1 and Miami 2 were established by the simple mean average of a minimum of three separate Global Navigation Satellite System (GNSS) observations averaging 316 epochs each. The GNSS observation class was Real Time Kinematic (RTK) and utilized the Trimble Virtual Reference Station Now Network (TVN) as the correction source.
- Temporary benchmark elevations for TBM A and B were established by trigonometric leveling with a Trimble S6 total station. The elevation for TBM A and B were based upon the GNSS established elevation of CP MIAMI\_2.

- a. Trimble R10 GNSS Receiver (3mm // 8mm+1ppm RMS)
- b. Trimble S6 Robotic Total Station (3" 2mm+2ppm) c. Trimble SX10 Robotic Scanning Total Station (1" 2mm+1.5ppm)
- 8. No underground utilities were marked or surveyed.
- 9. The topographic survey was completed on January 12, 2023.

VERTICAL CONTROL (NAVD 88)									
ID Elevation Remarks Northing Easting Latitude Longitude									
750.74	Cotton Gin Gear; E Face Lt. P. (87403); 1.3' Above Grnd. Level	1987657.9	248338.8	N40°42'18.01"	W85°57'15.45"				
745.21	1% " Cut Cir.; S Cor. Conc. Pier Landing; Flush w/ Grnd. Level	1987685.2	248433.2	N40°42'18.28"	W85°57'14.23"				
	750.74	Elevation Remarks 750.74 Cotton Gin Gear; E Face Lt. P. (87403); 1.3' Above Grnd. Level	Elevation Remarks Northing 750.74 Cotton Gin Gear; E Face Lt. P. (87403); 1.3' Above Grnd. Level 1987657.9	Elevation Remarks Northing Easting 750.74 Cotton Gin Gear; E Face Lt. P. (87403); 1.3' Above Grnd. Level 1987657.9 248338.8	Elevation Remarks Northing Easting Latitude  750.74 Cotton Gin Gear; E Face Lt. P. (87403); 1.3' Above Grnd. Level 1987657.9 248338.8 N40°42'18.01"				

Control point elevations are provided for reference. It should be understood that the markers used are subject to vertical movement due to frost heave, vehicle movements and other environmental factors. All horizontal control point elevations are superseded by bench mark elevations.

HORIZONTAL CONTROL (INSPC – EAST ZONE // U.S. FEET)								
ID	ID Northing Easting Latitude Longitude Elevation Marker							
MIAMI_1	1987216.1540	247919.8800	N40°42'13.63193"	W85°57'20.87155"	766.78	$\frac{1}{2}$ " x 18" Rebar w/ Cap Stamped 'LAWSON-FISHER'		
MIAMI_2	1987636.6767	248454.2189	N40°42'17.80458"	W85°57'13.95143"	753.37	$\frac{1}{2}$ " x 18" Rebar w/ Cap Stamped 'LAWSON-FISHER'		

Control point elevations are provided for reference. It should be understood that the markers used are subject to vertical movement due to frost heave, vehicle movements and other environmental factors. All horizontal control point elevations are superseded by bench mark elevations.





PH. (574) 234-3167






INDIANA DEPT. OF NATURAL RESOURCES MIAMI BOAT RAMP REPLACEMENT MISSISSINEWA RESERVOIR

> **EXISTING CONDITIONS PLAN** AND SURVEY CONTROL

REVISIONS	HORIZONTAL SCALE	PROJECT NUMBER			
	1" = 20' VERTICAL SCALE	202217.00			
		202217.00			
DRAWN: JAJ	SURVEY BOOK	SHEETS			
JAJ	DATE	2 0 0			


AUGUST 2023

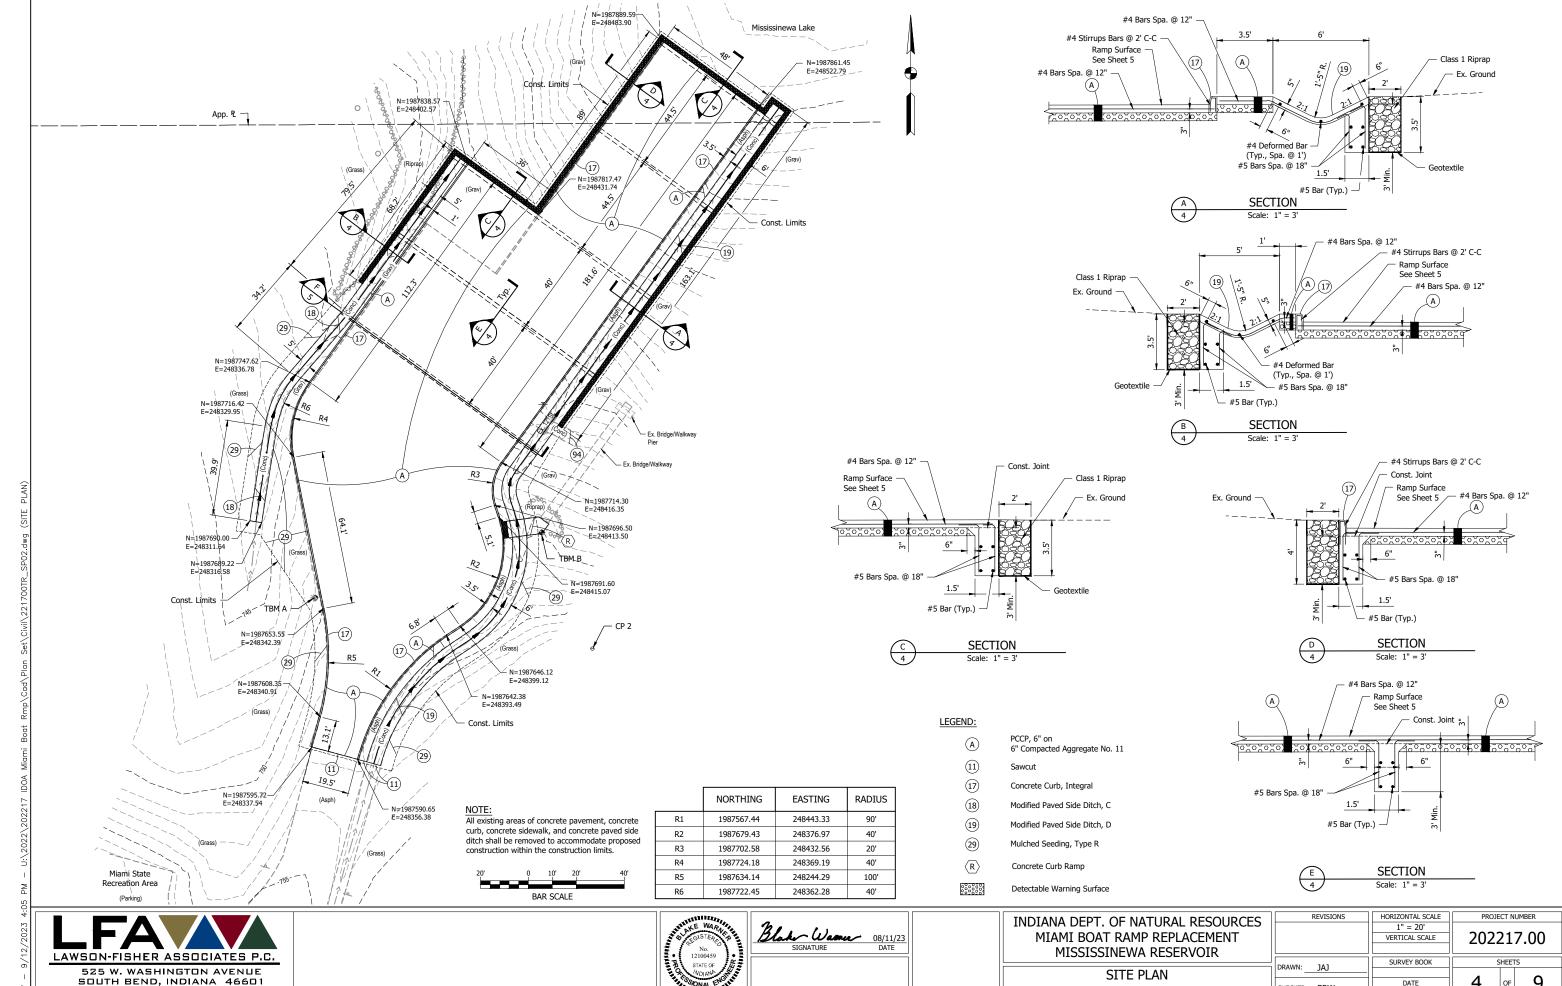


PH. (574) 234-3167




REVISIONS	HORIZONTAL SCALE	PROJECT NUMBER			
	1" = 20'				
	VERTICAL SCALE	202217.0			
DRAWN: JAJ	SURVEY BOOK	SH	EETS		
DIXWIN					
CHECKED: BRW	DATE	4	of <b>Q</b>		
CHECKED: BRVV	AUGUST 2023				

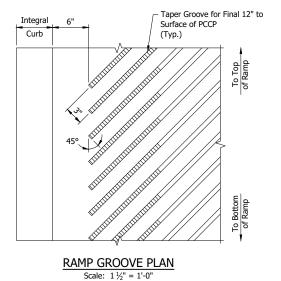

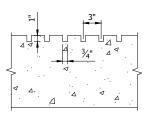

 $\frac{\text{RAMP GROOVE DETAIL}}{\text{Scale: } 1\frac{1}{2}" = 1'-0"}$ 

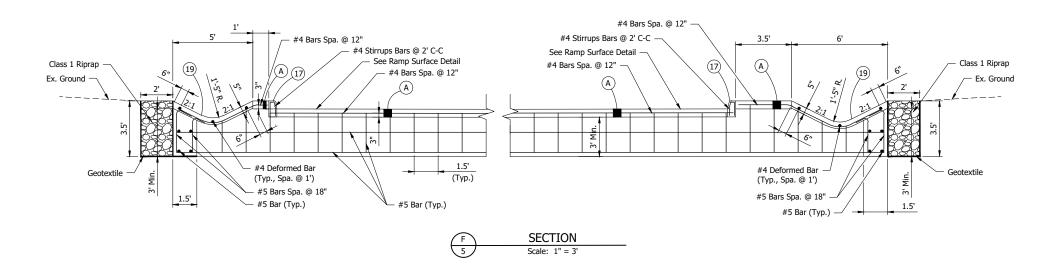

LAWSON-FISHER ASSOCIATES P.C.


525 W. WASHINGTON AVENUE
SOUTH BEND, INDIANA 46601
PH. (574) 234-3167





INDIANA DEPT. OF NATURAL RESOURCES MIAMI BOAT RAMP REPLACEMENT MISSISSINEWA RESERVOIR	
CONSTRUCTION DETAILS	[


	REVISIONS	HORIZONTAL SCALE	PROJECT NUMBER			
<b>'</b>		AS NOTED				
		VERTICAL SCALE	202217.00			
ᆜ	DRAWN: GDH	SURVEY BOOK	SHEETS			
	DRAWN: GDH		_		_	
	CHECKED: BRW	DATE	5	OF	9	
	CHECKED. DICVV	AUGUST 2023	_			

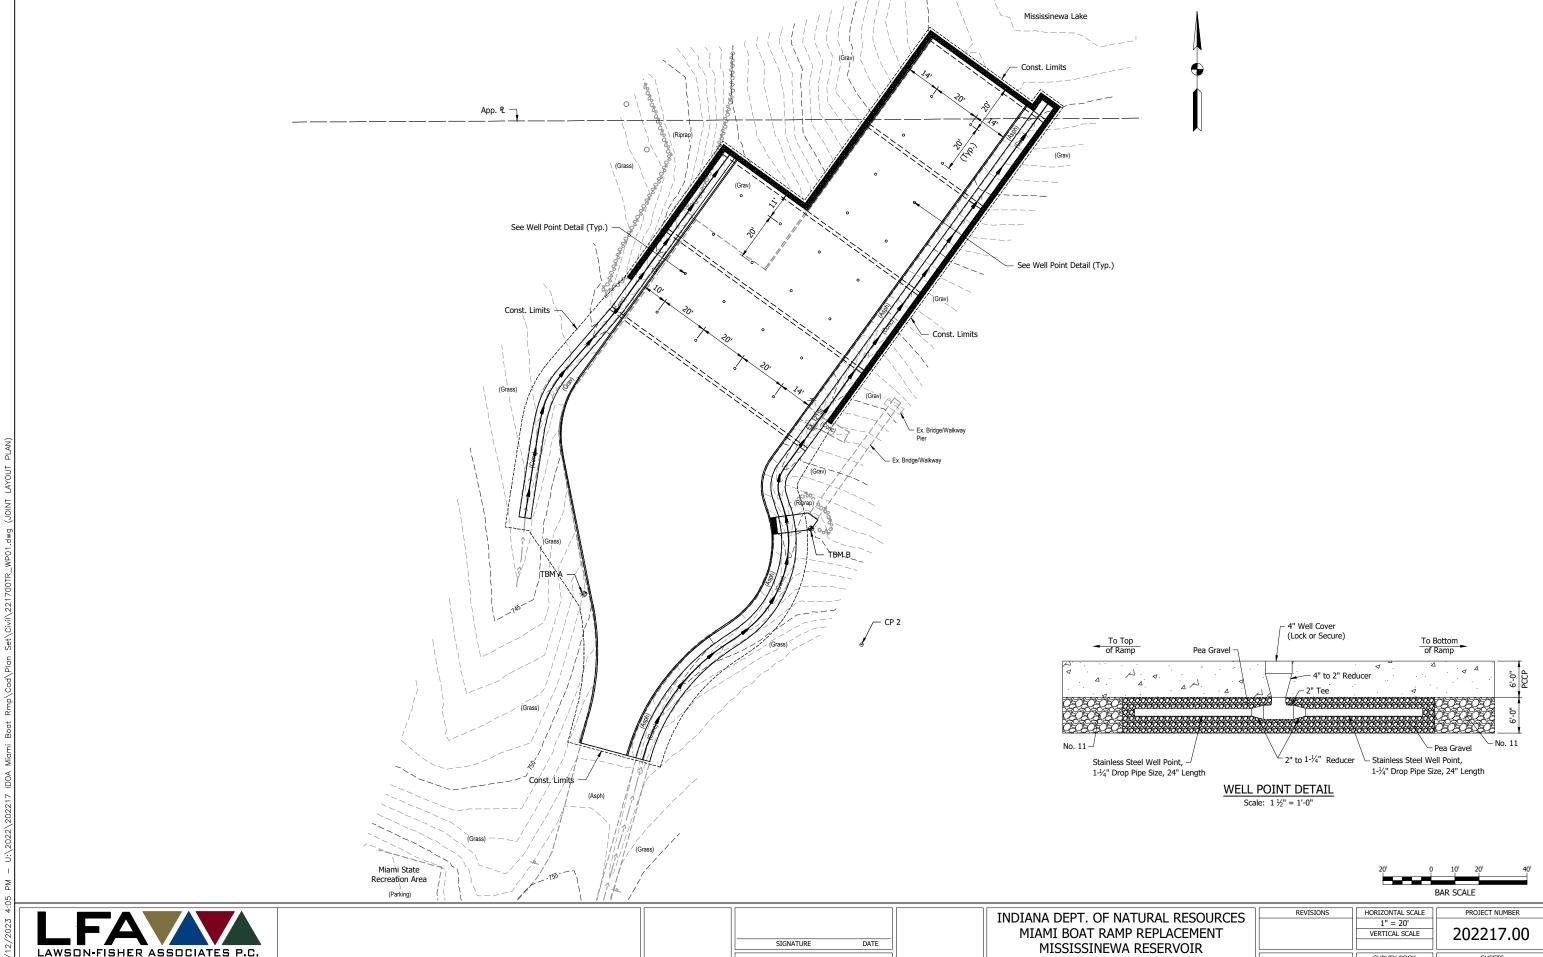

525 W. WASHINGTON AVENUE SOUTH BEND, INDIANA 46601 PH. (574) 234-3167

WELL POINT PLAN


REVISIONS	HORIZONTAL SCALE	PROJ	ECT N	UMBER
	1" = 20' VERTICAL SCALE	202	7.00	
DRAWN: JAJ	SURVEY BOOK		SHEET	rs
DIGWIN: JAJ				_
CHECKED: BRW	DATE AUGUST 2023	6	OF	9

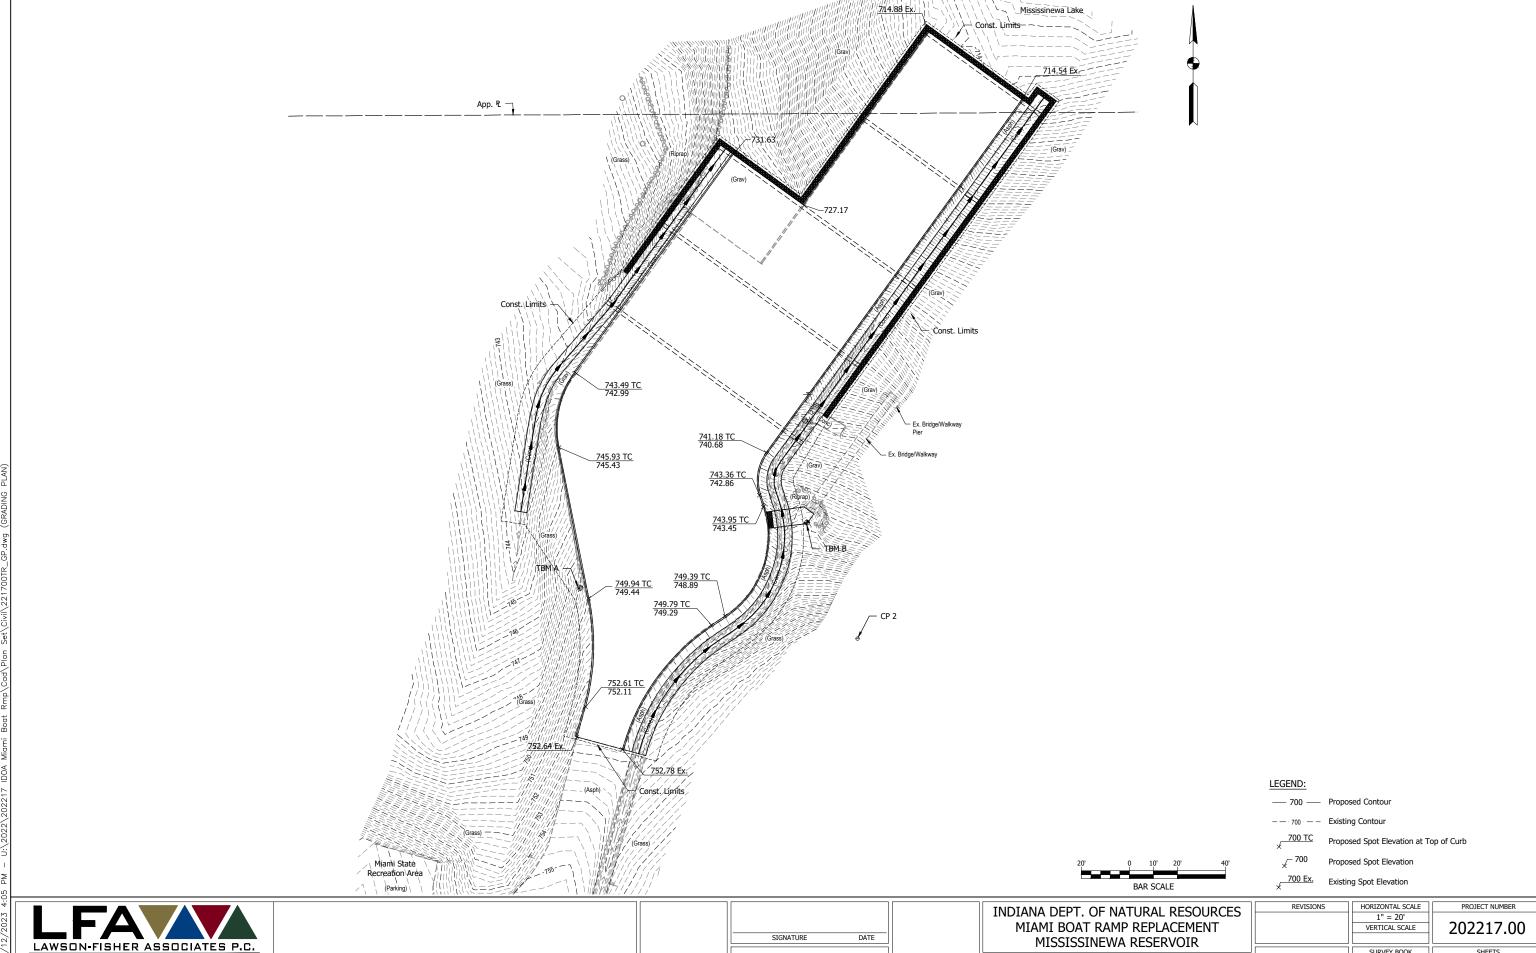


525 W. WASHINGTON AVENUE SOUTH BEND, INDIANA 46601 PH. (574) 234-3167

GRADING PLAN

REVISIONS	HORIZONTAL SCALE	PROJECT NUMBER			
	1" = 20' VERTICAL SCALE	2022	1	7 00	
	VERTICAL SCALE	2022	7.00		
DRAWN: JAJ	SURVEY BOOK	S	HEET	rs	
DIOWIN: JAJ		_		_	
CHECKED: BRW	AUGUST 2023	/	OF	9	

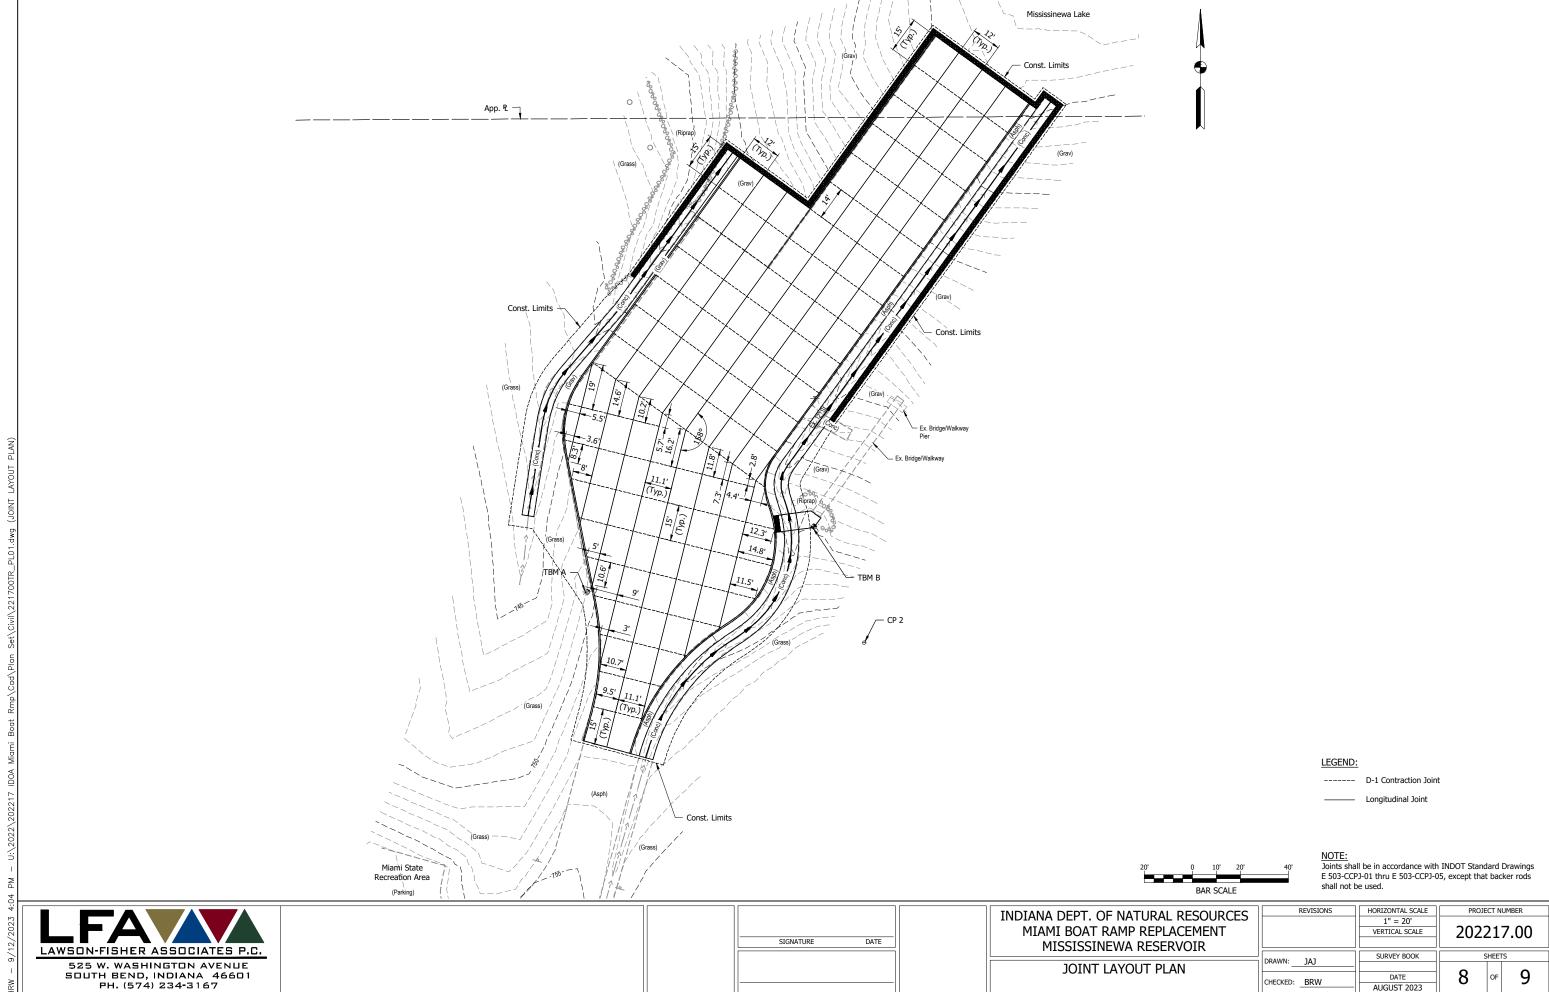

AUGUST 2023

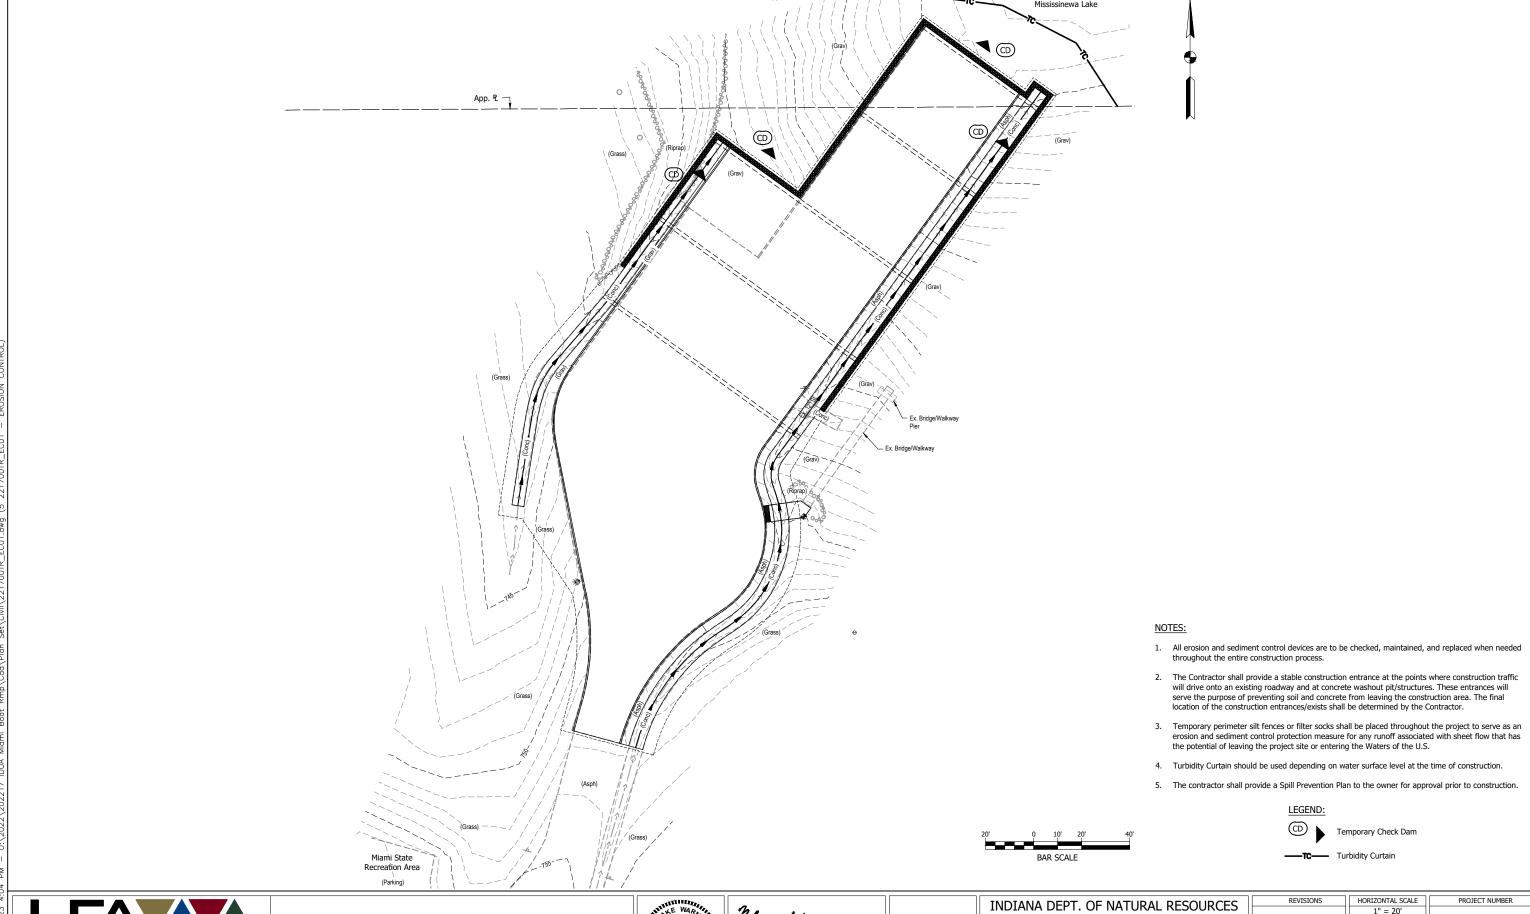







INDIANA DEPT. OF NATURAL RESOURCES MIAMI BOAT RAMP REPLACEMENT MISSISSINEWA RESERVOIR

EROSION CONTROL	PLAN

REVISIONS	HORIZONTAL SCALE	PROJECT NUMBER	
	1" = 20'		_
	VERTICAL SCALE	202217.0	)O
DRAWN: 1A1	SURVEY BOOK	SHEETS	
DRAWN. JAJ			_
CHECKED: BRW	DATE	<b>9</b>   OF	9
	AUGUST 2023		
	DRAWN: JAJ	DRAWN: JAJ SURVEY BOOK  CHECKED: BRW DATE	1" = 20'