SITE	NAME	
SITE NO.	CONTRACT NO.	
287	E008-177	
GREENE	COUNTY	


### STATE OF INDIANA INDIANA DEPARTMENT OF NATURAL RESOURCES DIVISION OF RECLAMATION



### ABANDONED COAL MINE RESTORATION

FRIAR TUCK **SITE 287** CONTRACT E008-177 **GREENE COUNTY** 

Clear and grub, construct wetlands, demolish hazardous facilities, and revegetate all disturbed.

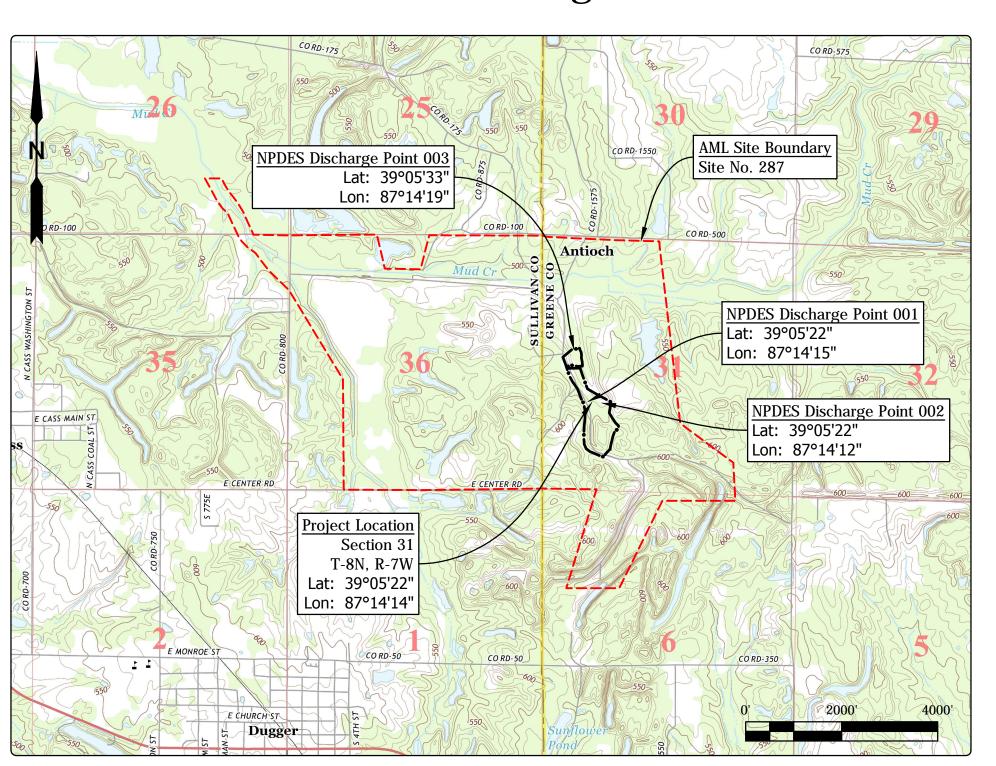

Project Location Map Dugger & Linton US TOPO (USGS, 2013)

### GENERAL NOTES

2010 AML Standard Specifications to be used with these plans.

Plans developed from LiDAR topographic mapping survey flown in Spring of 2010 by Williams Aerial & Mapping, Inc. in NAD 83, Indiana State Plane West, Feet.

An NPDES discharge permit is required for this project.

INDEX						
SHEET NO.	SHEET TITLE					
1	TITLE, INDEX, & LOCATION MAP					
2	SITE MAP					
3-4	SITE PLANS					
5	PROFILES					
6	REVEGETATION PLAN					
7-8	DETAILS					

### UTILITIES

The facilities of the following utilities exist near the project site but are not expected to be affected by the proposed construction. If questions arise, the utility may be contacted using the information below.


ELECTRIC: **Utilities District of Western** Indiana R.E.M.C.

PO Box 427/Hwy. 54 West Bloomfield, IN 47424 Phone: (812) 384 5053

AT&T Distribution 2042 Alta Ave Louisville, KY 40205 Phone: (502) 553 0561


TELECOM:


Call Before You Dig. Indiana Underground Plant Protection Service (IUPPS) 1-800-382-5544 or 811 from your mobile phone.

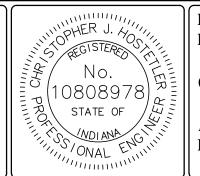



PLANS	INDIANA DEPARTMENT OF NATURAL RESOURCES	
PREPARED BY:	DIVISION OF RECLAMATION	(812) 665-2207
	0.0	PHONE NUMBER
CERTIFIED BY:	Christophes J. Hostelles	5/12/17
APPROVED	M. 1 SOO.	DATE
FOR LETTING:	Jan D. Colon	5/12/17
	DIVISION OF RECLAMATION	DATE


35-2207	SCALE	SHEET
UMBER 5/12/17	AS NOTED	1 of 8
DATE	PROJECT	SITE
5/12/17 DATE	E008-177	287

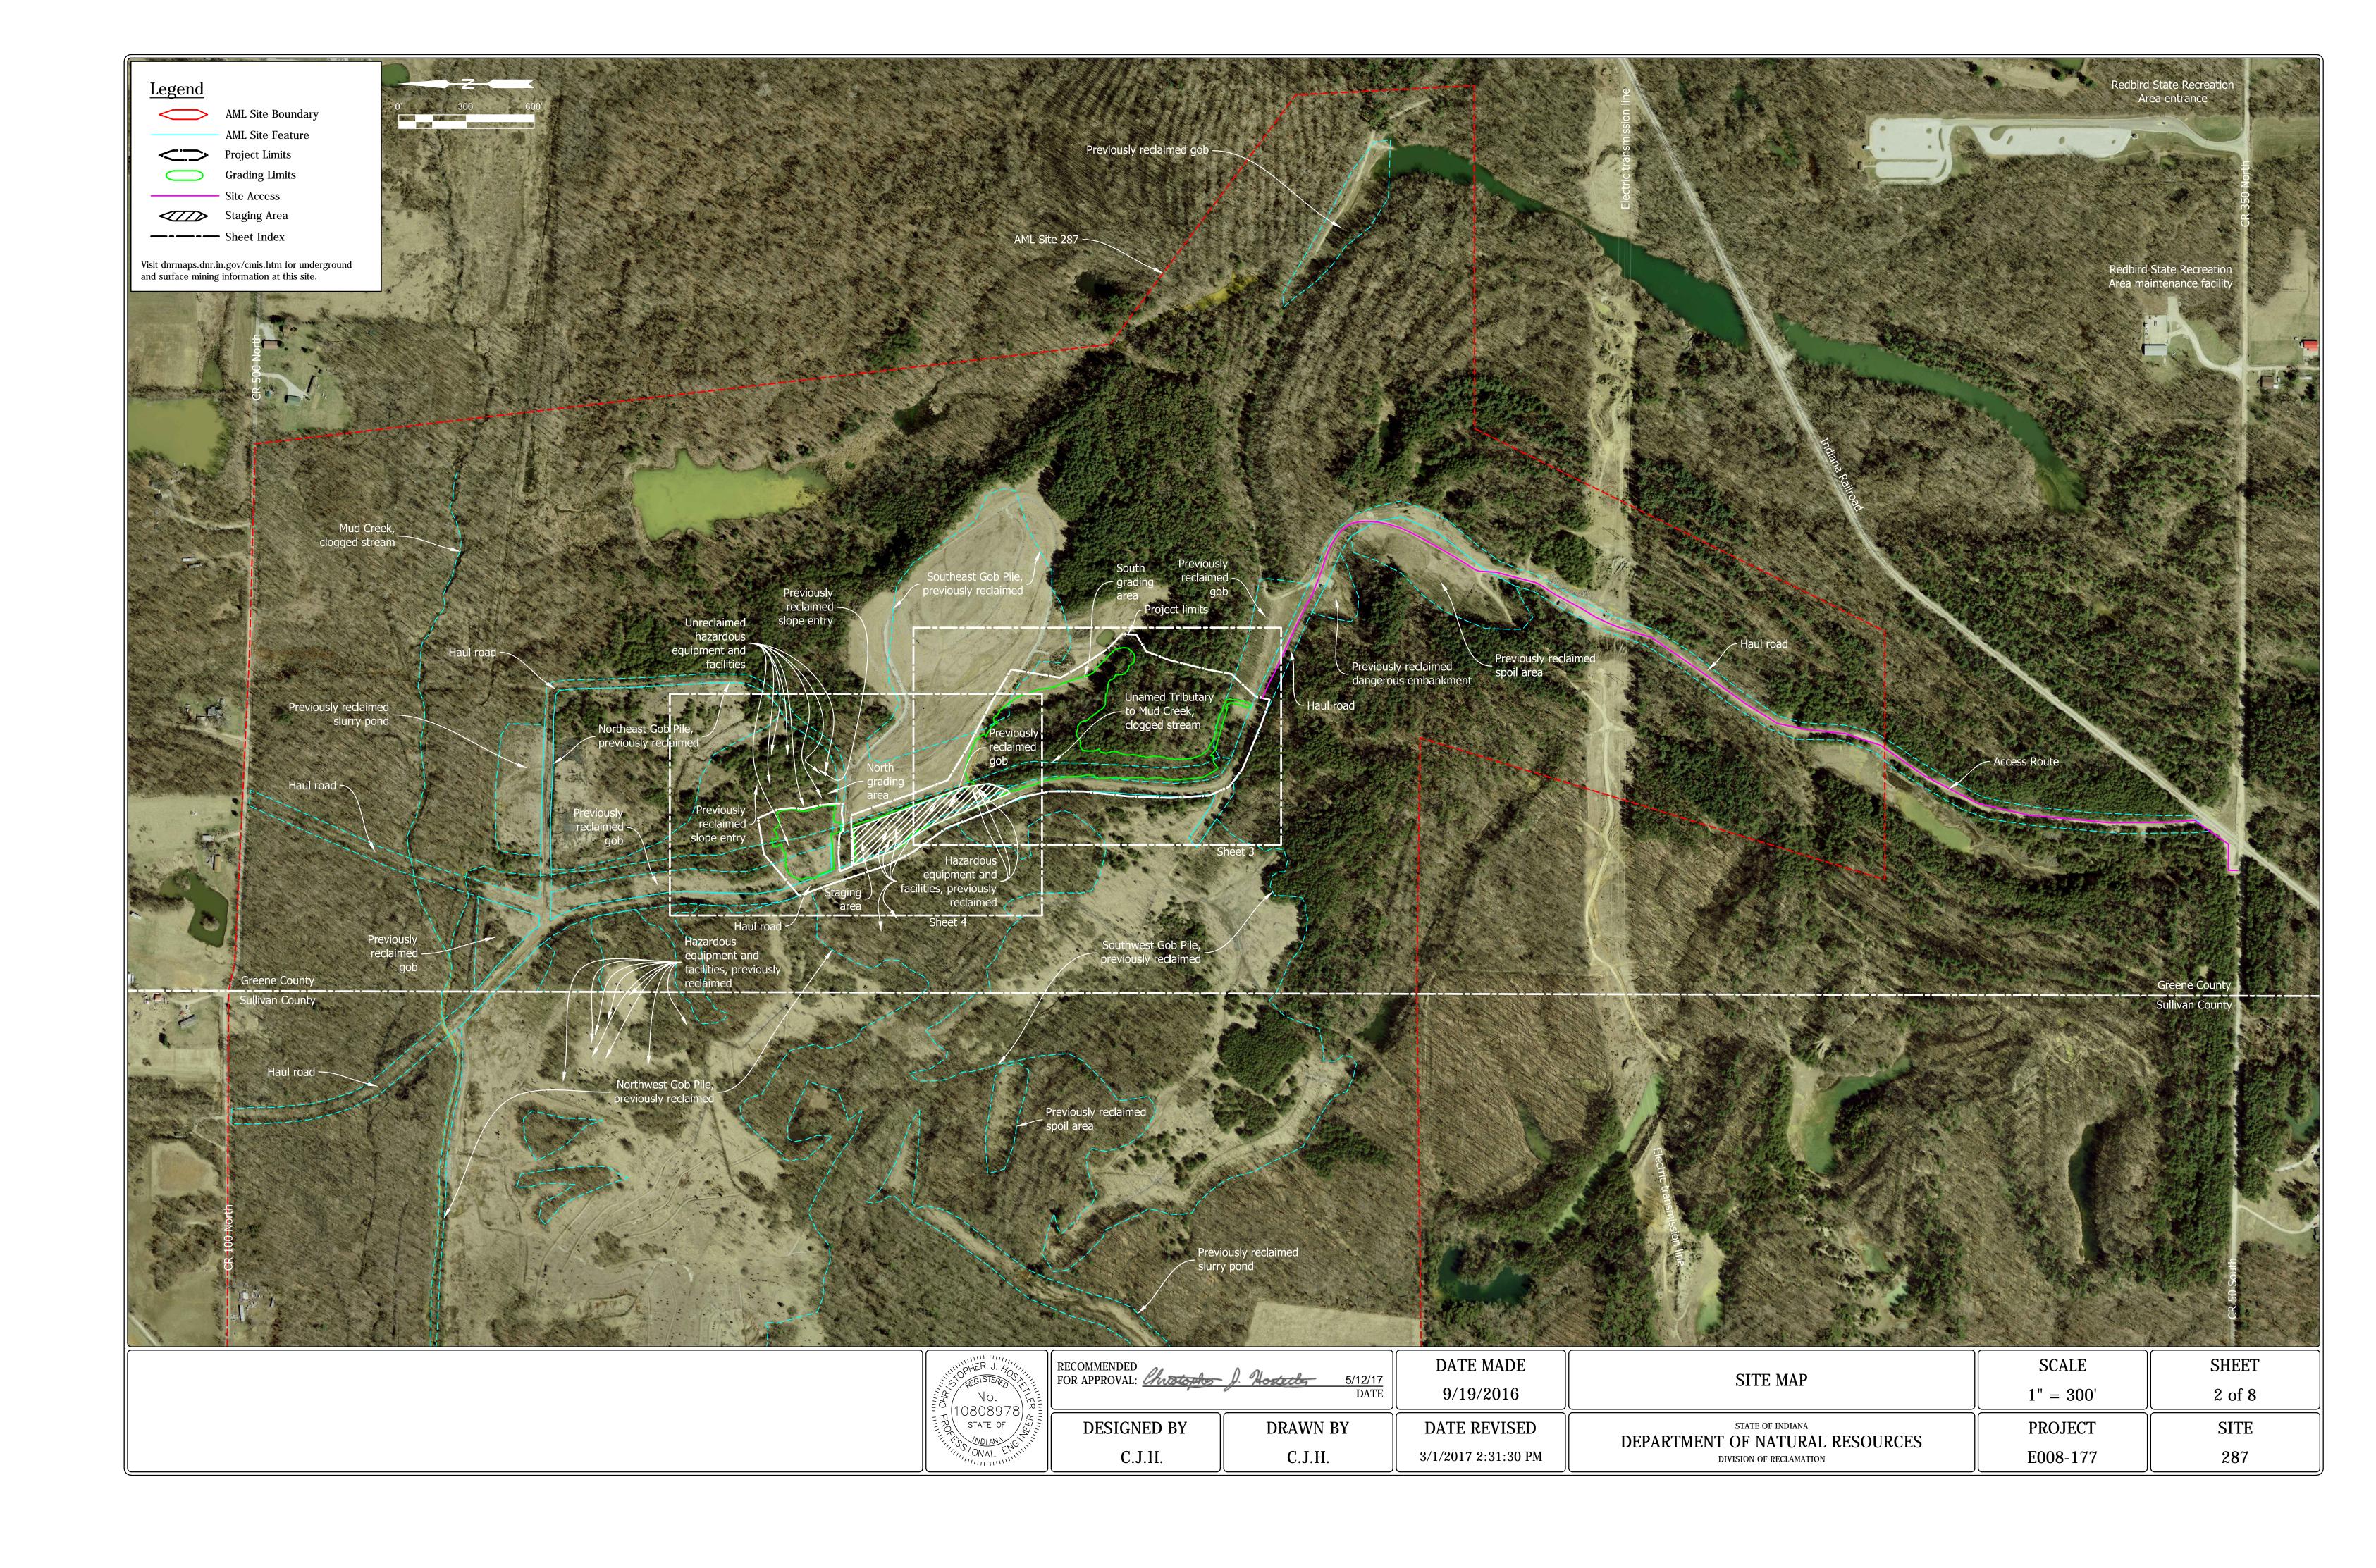


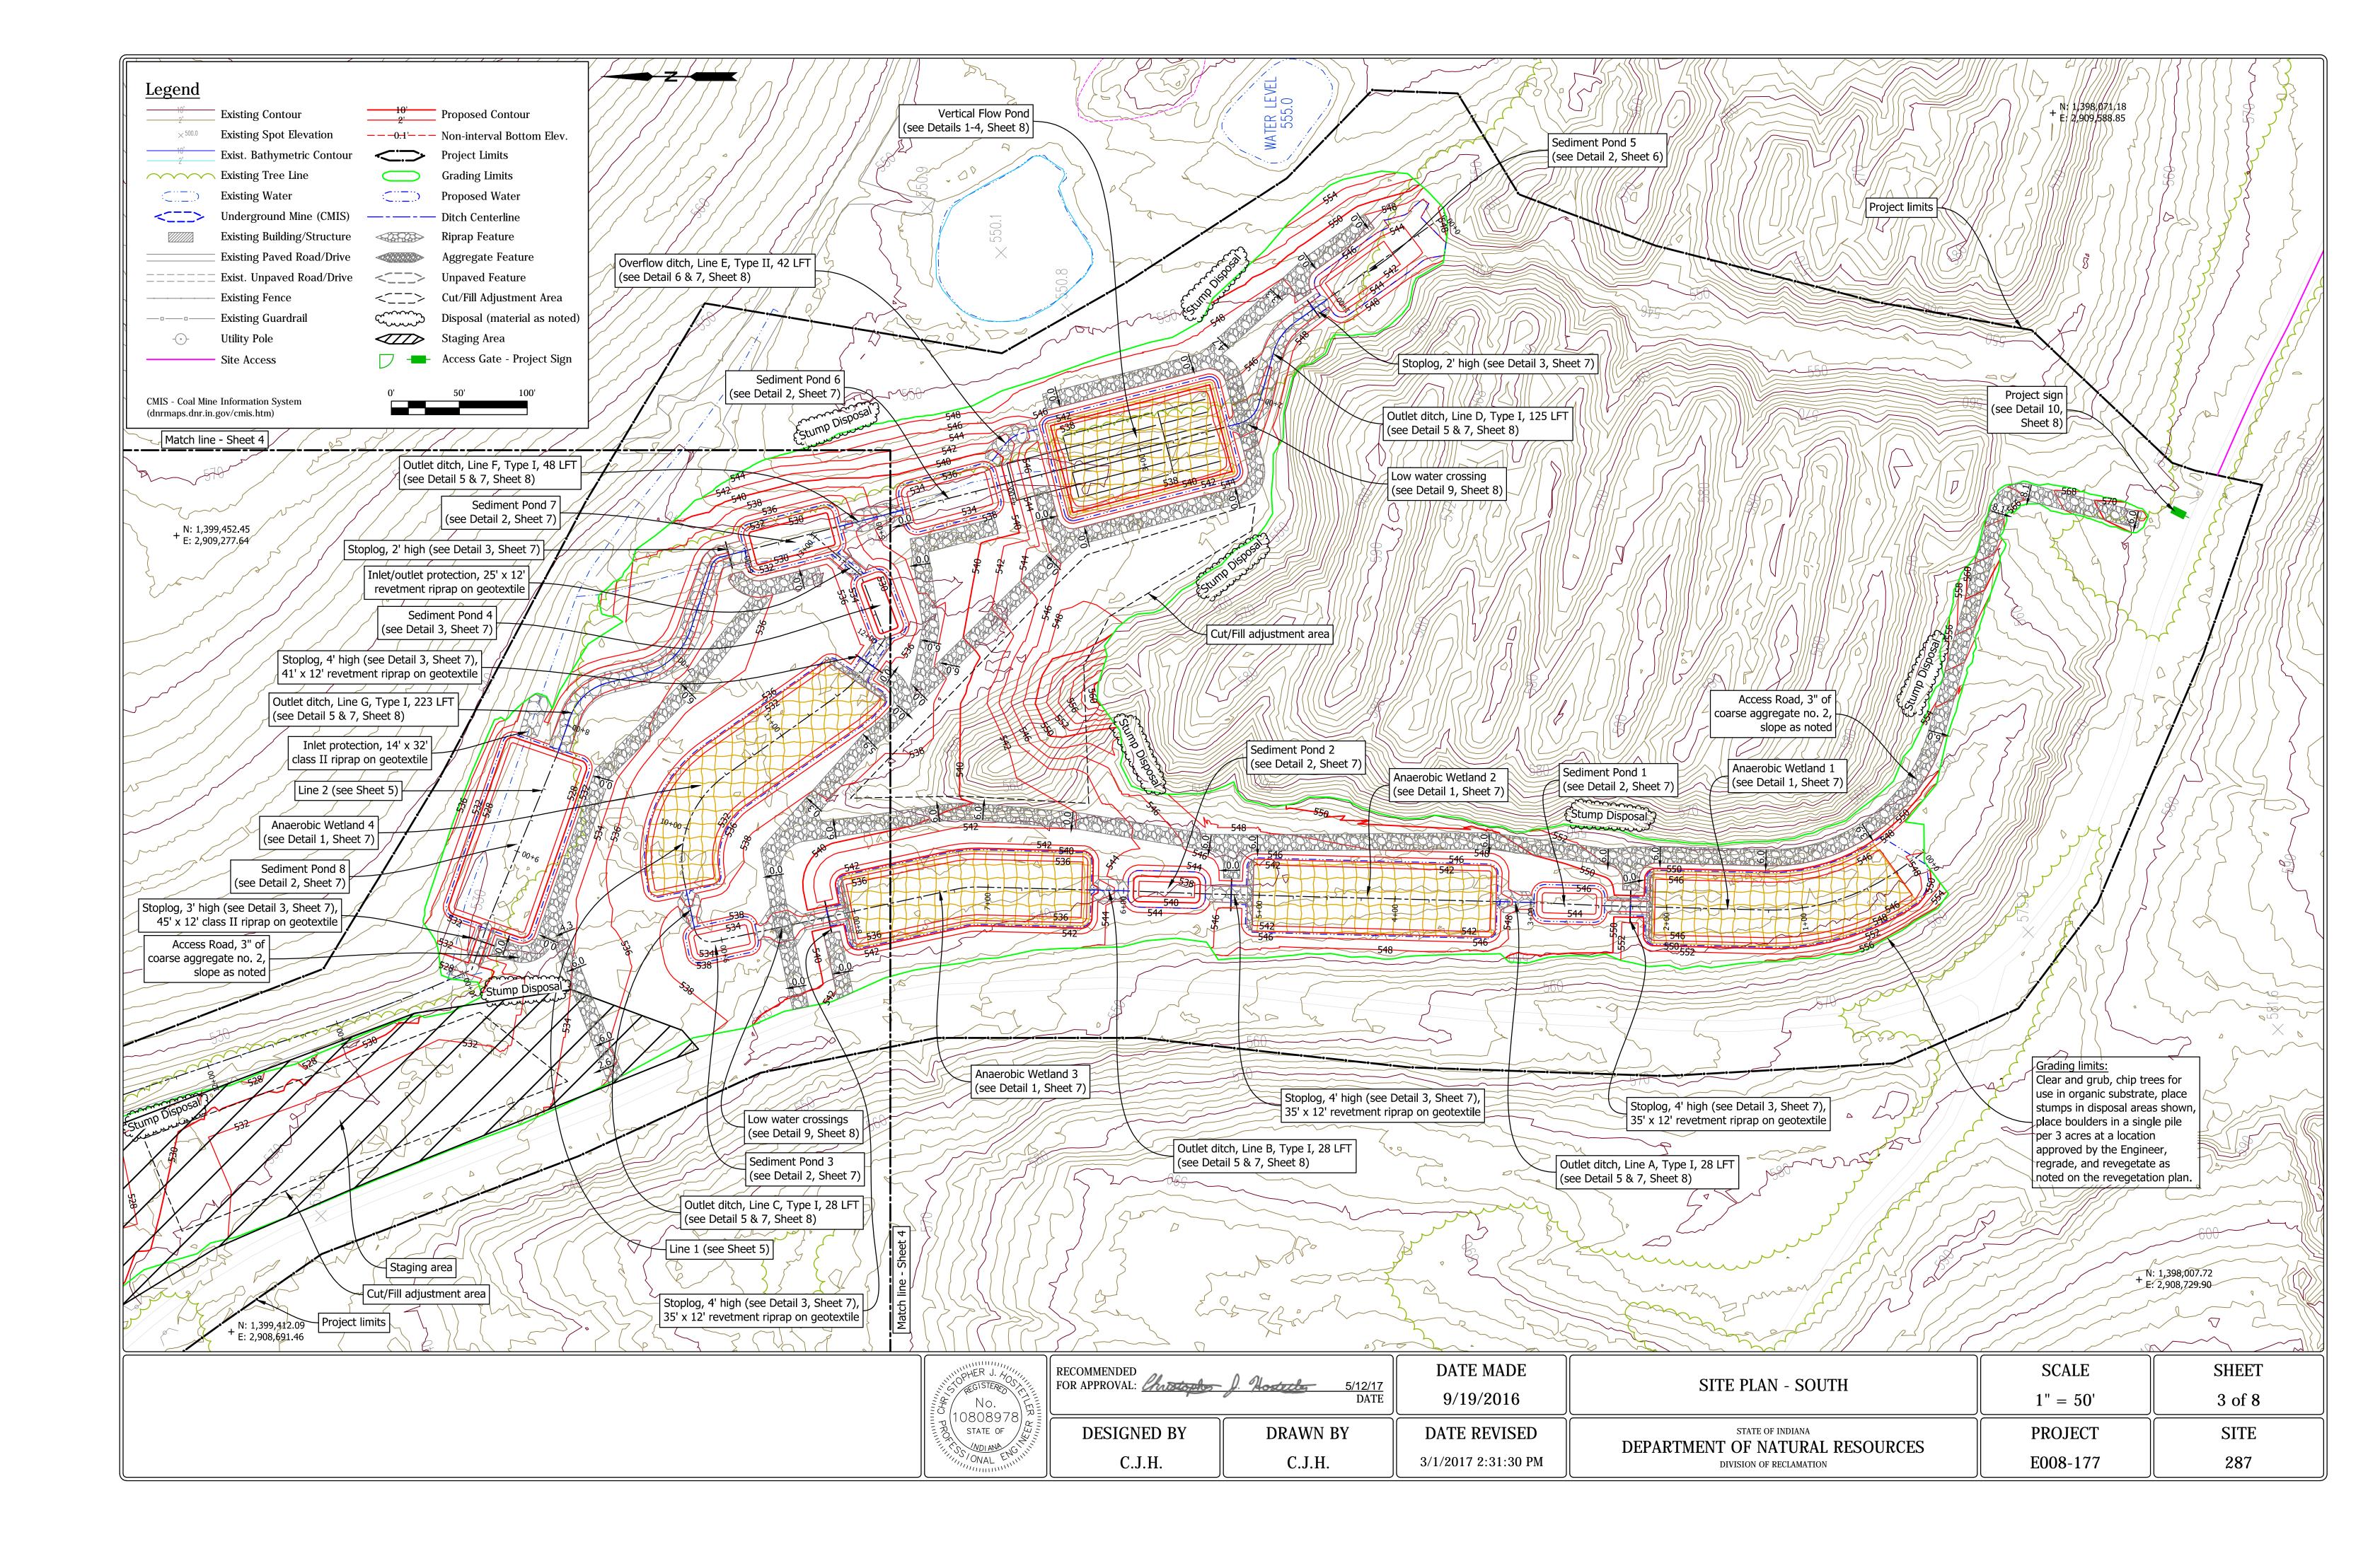


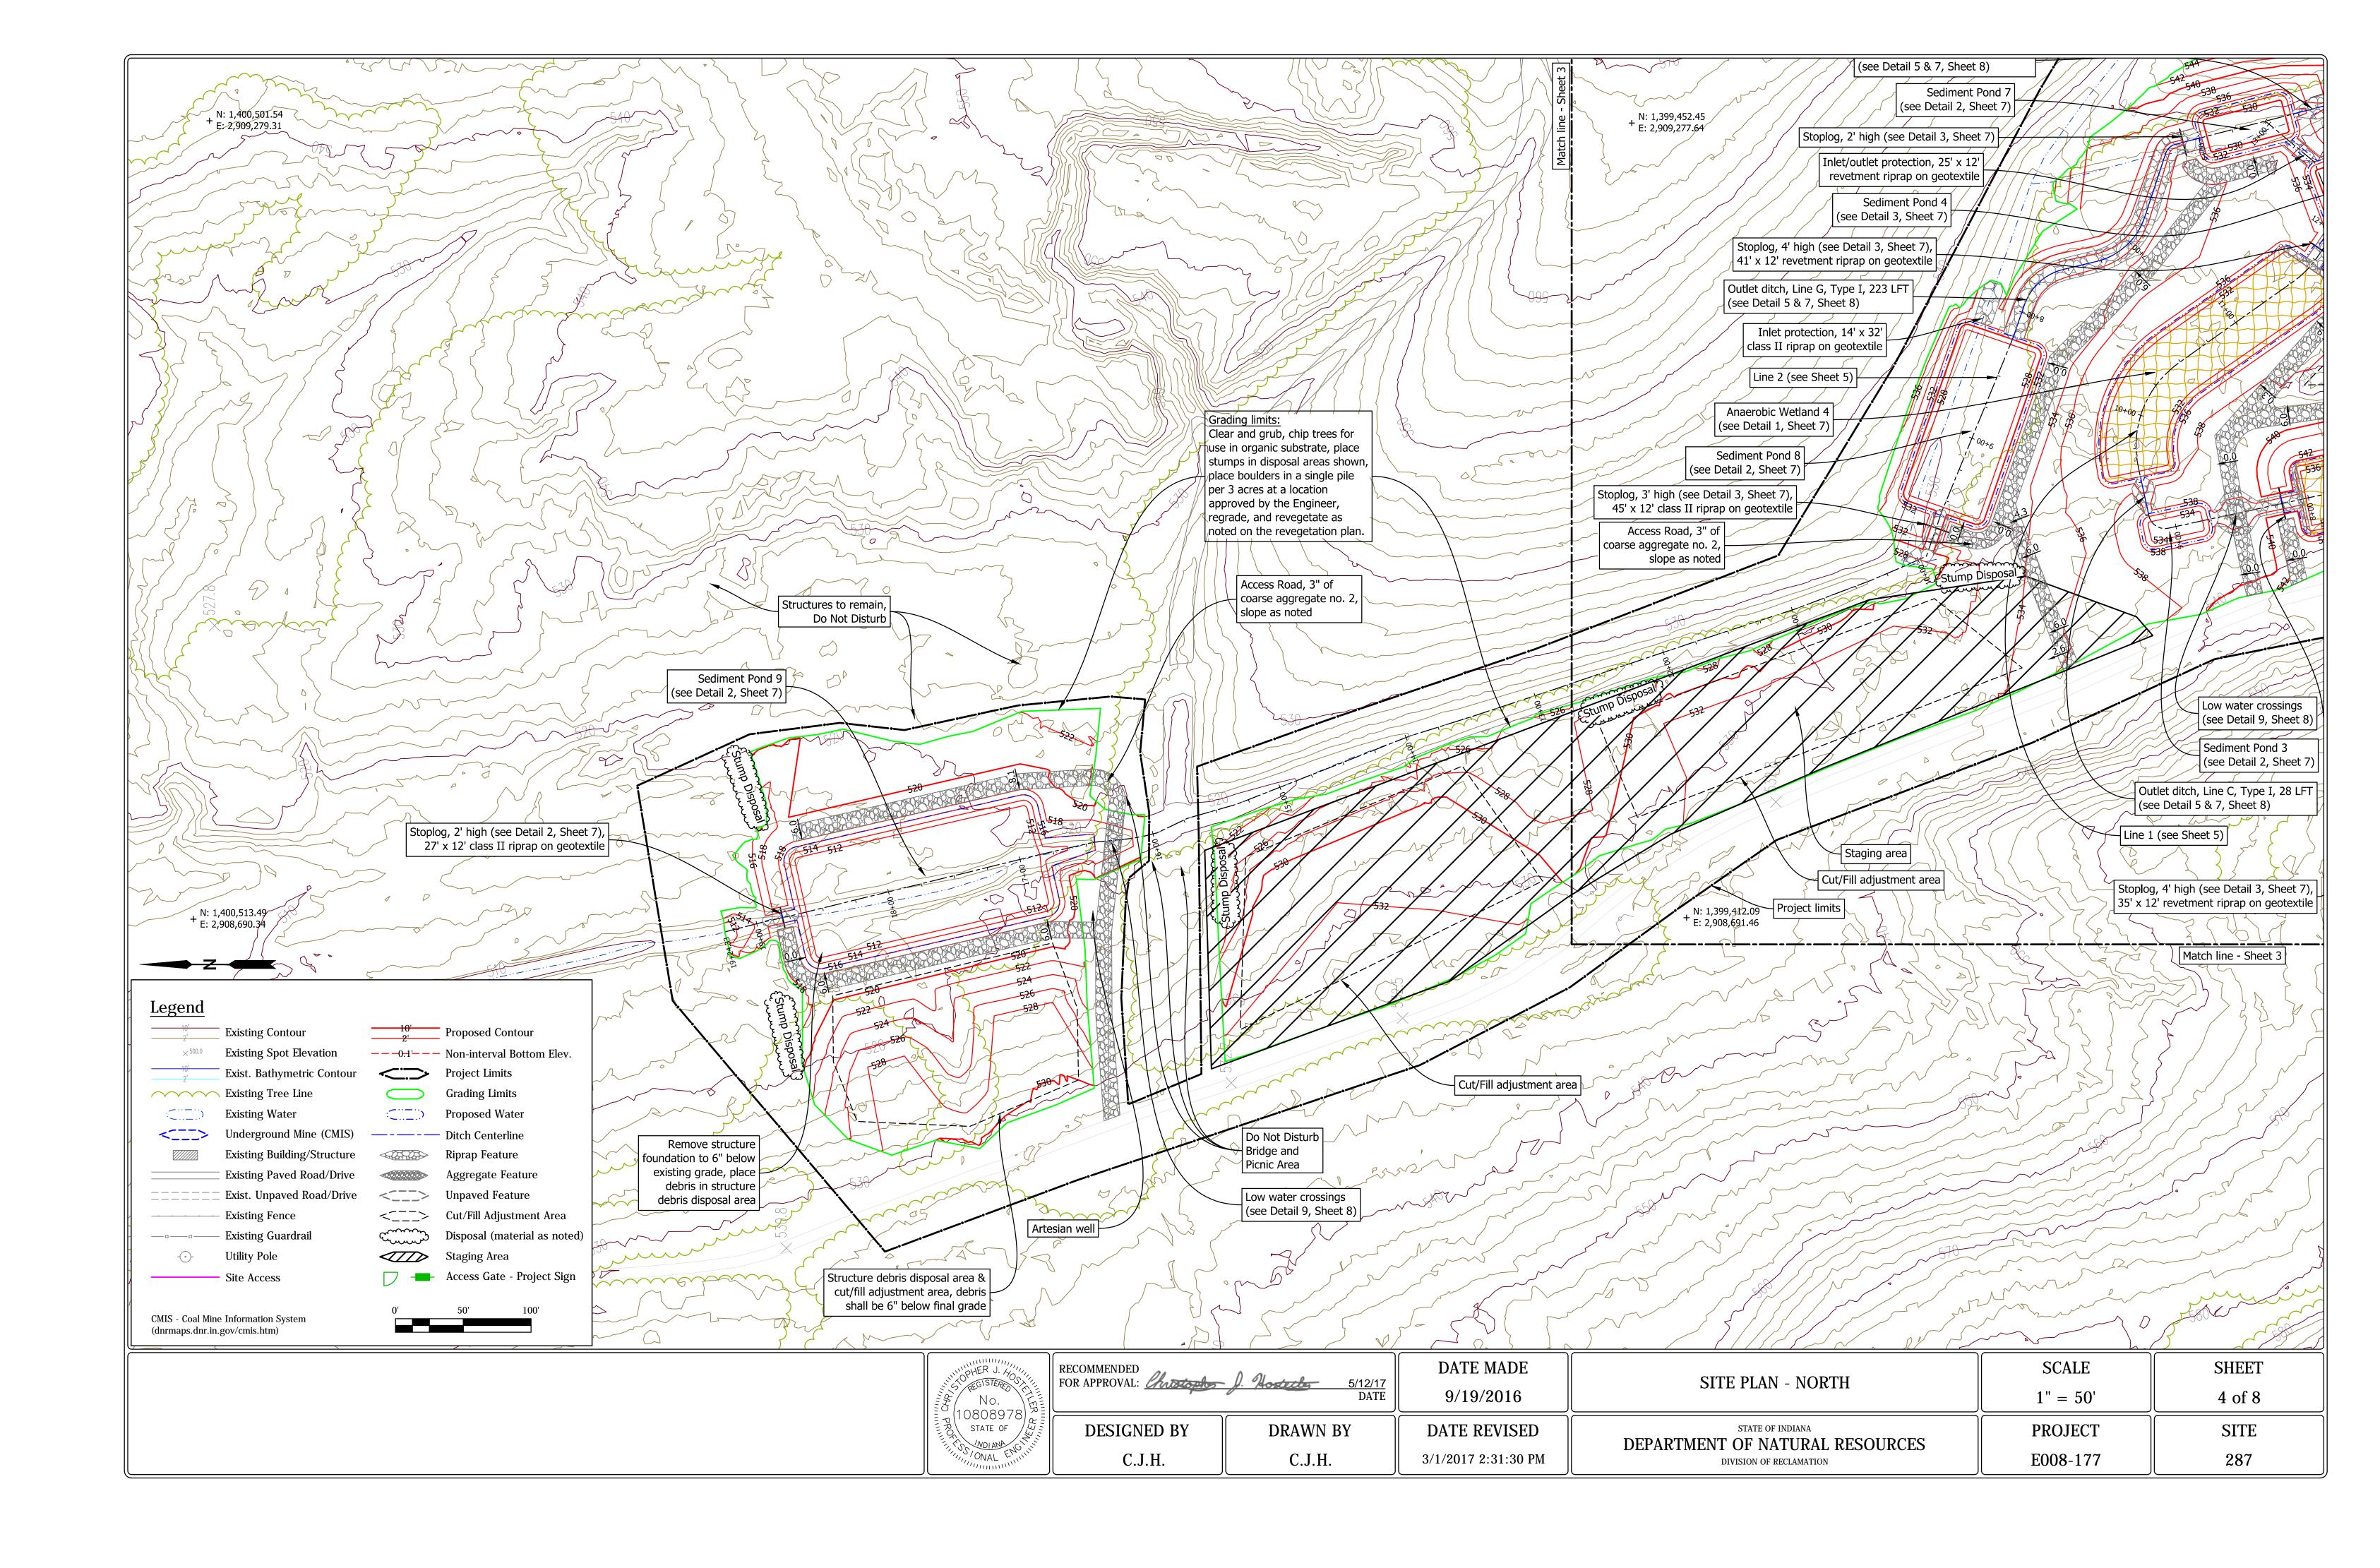


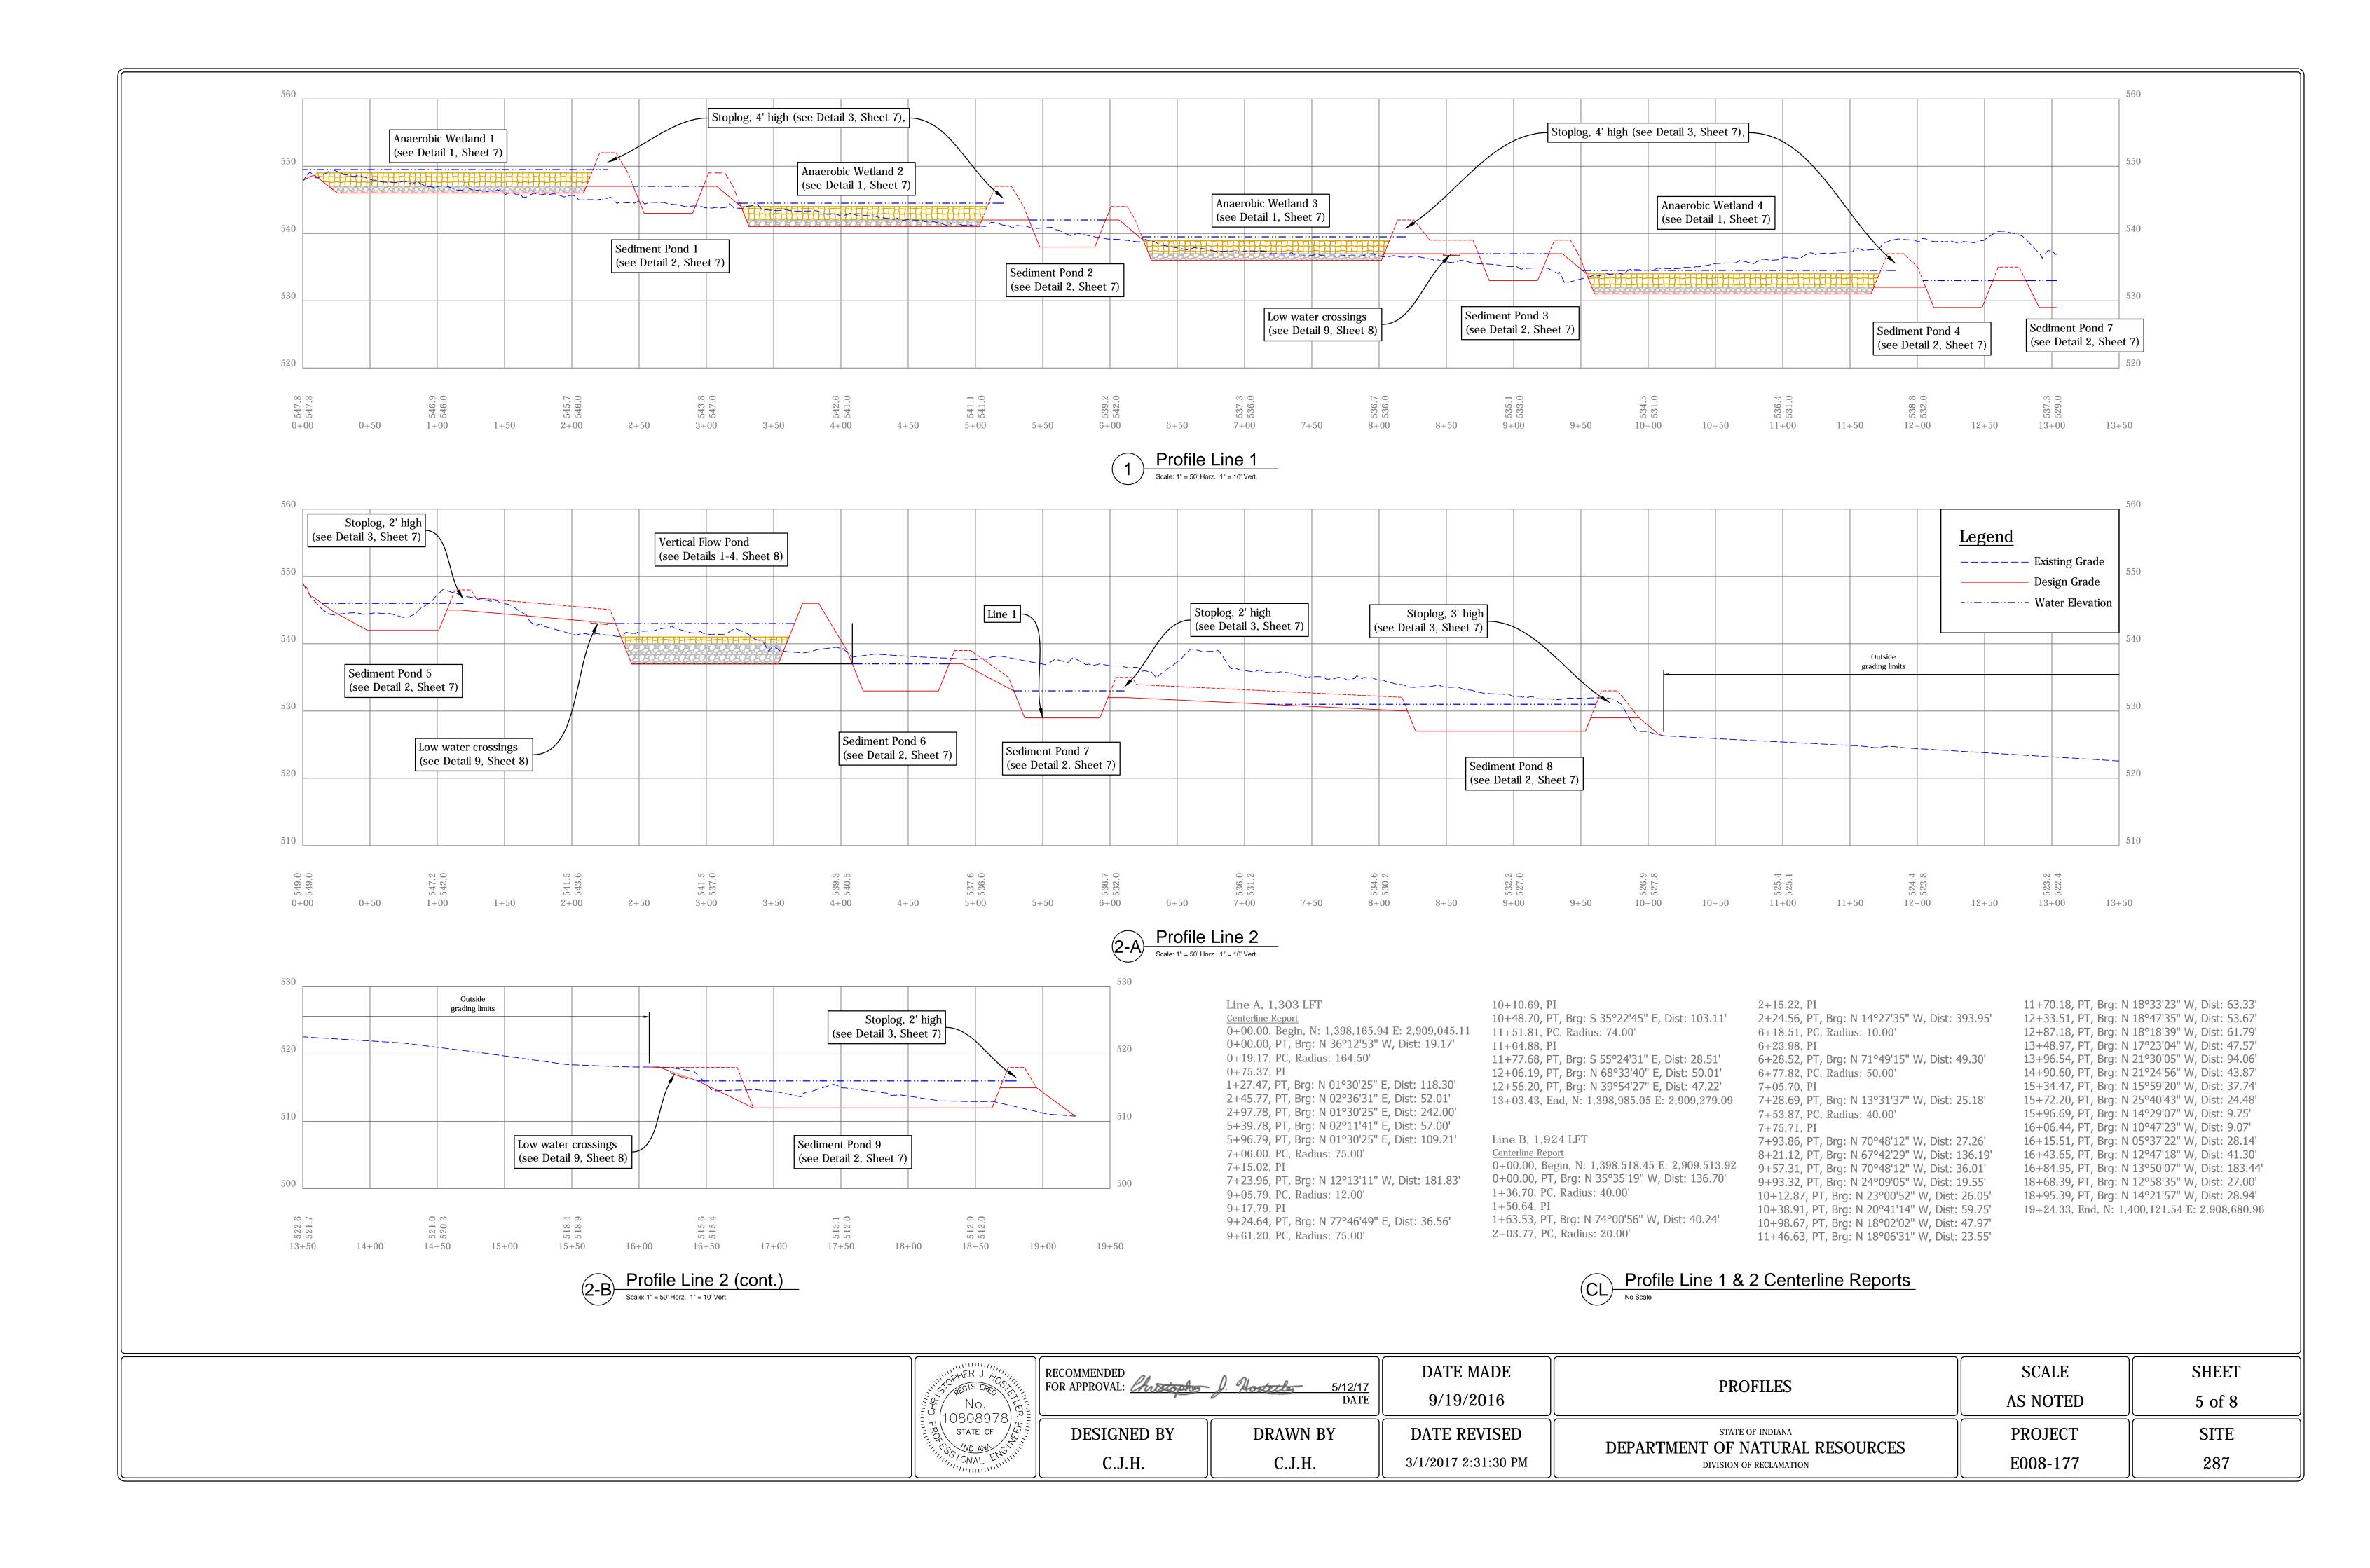

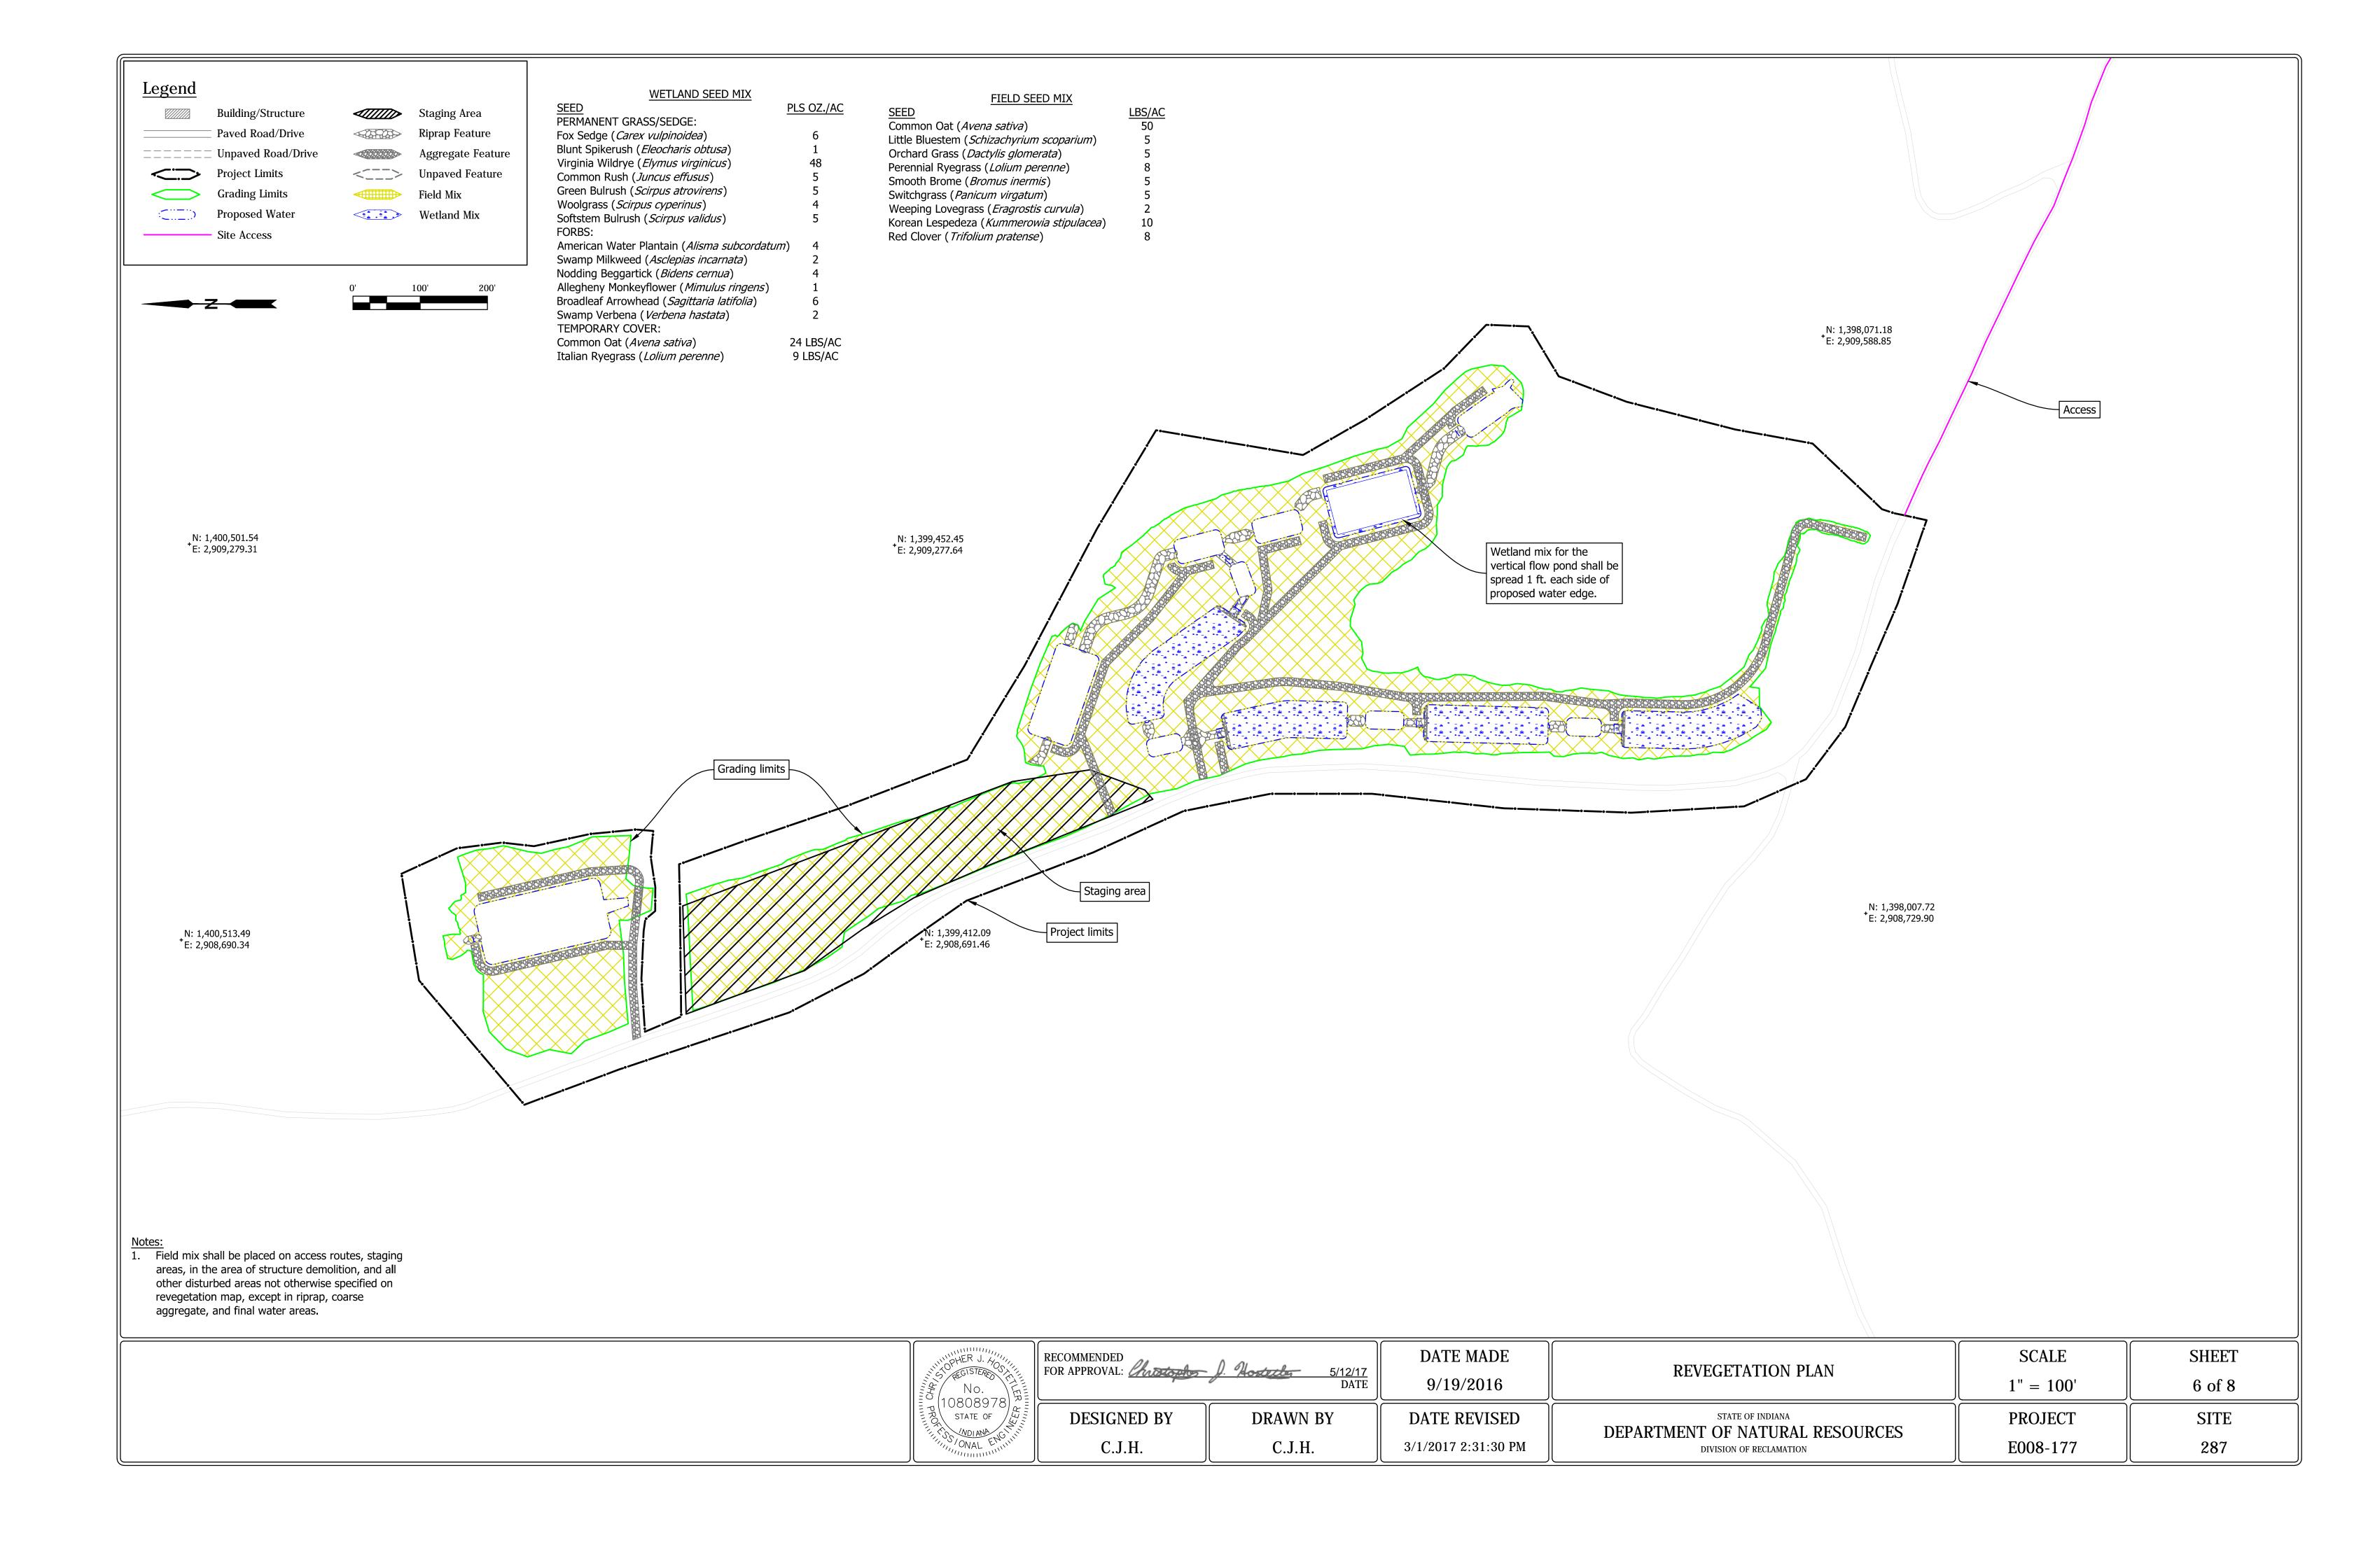


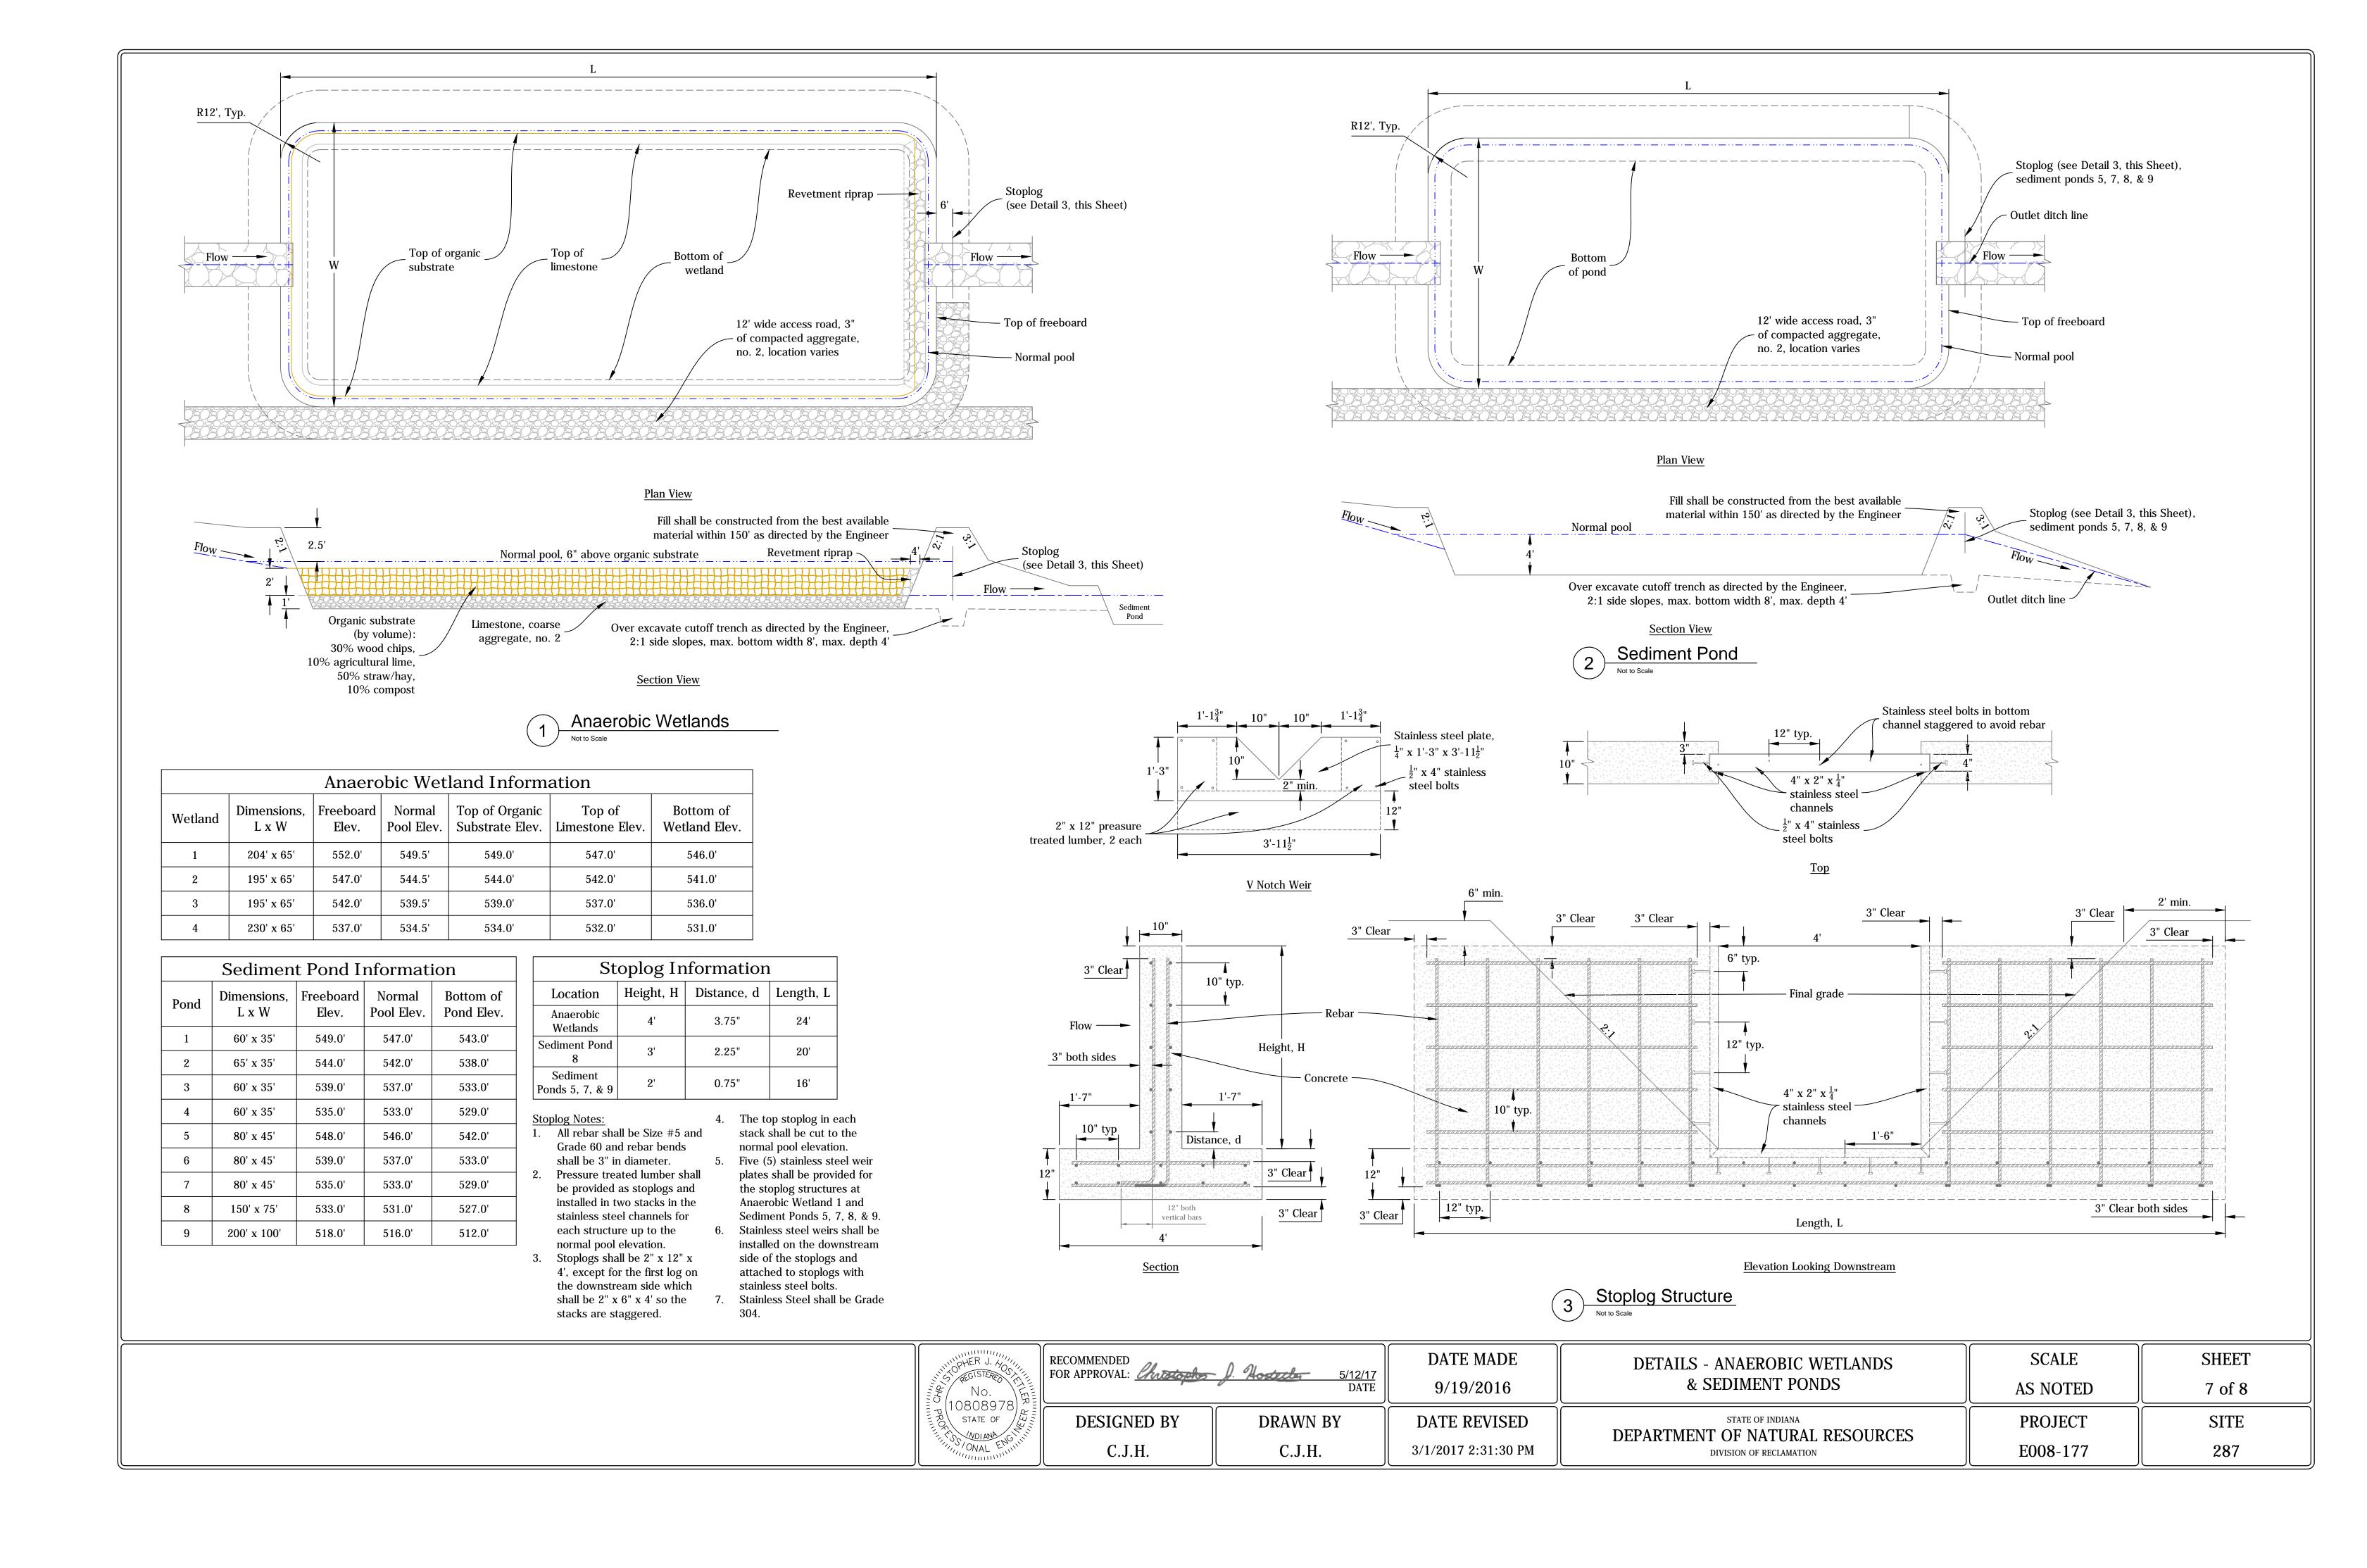

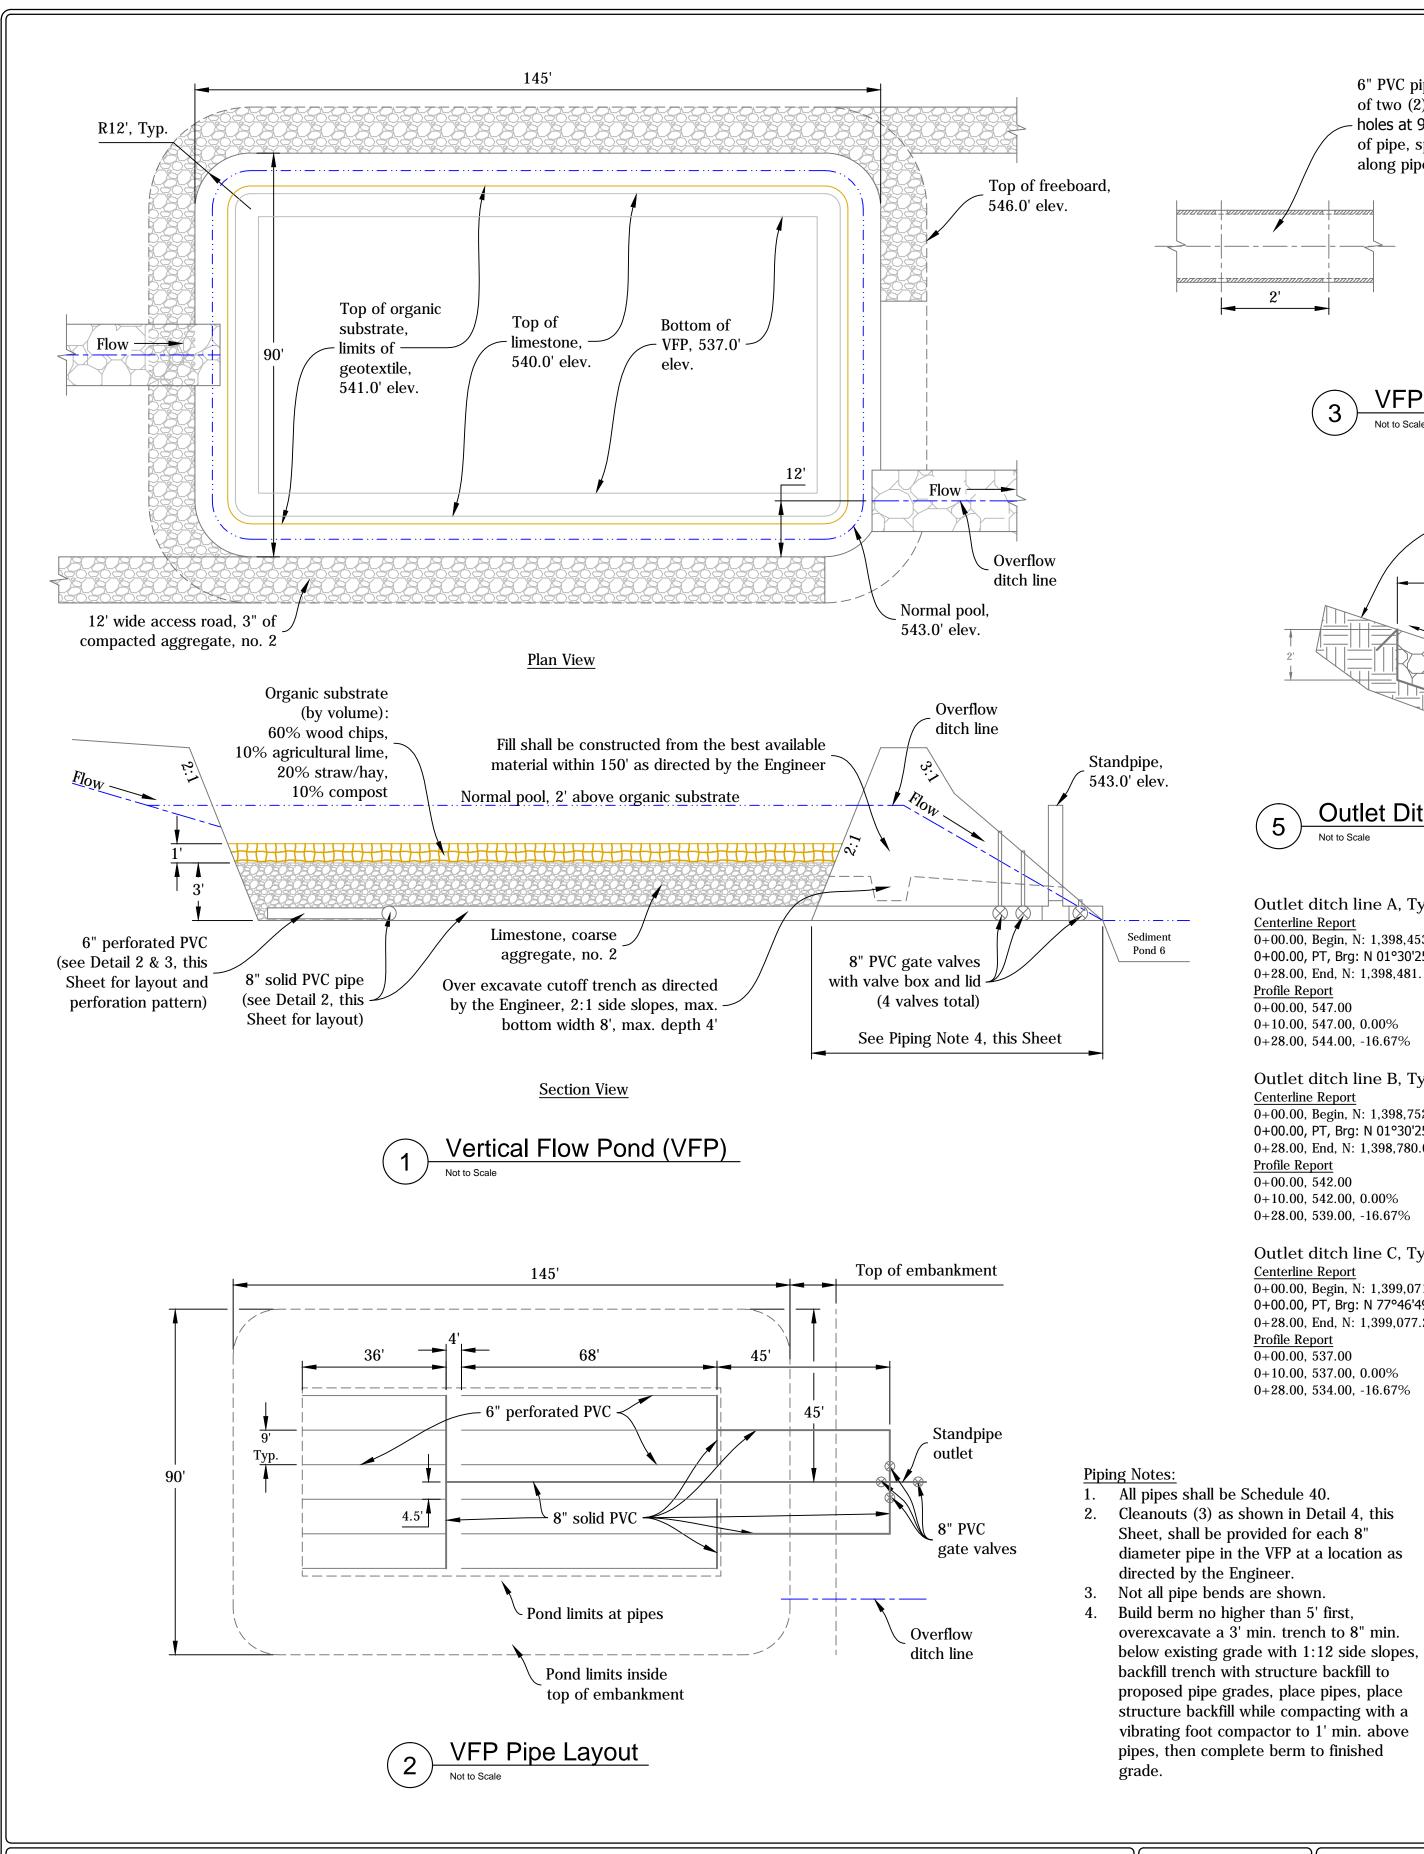

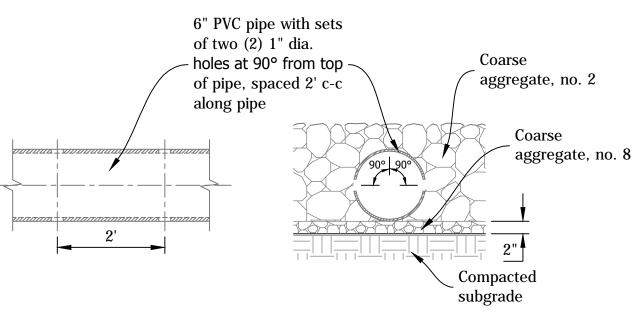

### VFP Perforation Pattern

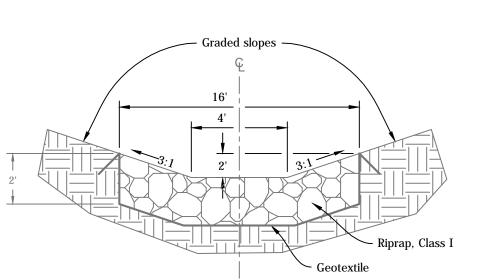

# Outlet Ditch Lines A-D & F-G, Type I

#### Outlet ditch line A, Type I, 28 LFT Centerline Report 0+00.00, Begin, N: 1,398,453.14 E: 2,909,007.54 0+00.00, PT, Brg: N 01°30'25" E, Dist: 28.00' 0+28.00, End, N: 1,398,481.13 E: 2,909,008.28 Profile Report 0+00.00, 547.000+10.00, 547.00, 0.00%0+28.00, 544.00, -16.67%

Outlet ditch line B, Type I, 28 LFT Centerline Report 0+00.00, Begin, N: 1,398,752.02 E: 2,909,016.09 0+00.00, PT, Brg: N 01°30'25" E, Dist: 4.00' 0+28.00, End, N: 1,398,780.01 E: 2,909,016.82 Profile Report 0+00.00, 542.00 $0+10.00,\ 542.00,\ 0.00\%$ 0+28.00, 539.00, -16.67%

Outlet ditch line C, Type I, 28 LFT Centerline Report 0+00.00, Begin, N: 1,399,071.33 E: 2,908,989.45 0+00.00, PT, Brg: N 77°46'49" E, Dist: 4.00' 0+28.00, End, N: 1,399,077.25 E: 2,909,016.82 Profile Report 0+00.00, 537.000+10.00, 537.00, 0.00% 0+28.00, 534.00, -16.67%

#### Outlet ditch line D, Type I, 125 LFT Centerline Report 0+00.00, Begin, N: 1,398,605.63 E: 2,909,451.53

0+00.00, PT, Brg: N 35°35'19" W, Dist: 29.50' 0+29.50, PC, Radius: 40.00' 0+43.44, PI 0+56.33, PT, Brg: N 74°00'56" W, Dist: 40.24' 0+96.57, PC, Radius: 20.00' 1+08.01, PI 1+17.36, PT, Brg: N 14°27'35" W, Dist: 7.97' 1+25.33, End, N: 1,398,677.84 E: 2,909,358.31 Profile Report 0+00.00, 545.00

0+10.00, 545.00, 0.00%

Profile Report

0+00.00, 545.00

0+42.47, 539.00, -14.13%

1+25.33, 543.00, -1.73%

Outlet ditch line E, Type I, 42 LFT Centerline Report 0+00.00, Begin, N: 1,398,818.74, E: 2,909,356.06 0+00.00, PT, Brg: N 14°27'35" W, Dist: 11.32' 0+11.32, PC, Radius: 24.00' 0+19.50, PI 0+27.09, PT, Brg: N 52°05'44" W, Dist: 15.38' 0+42.47, End, N: 1,398,852.09 E: 2,909,332.60

Outlet ditch line F, Type I, 48 LFT Centerline Report 0+00.00, Begin, N: 1,398,917.98 E: 2,909,296.39 0+00.00, Brg: N 14°27'35" W, Dist: 48.00' 0+48.00, End, N: 1,398,964.46 E: 2,909,284.40 Profile Report 0+00.00, 537.000+10.00, 537.00, 0.00%

0+48.00, 533.00, -10.53%

0+00.00, 532.00

 $0+14.00,\ 532.00,\ 0.00\%$ 

2+22.58, 530.00, -0.96%

4" gasketed cap

Final grade

4" PVC pipe

45° Wye

- Graded slopes

Overflow Ditch Line E, Type II


**─** Flow

∼8" PVC pipe


Pipe Cleanout

Outlet ditch line G, Type I, 223 LFT Centerline Report 0+00.00, Begin, N: 1,399,032.24, E: 2,909,266.92 0+00.00, PT, Brg: N 14°27'35" W, Dist: 19.97' 0+19.97, PC, Radius: 10.00' 0+25.44, PI 0+29.98, PT, Brg: N 71°49'15" W, Dist: 49.30' 0+79.28, PC, Radius: 50.00' 1+07.17, PI 1+30.15, PT, Brg: N 13°31'37" W, Dist: 25.18' 1+55.33, PC, Radius: 40.00' 1+77.18, PI 1+95.32, PT, Brg: N 70°48'12" W, Dist: 27.26' 2+22.58, End, N: 1,399,171.64 E: 2,909,118.15 Profile Report

### Outlet Ditch Lines - Centerline & Profile Reports

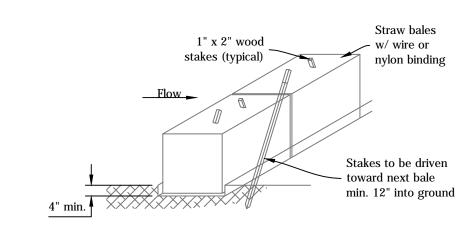

## Temporary Check Dam, Straw Bale Not to Scale

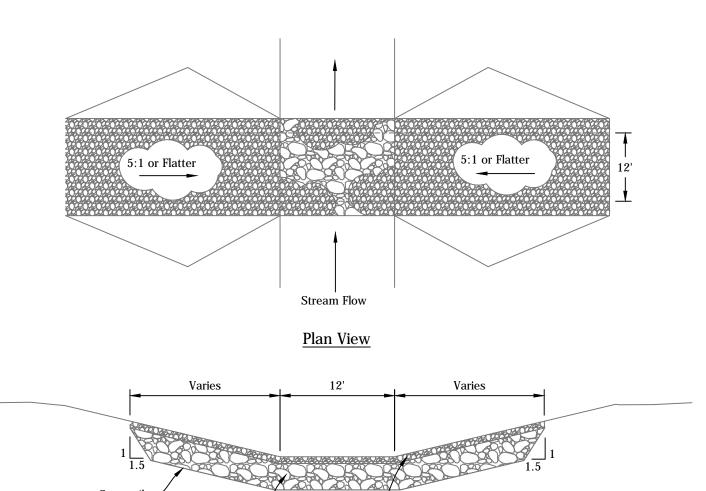

#### **Profile Along Center Line of Crossing**


1. Compact surfacing material by equipment travel. The finished top surface of the rock in the bottom of the channel shall be no higher than the ditch bottom at the upstream edge of the crossing. It is expected that surfacing material will have to be replaced following high flow events.

3" of compacted aggregate no. 53 -

- 2. Blend approaches.
- 3. Runoff shall be diverted from the approach.

18" of Revetment Riprap

### Low Water Crossing

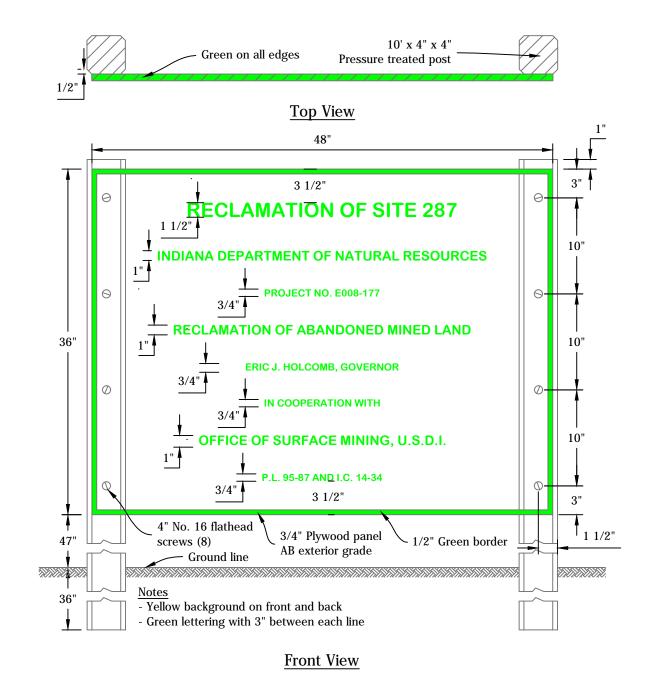

### Project Sign Not to Scale

		RECOMMENDED FOR APPROVAL:	J. Hostelle 5/12/17 DATE	DATE MADE 9/19/2016	DETAILS - VERTICAL FLOW POND	SCALE AS NOTED	SHEET 8 of 8
STATE OF WOLANA CONTINUES ON AL ENTITION ON AL ENTITION ON AL ENTITION ON AL ENTITION OF THE PROPERTY OF THE P	DESIGNED BY	DRAWN BY	DATE REVISED	STATE OF INDIANA DEPARTMENT OF NATURAL RESOURCES	PROJECT	SITE	
	ONAL EMILIA	C.J.H.	C.J.H.	3/1/2017 2:31:30 PM	DEPARTIMENT OF INATURAL RESOURCES  DIVISION OF RECLAMATION	E008-177	287