



PRINT DATE: 4/9/23  
 PLOT SCALE: 1:1  
 EDIT DATE: 1/21/21 11:55 AM  
 CREDITED BY: EDWARD L. BROWNING  
 DRAWING FILE: P:\3-066-555-WHITE CD\WORKDIR\REVISION\2101828\_24062023\_IND0304P\_IND0304P\_INSD0304P

**UTILITIES**

UTILITY	OWNER	ADDRESS
Electric	Carroll White REMC	P.O. Box 599 Monticello, IN 47960 Contact: Travis Curtis tcurs@cwremc.com Ph.: 574-583-0251 (o) 765-202-0235 (c)
Gas	NIPSCO Gas	801 E 86th Avenue Merrillville, IN 46410 Contact: Dean Garrett utilitycoordination@nisource.com Ph.: 219-647-6260
Pipeline	BP Pipeline Co.	30 South Wacker Drive Chicago, IL 60606 Contact: Thorin Burke thorin.burke@bp.com Ph.: 331-239-9744
Water & Sewer	Brookston Municipal Utilities	205 E 3rd Street Brookston, IN 47923 Contact: Josh Denlinger jdtownofbrookston@gmail.com Ph.: 765-563-3171 (o) 317-619-9808 (c)
Telecommunications	Comcast Cable	720 Taylor Street Fort Wayne, IN 46802 Contact: Doug Fishburn William_fishburn@cable.comcast.com Ph.: 260-410-3504
	Lumen (Local & National)	1409 E Grace Street Rensselaer, IN 47978 Contact: Rob Smith robert.d.smith@lumen.com Ph.: 219-866-4702
	MCI/Verizon	6835 Hillsdale Court Indianapolis, IN 46250 Contact: Roland Craig dennis.craig@verizon.com Ph.: 317-498-1242
	Zayo Bandwidth	9209 Castlegate Drive Indianapolis, IN 46256 Contact: Waylon Higgins inky_relo@zayo.com Ph.: 765-341-1199
Environmental	Creek Run, LLC	1 Creek Run Drive Montpelier, IN 47359 Contact: Luke Libby llbby@creekrun.com Ph.: 765-728-8051 (o) 765-728-3041 (c)

**GENERAL NOTES**

- \*\* This set of Plans shall not be construed to be a property retracement survey. Where apparent property lines, corners, subdivision or section corner information are shown, they are based on physical evidence or testimony.
- \*\* These plans show the location of the utilities as existing in the field by the respective utility companies; therefore, the firm of RQAW Corporation does not accept any responsibility for the accuracy of this information.
- \*\* In accordance with Indiana Code 8-1, Chapter 26, the Contractor shall notify the Indiana Underground Plant Protection Service at 1-800-382-5544 at least two (2) full working days prior to any excavation or demolition.
- \*\* REPRESENTS GENERAL NOTES REQUIRED

**REVISIONS**

SHEET NO.	DATE	REVISED







**INDEX**

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3 - 7	TYPICAL CROSS SECTIONS
8 - 9	PLAT NO. 1
10 - 16	MAINTENANCE OF TRAFFIC
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CALL 811 OR 1-800-382-5544  
24 HOURS A DAY,  
SEVEN DAYS A WEEK

		RECOMMENDED FOR APPROVAL _____ DESIGN ENGINEER _____ DATE _____	<b>INDIANA</b> <b>DEPARTMENT OF TRANSPORTATION</b>	HORIZONTAL SCALE N/A VERTICAL SCALE N/A	BRIDGE FILE N/A DESIGNATION 2001828
DESIGNED: <u>BLW</u>	DRAWN: <u>EJK</u>	INDEX SHEET		SURVEY BOOK	SHEET
CHECKED: <u>DCK</u>	CHECKED: <u>DCK</u>			2	of 117
				CONTRACT	PROJECT
				R-00000	2000578



**NOTES:**  
 Tack Coat to be placed between all HMA layers.  
 Joint Adhesive to be installed at all joints in the surface and intermediate layers.  
 Liquid Asphalt Sealant to be placed centered on all joints.

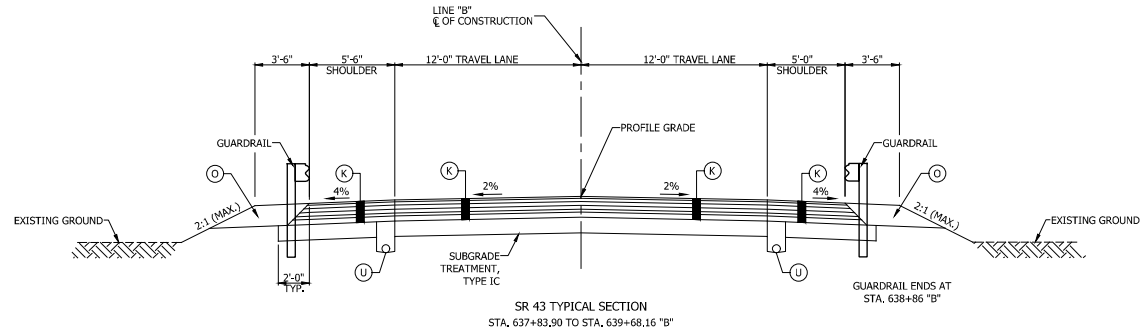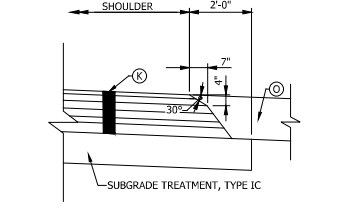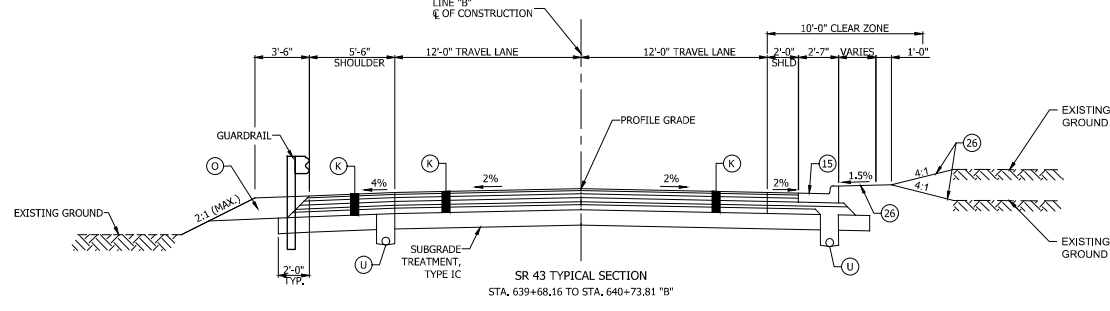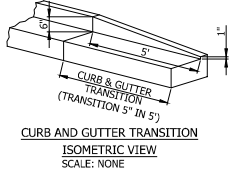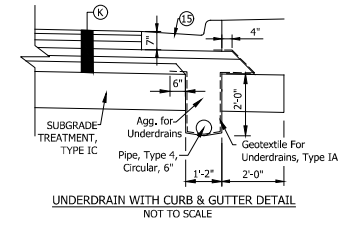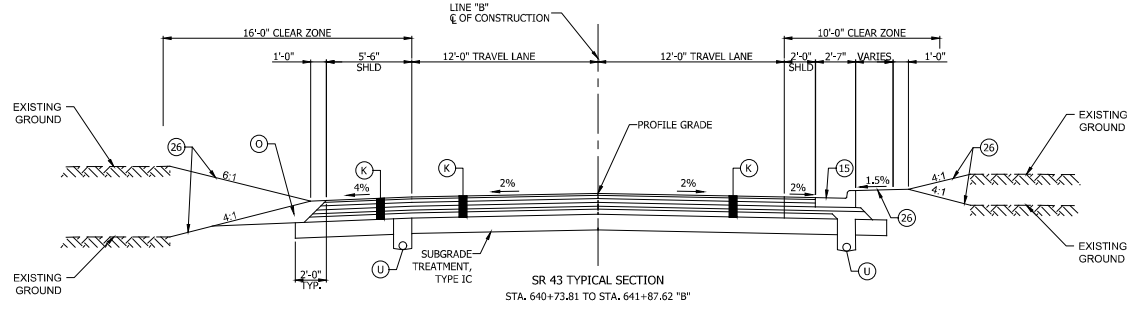LEGEND		
(E) Concrete Sidewalk, 4"	(K1) 165 lb/SYS QC/QA HMA, 3, 70, Surface 9.5 mm on 275 lb/SYS QC/QA HMA, 3, 70, Intermediate 19.0 mm on 660 lb/SYS QC/QA HMA, 3, 64, Base 19.0 mm (2 Lifts) on 6" Compacted Aggregate No. 53, Base	(W) Widening with HMA, Type C
(K) 165 lb/SYS QC/QA HMA, 3, 70, Surface 9.5 mm on 275 lb/SYS QC/QA HMA, 3, 70, Intermediate 19.0 mm on 660 lb/SYS QC/QA HMA, 3, 64, Base 19.0 mm (2 Lifts) on 250 lb/SYS QC/QA HMA, 4, 76, Intermediate OG 19.0 mm on 4" Compacted Aggregate No. 53, Base on Geotextile for Pavement, Type 2A	(O) Compacted Aggregate, No. 53	(14) Mod. Concrete Rolled Curb (Sloping)
	(R) Milling, Asphalt 1.5" (0 - 1.5" Profile Difference) 165 lb/SYS QC/QA HMA 3, 70, Surface 9.5 mm	(15) Combined Concrete Curb & Gutter
		(16) Curb, Concrete (Vertical)
		(26) Sodding, Nursery

RECOMMENDED FOR APPROVAL	DESIGN ENGINEER	DATE
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CHECKED: <u>DCK</u>	CHECKED: <u>DCK</u>	




**INDIANA DEPARTMENT OF TRANSPORTATION**

**TYPICAL CROSS SECTIONS SR 43**

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SURVEY BOOK		SHEET	
		3	of 117
CONTRACT		PROJECT	
R-43449		2001828	

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 TYPICAL TYPING

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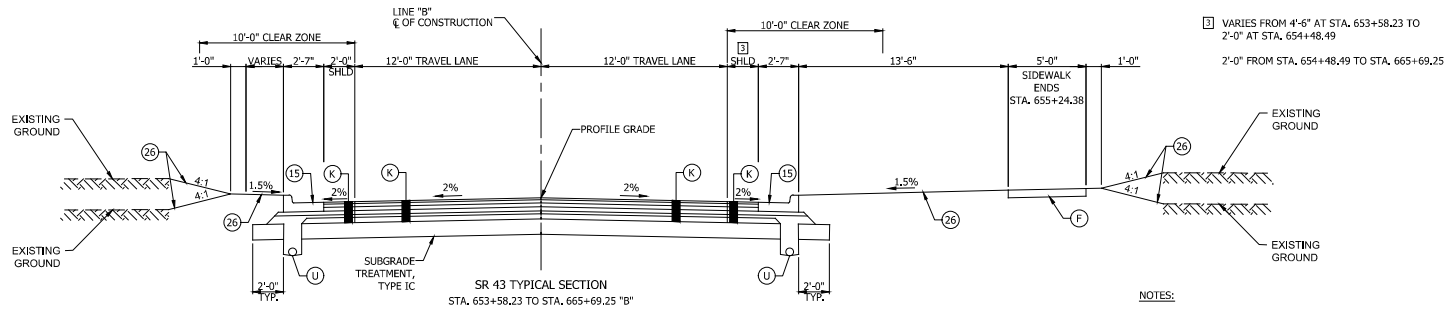
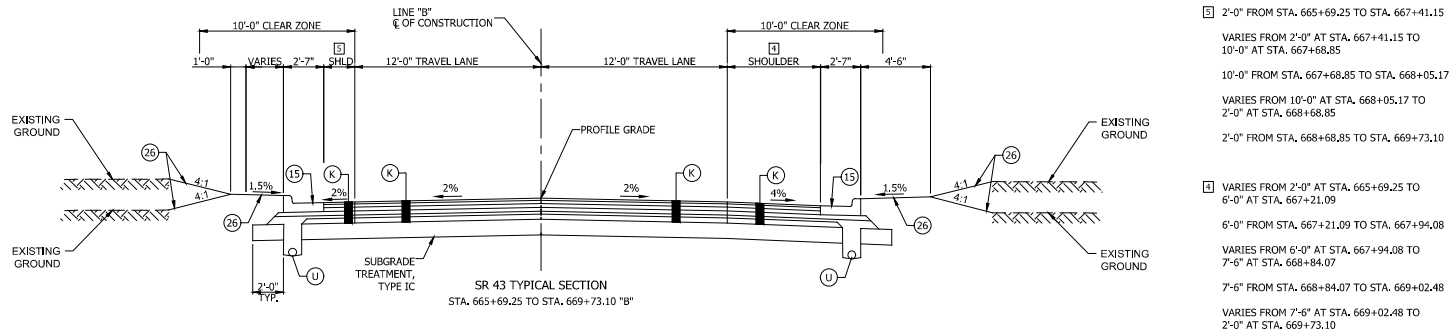
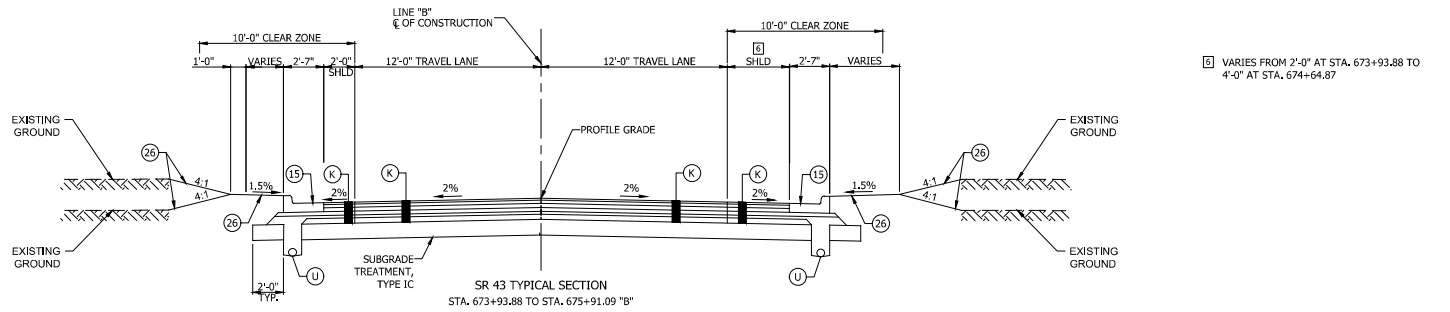
**NOTES:**  
 Tack Coat to be placed between all HMA layers.  
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 Liquid Asphalt Sealant to be placed centered on all joints.

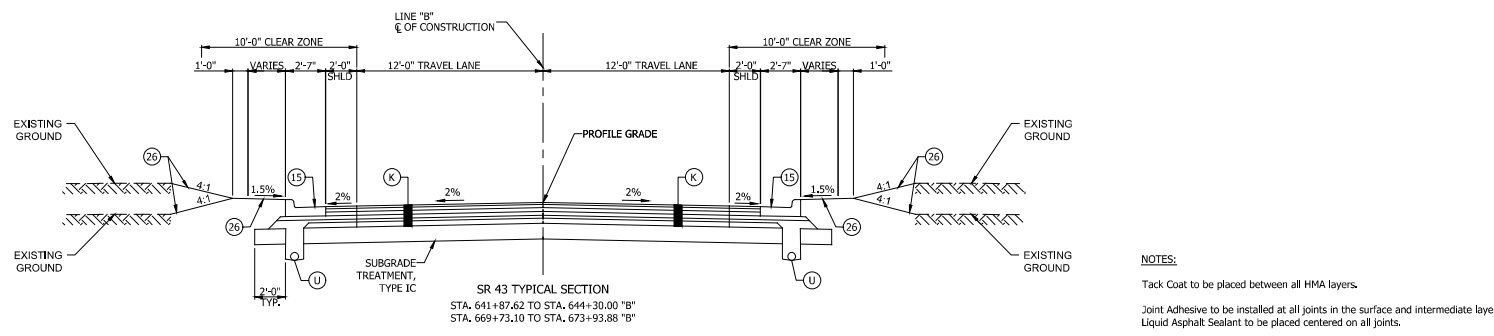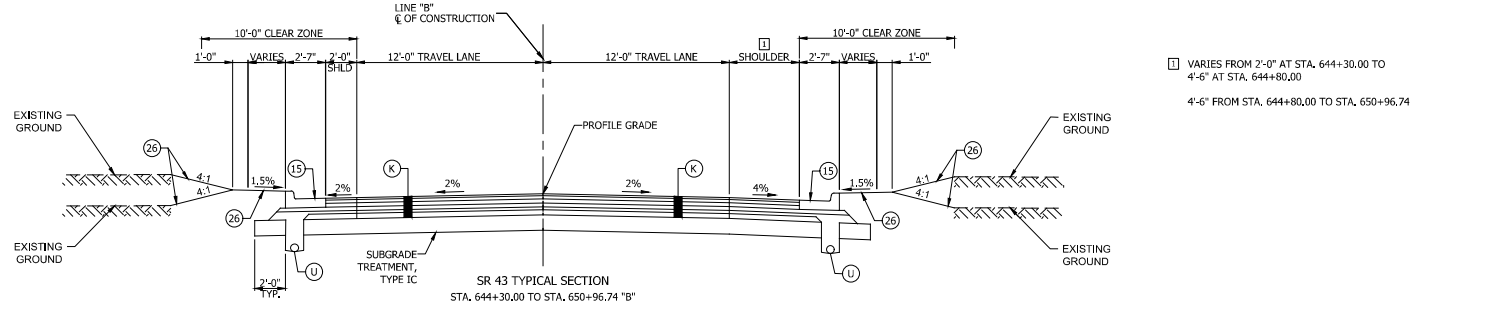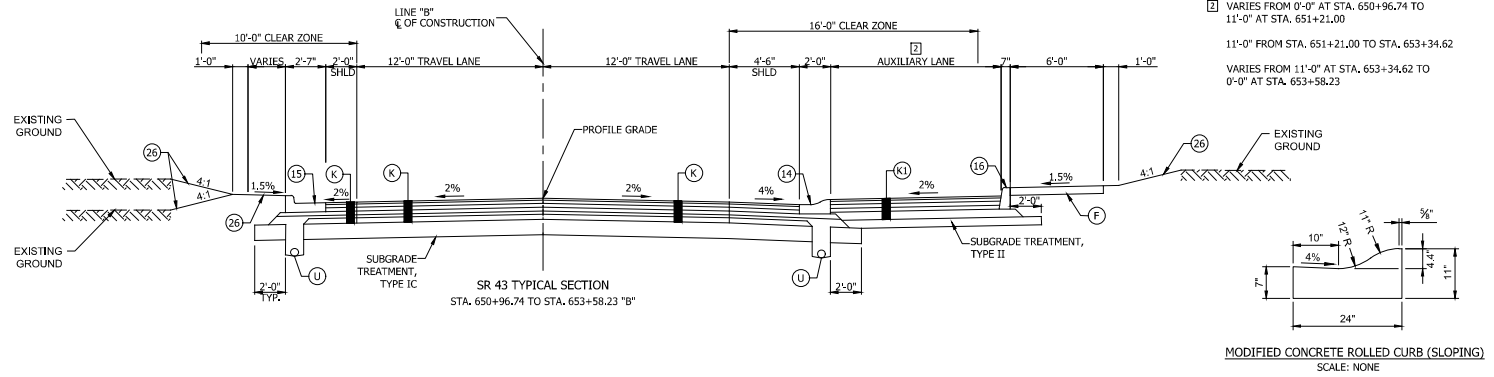LEGEND		
(F) Concrete Sidewalk, 4"	(K1) 165 lb/SYS QC/QA HMA, 3, 70, Surface 9.5 mm on 275 lb/SYS QC/QA HMA, 3, 70, Intermediate 19.0 mm on 660 lb/SYS QC/QA HMA, 3, 64, Base 19.0 mm (2 Lifts) on 6" Compacted Aggregate No. 53, Base	(W) Widening with HMA, Type C
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	(R) Milling, Asphalt 1.5" (0 - 1.5" Profile Difference) 165 lb/SYS QC/QA HMA 3, 70, Surface 9.5 mm	(15) Combined Concrete Curb & Gutter
		(16) Curb, Concrete (Vertical)
		(26) Sodding, Nursery

RECOMMENDED FOR APPROVAL	DESIGN ENGINEER	DATE
DESIGNED: BLW	DRAWN: EJK	
CHECKED: DCK	CHECKED: DCK	

**INDIANA**  
**DEPARTMENT OF TRANSPORTATION**  
**TYPICAL CROSS SECTIONS**  
**SR 43**

HORIZONTAL SCALE		BRIDGE FILE	
1/4" = 1'-0"		N/A	
VERTICAL SCALE		DESIGNATION	
1/4" = 1'-0"		2001828	
SURVEY BOOK		SHEET	
		4	of 117
CONTRACT		PROJECT	
R-43449			2001828



NOTES:

Tack Coat to be placed between all HMA layers.

Joint Adhesive to be installed at all joints in the surface and intermediate layers.

Liquid Asphalt Sealant to be placed centered on all joints.

LEGEND		
(F) Concrete Sidewalk, 4"	(K1) 165 lb/SYS QC/QA HMA, 3, 70, Surface 9.5 mm on 275 lb/SYS QC/QA HMA, 3, 70, Intermediate 19.0 mm on 660 lb/SYS QC/QA HMA, 3, 64, Base 19.0 mm (2 Lifts) on 6" Compacted Aggregate No. 53, Base	(W) Widening with HMA, Type C
(K) 165 lb/SYS QC/QA HMA, 3, 70, Surface 9.5 mm on 275 lb/SYS QC/QA HMA, 3, 70, Intermediate 19.0 mm on 660 lb/SYS QC/QA HMA, 3, 64, Base 19.0 mm (2 Lifts) on 250 lb/SYS QC/QA HMA, 4, 76, Intermediate OG 19.0 mm on 4" Compacted Aggregate No. 53, Base on Geotextile for Pavement, Type 2A	(O) Compacted Aggregate, No. 53	(L4) Mod. Concrete Rolled Curb (Sloping)
	(R) Milling, Asphalt 1.5" (0 - 1.5" Profile Difference) 165 lb/SYS QC/QA HMA 3, 70, Surface 9.5 mm	(15) Combined Concrete Curb & Gutter
		(16) Curb, Concrete (Vertical)
		(26) Sodding, Nursery

RECOMMENDED FOR APPROVAL	DESIGN ENGINEER	DATE
DESIGNED: BLW	DRAWN: EJK	
CHECKED: DCK	CHECKED: DCK	


INDIANA  
DEPARTMENT OF TRANSPORTATION

TYPICAL CROSS SECTIONS  
SR 43

HORIZONTAL SCALE		BRIDGE FILE	
1/4" = 1'-0"		N/A	
VERTICAL SCALE		DESIGNATION	
1/4" = 1'-0"		2001828	
SURVEY BOOK		SHEET	
		5	of 117
CONTRACT		PROJECT	
R-43449		2001828	


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 PROJECT: 2001828

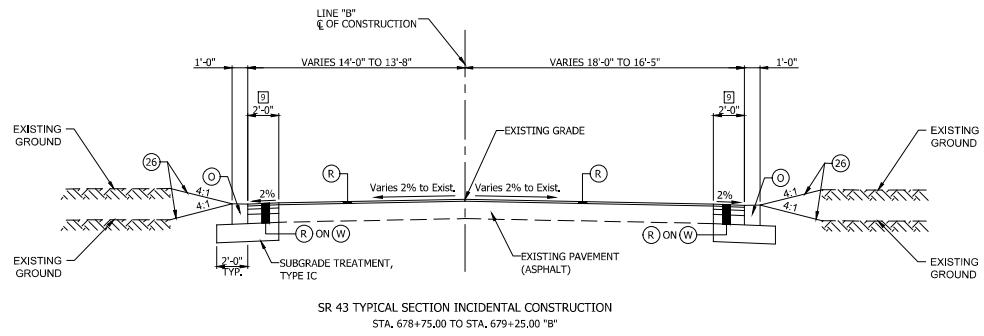

SR 43 TYPICAL SECTION INCIDENTAL CONSTRUCTION  
STA. 678+75.00 TO STA. 679+25.00 "B"

8 WIDENING FROM STA. 678+75.00 TO STA. 679+00.00

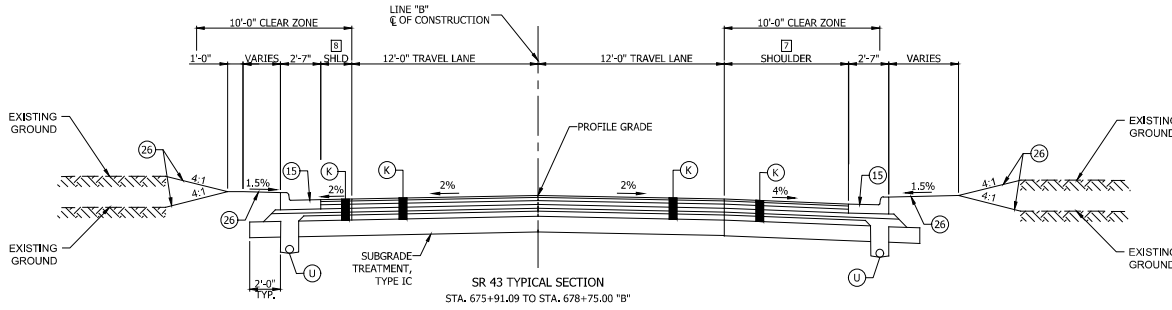

SR 43 TYPICAL SECTION  
STA. 675+91.09 TO STA. 678+75.00 "B"

8 2'-0" FROM STA. 675+91.09 TO STA. 676+67.98  
 VARIES FROM 2'-0" AT STA. 676+67.98 TO  
 0'-0" AT STA. 678+67.72  
 0'-0" FROM STA. 678+67.72 TO STA. 678+75.00  
 7 VARIES FROM 4'-0" AT STA. 675+91.09 TO  
 8'-0" AT STA. 676+34.00  
 8'-0" FROM STA. 676+34.00 TO STA. 678+21.68  
 VARIES FROM 8'-0" AT STA. 678+21.68 TO  
 4'-0" AT STA. 678+64.59  
 4'-0" FROM STA. 678+64.59 TO STA. 678+75.00





**NOTES:**  
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LEGEND		
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		(16) Curb, Concrete (Vertical)
		(26) Sodding, Nursery

RECOMMENDED FOR APPROVAL	DESIGN ENGINEER	DATE
DESIGNED: <u>BLW</u>	DRAWN: <u>EJK</u>	
CHECKED: <u>DCX</u>	CHECKED: <u>DCX</u>	

**INDIANA**  
**DEPARTMENT OF TRANSPORTATION**  
**TYPICAL CROSS SECTIONS**  
**SR 43**

HORIZONTAL SCALE		BRIDGE FILE	
1/4" = 1'-0"			N/A
VERTICAL SCALE		DESIGNATION	
1/4" = 1'-0"			2001828
SURVEY BOOK		SHEET	
		6	of 117
CONTRACT		PROJECT	
R-43449			2001828

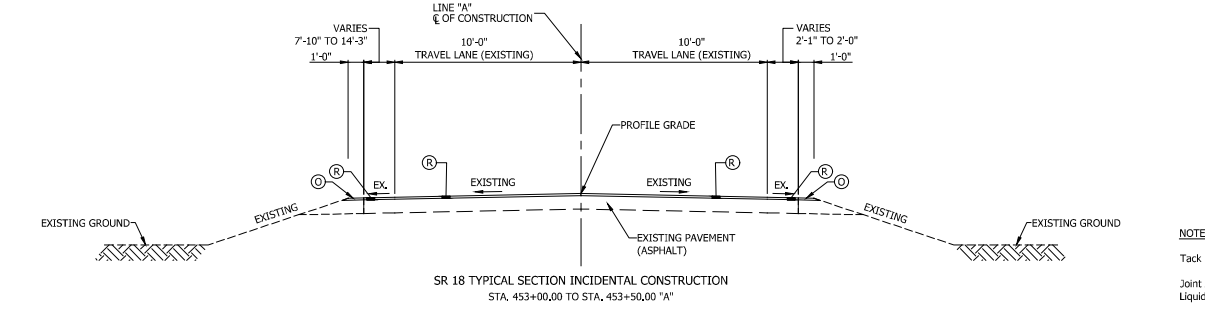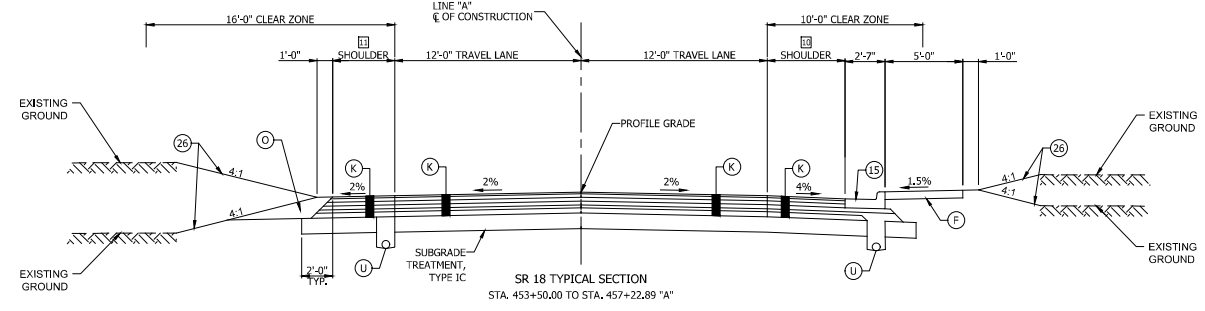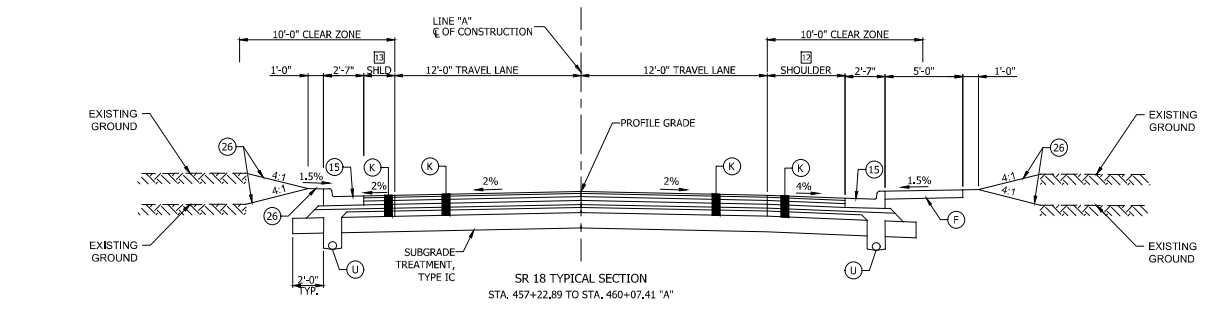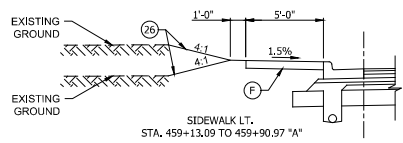

- (I) VARIES FROM 4'-6" AT STA. 457+22.89 TO 2'-0" AT STA. 457+49.76
- 2'-0" FROM STA. 457+49.76 TO STA. 459+26.80
- VARIES FROM 2'-0" AT STA. 459+26.80 TO 8'-2" AT STA. 460+07.41
- (J) 2'-0" FROM STA. 457+22.89 TO STA. 457+95.87
- VARIES FROM 2'-0" AT STA. 457+95.87 TO 5'-0" AT STA. 458+66.12
- 5'-0" FROM STA. 458+66.12 TO STA. 459+32.68
- VARIES FROM 5'-0" AT STA. 459+32.68 TO 114'-7" AT STA. 460+07.41
- (L) 10'-11" FROM STA. 453+50.00 TO STA. 454+01.15
- VARIES FROM 10'-11" AT STA. 454+01.15 TO 4'-0" AT STA. 454+71.96
- 4'-0" FROM STA. 454+71.96 TO STA. 456+33.47
- VARIES FROM 4'-0" AT STA. 456+33.47 TO 4'-6" AT STA. 457+22.89
- (M) 0'-0" FROM STA. 453+50.00 TO STA. 454+01.54
- VARIES FROM 0'-0" AT STA. 454+01.54 TO 5'-0" AT STA. 454+13.41
- 5'-0" FROM STA. 454+13.41 TO STA. 455+80.00
- VARIES FROM 5'-0" AT STA. 455+80.00 TO 2'-0" AT STA. 456+46.18
- 2'-0" FROM STA. 456+46.18 TO STA. 457+22.89

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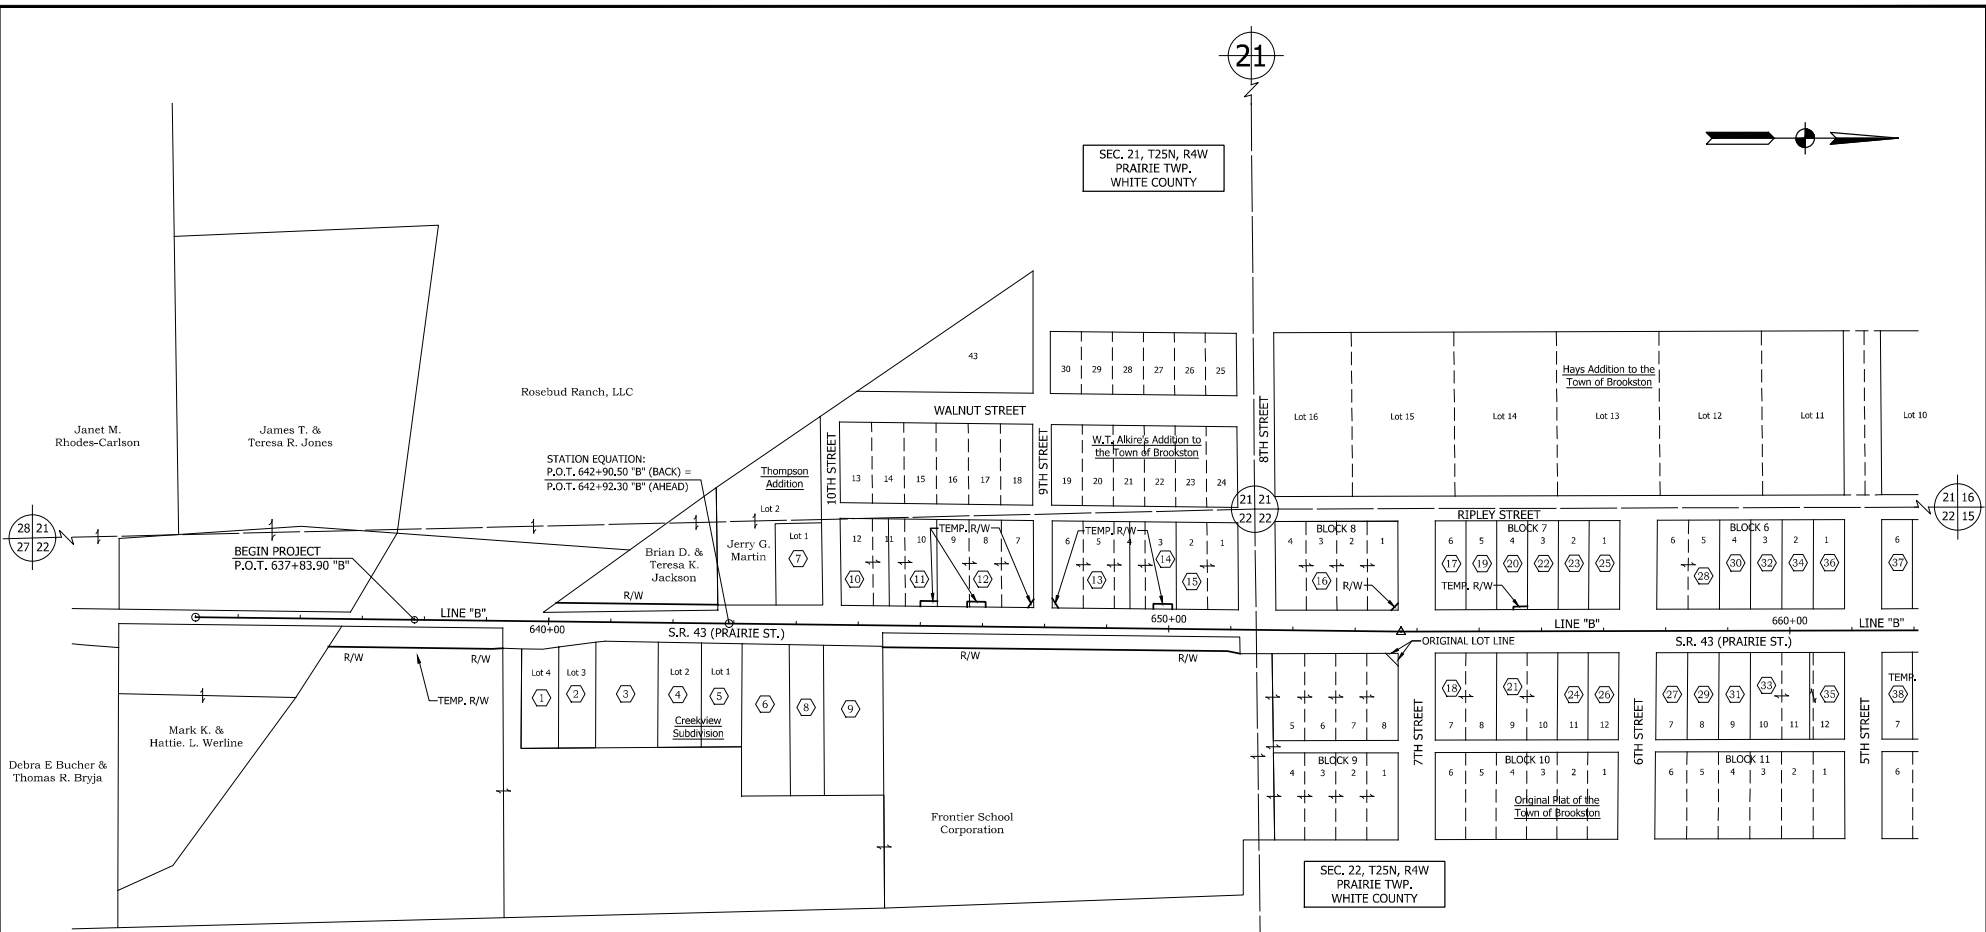
**INDIANA DEPARTMENT OF TRANSPORTATION**

**TYPICAL CROSS SECTIONS SR 18**

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SURVEY BOOK	SHEET
	7 of 117
CONTRACT	PROJECT
R-43449	2001828

PRINT DATE: 4/9/23  
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SEC. 21, T25N, R4W  
 PRAIRIE TWP,  
 WHITE COUNTY

SEC. 22, T25N, R4W  
 PRAIRIE TWP,  
 WHITE COUNTY


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1	Edward & Stacy Jacobs	8	Harry L. Bartlett	15	Clarence Lee & Denise Ann Lopp	23	James L. & Deborah S. Longfellow	31	Jacob A. & Evelyn Sue Rhoda
2	Raelene L. Wing	9	Steven Morgan Jr.	16	Clarence L. & Denise A. Lopp	24	Brilee Meacham	32	Matthew Lee Neal
3	Terrence D. & Sherry L. Banas	10	Jerry E. & Leona A. Amick	17	Mandi Altman	25	Cody W. Stinnett	33	Mark Pattenglae, Jr. & Marissa B. Alwine
4	Steven Stein	11	Allyson Dawn Franklin	18	Administrator Assistance, LLC	26	Bruce & Nancy A. Harmon	34	Christopher Sallee & Gwynne Oliver
5	Casey W. Allen	12	Laurel A. Eakin	19	Gladys A. Van Voorst	27	Trent L. Judy	35	Maichael A. & Diannah D. Rodgers
6	Ryan M. & Mandy L. Altman	13	Judith M. Jr. & Jewell D. Dees	20	Lawrence A. & Jane E. Horstman	28	Colby & Jaime Reel	36	Raelene L. Wing
7	Jeffrey L. McKay	14	Bradly J. Reid	21	Connor J. Schuster	29	Jeremy A. & Heather M. Miller	37	Robert J. Vaughn
				22	Bette Bilyeu	30	Jerry Joe Donnoe, III	38	Selena A. Masterson

<b>INDIANA DEPARTMENT OF TRANSPORTATION</b>  <b>PLAT NO. 1</b>	RECOMMENDED FOR APPROVAL _____ DATE _____ DESIGN ENGINEER	HORIZONTAL SCALE 1" = 100' BRIDGE FILE N/A
	DESIGNED: <u>BLW</u> DRAWN: <u>BEW</u>	VERTICAL SCALE N/A DESIGNATION 2001828
	CHECKED: <u>DCX</u> CHECKED: <u>DCX</u>	SURVEY BOOK _____ SHEET _____ 8 of 117
	CONTRACT R-43449	PROJECT 2001828



INDEX NO.	OWNER
35	Maichael A. & Diannah D. Rodgers
36	Raelene L. Wing
37	Robert J. Vaughn
38	Selena A. Masterson
39	Amber Ann Richter
40	Alexandra L. Grimes
41	Shannon N. Cooley
42	Shawn M. & Nelann Kaluf
44	Marc T. & Brenda L. Clapper
45	Sara J. Hook
46	Edward Gramp & Brooke Lee Melton
47	The Fountain Trust Company
48	Casey's Marketing Company
49	David C. Alm & Eileen L. Laskowski
50	Ralph E. & Susan A. Frost
51	Brian & Teresa Jackson
52	3Rd St, LLC

INDEX NO.	OWNER
53	David C. Alm & Eileen L. Laskowski
54	David W. & Donna K. Keller
55	Family Express Corporation
56	Mark L. Sterne & Kimberly K. Robinson
57	Steven L. & Sandra L. Kenyon
58	Psi Iota Xi Sorority
59	Joyce E. McReynolds
60	Brookston Public Library
61	Lelan D. McReynolds
62	Mary Beth Zill
63	Arc Fedbkain001 LLC
64	Cindy R. May & Brianna Cortez
65	Town of Brookston
66	Shri Hari, LLC
67	Larry E. & Patricia D. Bruinsma
68	Peter Rosi
69	Travis G. & Angela D. Stevens
70	Ronald R. & Regina J. Berryman

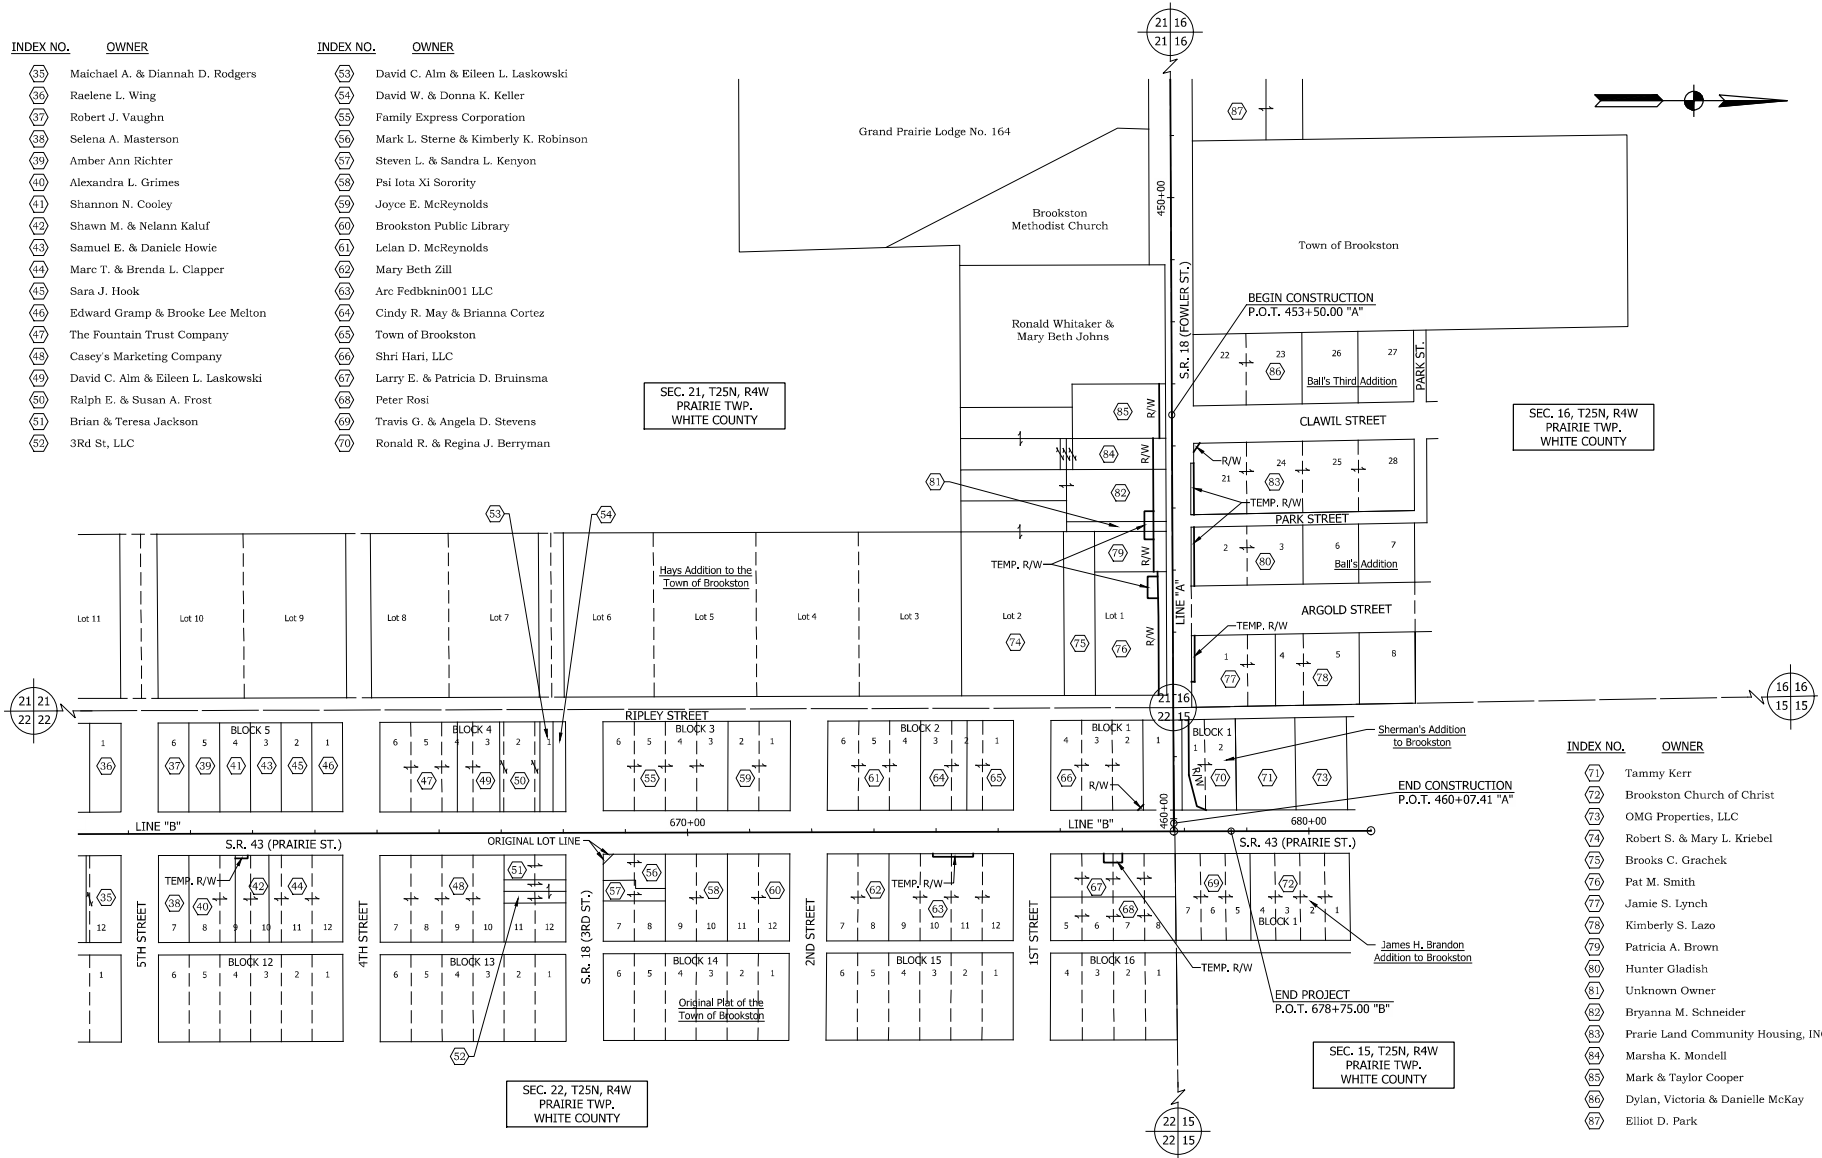


INDEX NO.	OWNER
71	Tammy Kerr
72	Brookston Church of Christ
73	OMG Properties, LLC
74	Robert S. & Mary L. Kriebel
75	Brooks C. Grachek
76	Pat M. Smith
77	Jamie S. Lynch
78	Kimberly S. Lazo
79	Patricia A. Brown
80	Hunter Gladish
81	Unknown Owner
82	Bryanna M. Schneider
83	Prairie Land Community Housing, INC
84	Marsha K. Mondell
85	Mark & Taylor Cooper
86	Dylan, Victoria & Danielle McKay
87	Elliot D. Park

PRINT DATE: 4/8/23  
 PLOT SCALE: 1:1  
 EDIT DATE: 2/14/23 - 11:39 AM  
 EDITED BY: JAVILSON  
 DRAWING FILE: I:\14080-01 - WHITE CO. PAVEMENT REPLACEMENT 20001828\14080-01\14080-01.dwg  
 L:\INDUSTRIAL\14080-01.dwg

	RECOMMENDED FOR APPROVAL _____ DESIGN ENGINEER DATE _____	<b>INDIANA DEPARTMENT OF TRANSPORTATION</b>  <b>PLAT NO. 1</b>	<table border="1" style="width: 100%; border-collapse: collapse;"> <tr> <td>HORIZONTAL SCALE</td> <td>BRIDGE FILE</td> </tr> <tr> <td>1" = 100'</td> <td>N/A</td> </tr> <tr> <td>VERTICAL SCALE</td> <td>DESIGNATION</td> </tr> <tr> <td>N/A</td> <td>2001828</td> </tr> <tr> <td>SURVEY BOOK</td> <td>SHEET</td> </tr> <tr> <td></td> <td>9 of 117</td> </tr> <tr> <td>CONTRACT</td> <td>PROJECT</td> </tr> <tr> <td>R-43449</td> <td>2001828</td> </tr> </table>	HORIZONTAL SCALE	BRIDGE FILE	1" = 100'	N/A	VERTICAL SCALE	DESIGNATION	N/A	2001828	SURVEY BOOK	SHEET		9 of 117	CONTRACT	PROJECT	R-43449	2001828
HORIZONTAL SCALE	BRIDGE FILE																		
1" = 100'	N/A																		
VERTICAL SCALE	DESIGNATION																		
N/A	2001828																		
SURVEY BOOK	SHEET																		
	9 of 117																		
CONTRACT	PROJECT																		
R-43449	2001828																		

PRINT DATE: 4/9/23 11:52:23 AM EDITED BY: DORAWA Drawing File: F:\2000-2024\PROJECTS\CONSTRUCTION\2001828\2001828-12\2001828-12.dwg  
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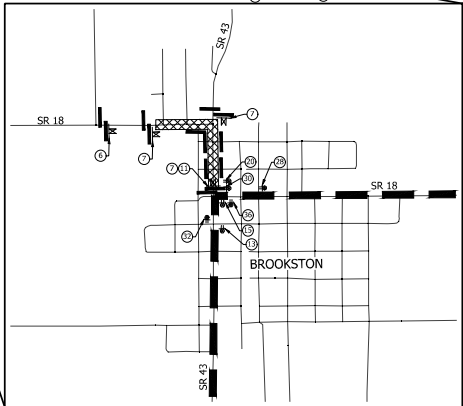
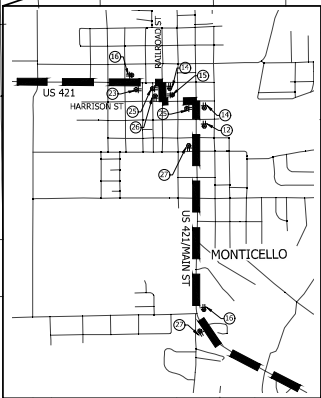
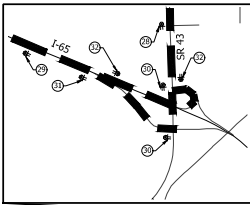
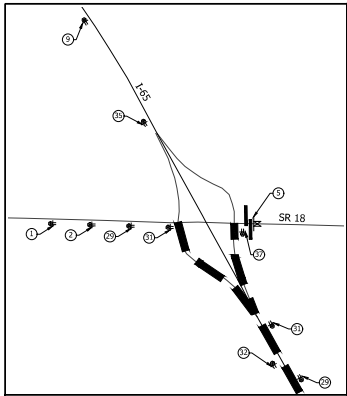
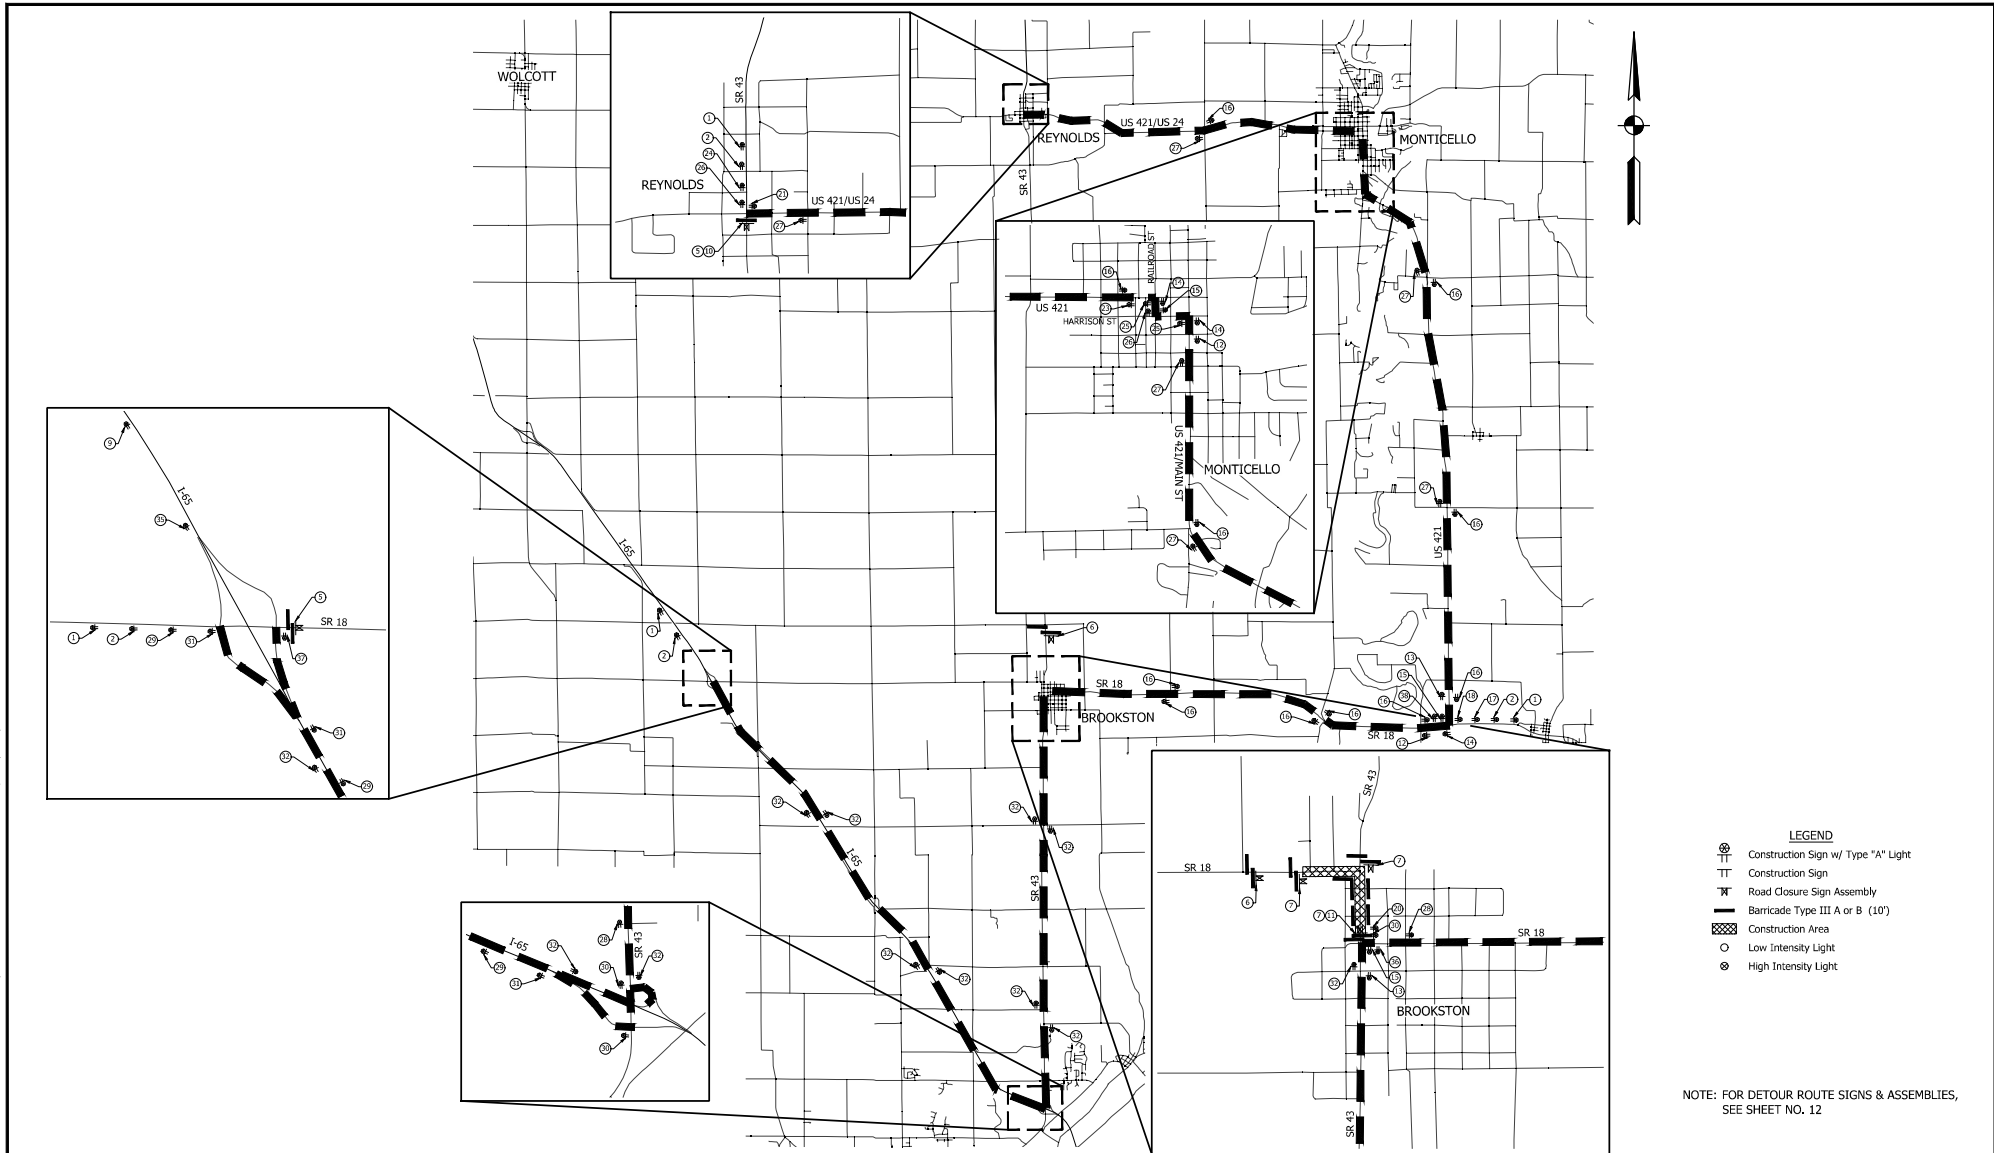


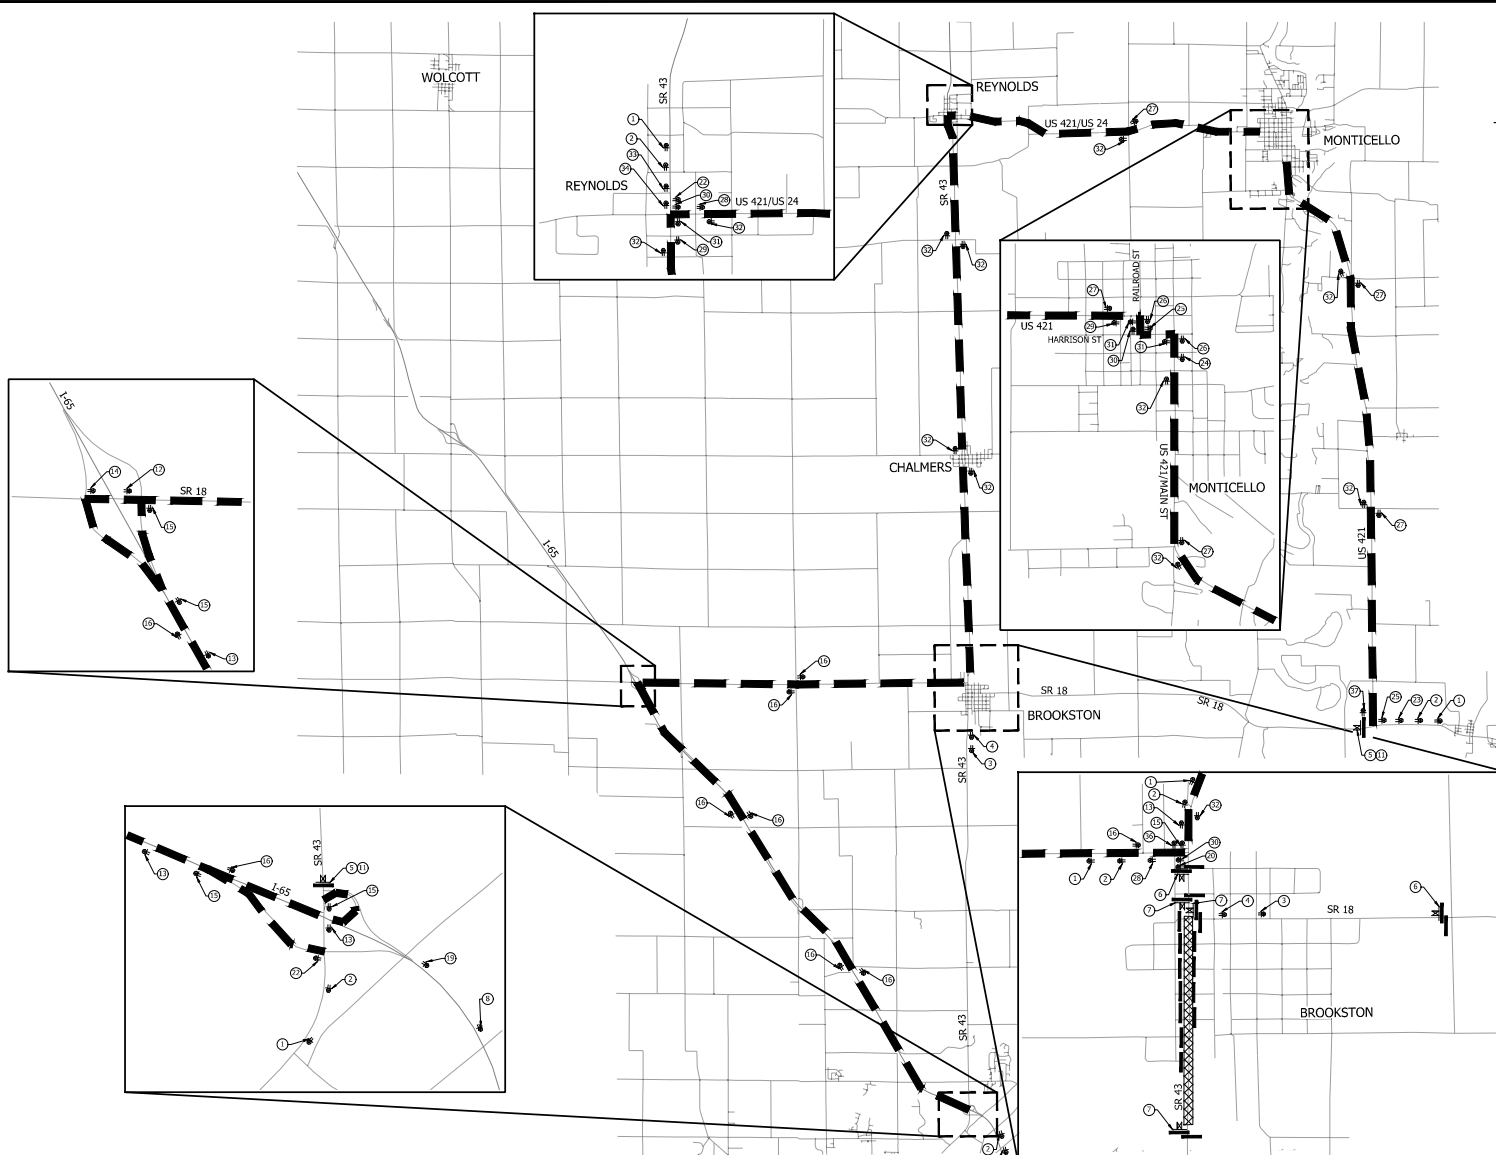- LEGEND**
- ⊙ Construction Sign w/ Type "A" Light
  - TT Construction Sign
  - TT Road Closure Sign Assembly
  - Barricade Type III A or B (10')
  - ▨ Construction Area
  - Low Intensity Light
  - ⊙ High Intensity Light

NOTE: FOR DETOUR ROUTE SIGNS & ASSEMBLIES, SEE SHEET NO. 12

	RECOMMENDED FOR APPROVAL _____ DESIGN ENGINEER DATE _____	<b>INDIANA DEPARTMENT OF TRANSPORTATION</b>	HORIZONTAL SCALE NONE VERTICAL SCALE N/A	BRIDGE FILE N/A DESIGNATION 2001828
DESIGNED: <u>BLW</u> DRAWN: <u>BEW</u> CHECKED: <u>DCK</u> CHECKED: <u>DCK</u>	<b>DETOUR ROUTE PHASE I</b>		SURVEY BOOK _____ SHEET _____ 10 of 117	CONTRACT PROJECT R-43449 2001828



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 PLOT SCALE: 1" = 1000'  
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 DESIGNED BY: BILW  
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 CHECKED BY: DCK  
 DATE: 02/02/23 2:08 PM  
 DRAWN BY: BEW



- LEGEND**
- ⊗ Construction Sign w/ Type "A" Light
  - TT Construction Sign
  - TT Road Closure Sign Assembly
  - Barricade Type III A or B (10')
  - ▨ Construction Area
  - Low Intensity Light
  - ⊙ High Intensity Light



NOTE: FOR DETOUR ROUTE SIGNS & ASSEMBLIES, SEE SHEET NO. 12

	RECOMMENDED FOR APPROVAL _____ DESIGN ENGINEER DATE _____	<b>INDIANA DEPARTMENT OF TRANSPORTATION</b>	HORIZONTAL SCALE N/A	BRIDGE FILE N/A
			VERTICAL SCALE N/A	DESIGNATION 2001828
	DESIGNED: <u>BILW</u> DRAWN: <u>BEW</u>		SURVEY BOOK	SHEET 11 of 117
	CHECKED: <u>DCK</u> CHECKED: <u>DCK</u>	<b>DETOUR ROUTE PHASE II</b>	CONTRACT R-43449	PROJECT 2001828

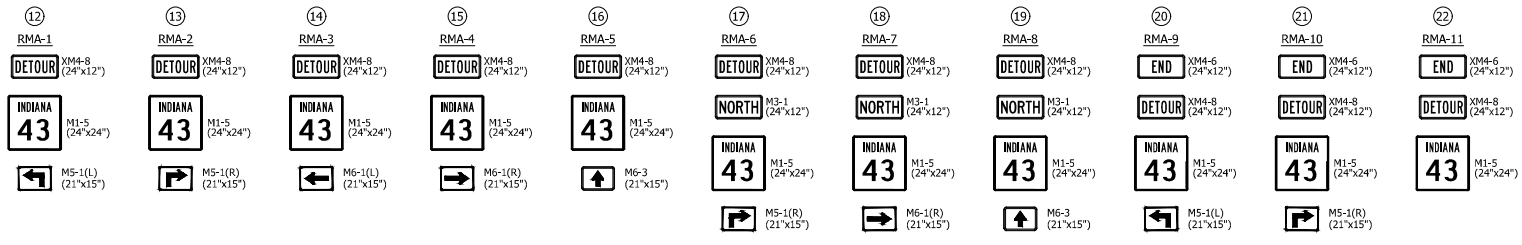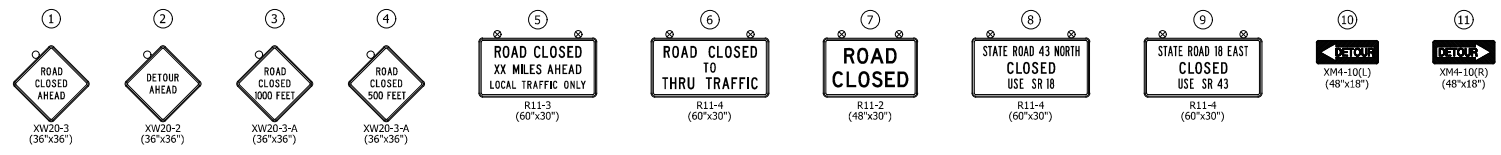

**MAINTENANCE OF TRAFFIC QUANTITIES**

	Vehicular Phase I	Vehicular Phase II	Pedestrian E. Parallel Only	Pedestrian W. Parallel Only	Pedestrian E. Parallel & Perpendicular	Pedestrian W. Parallel & Perpendicular	Quantity	Unit
Road Closure Sign Assembly	8	8					8	EACH
Detour Route Marker Assembly	61	64					125	EACH
Construction Sign, Type A	16	8					16	EACH
Construction Sign, Type B			6	6	16	16	16	EACH
Type III-B Barricade (6')			12	12	36	36	36	LFT
Type III-B Barricade (10')	230	180					230	LFT

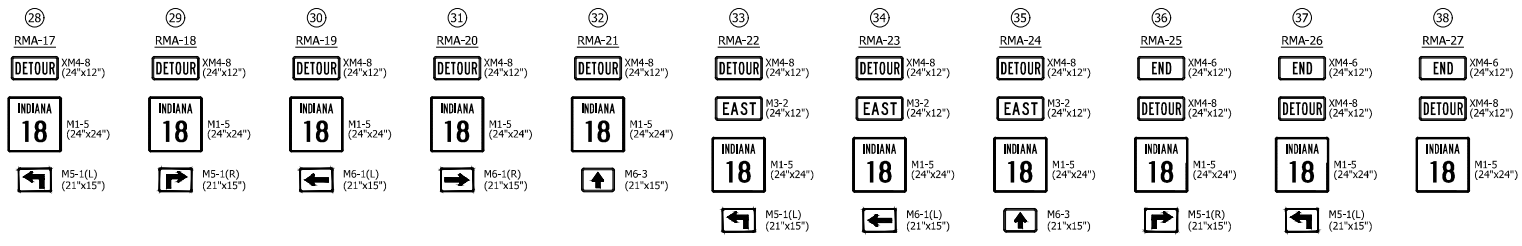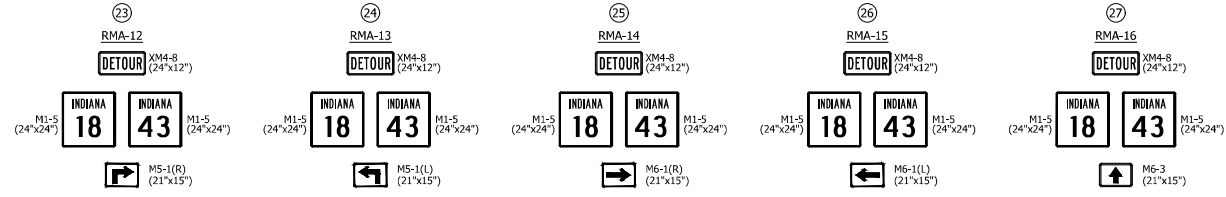


PRINT DATE: 9/23  
 PLOT SCALE: 1:1  
 DATE: 2/23/23 - 11:53 AM  
 EDITOR: B. DOWNUM  
 DRAWING FILE: I:\2001828\INDIANA\DESIGN\DRAWING\INDIANA\2001828\INDIANA\2001828.DWG

RECOMMENDED FOR APPROVAL _____ DATE _____ DESIGNED: <u>BLW</u> DRAWN: <u>BEW</u> CHECKED: <u>DCK</u> CHECKED: <u>DCK</u>	<b>INDIANA DEPARTMENT OF TRANSPORTATION</b>  <b>DETOUR ROUTE SIGNS &amp; ASSEMBLIES</b>	HORIZONTAL SCALE NONE VERTICAL SCALE N/A	BRIDGE FILE N/A DESIGNATION 2001828
		SURVEY BOOK _____	SHEET _____ of _____ PROJECT _____ CONTRACT R-43449 2001828





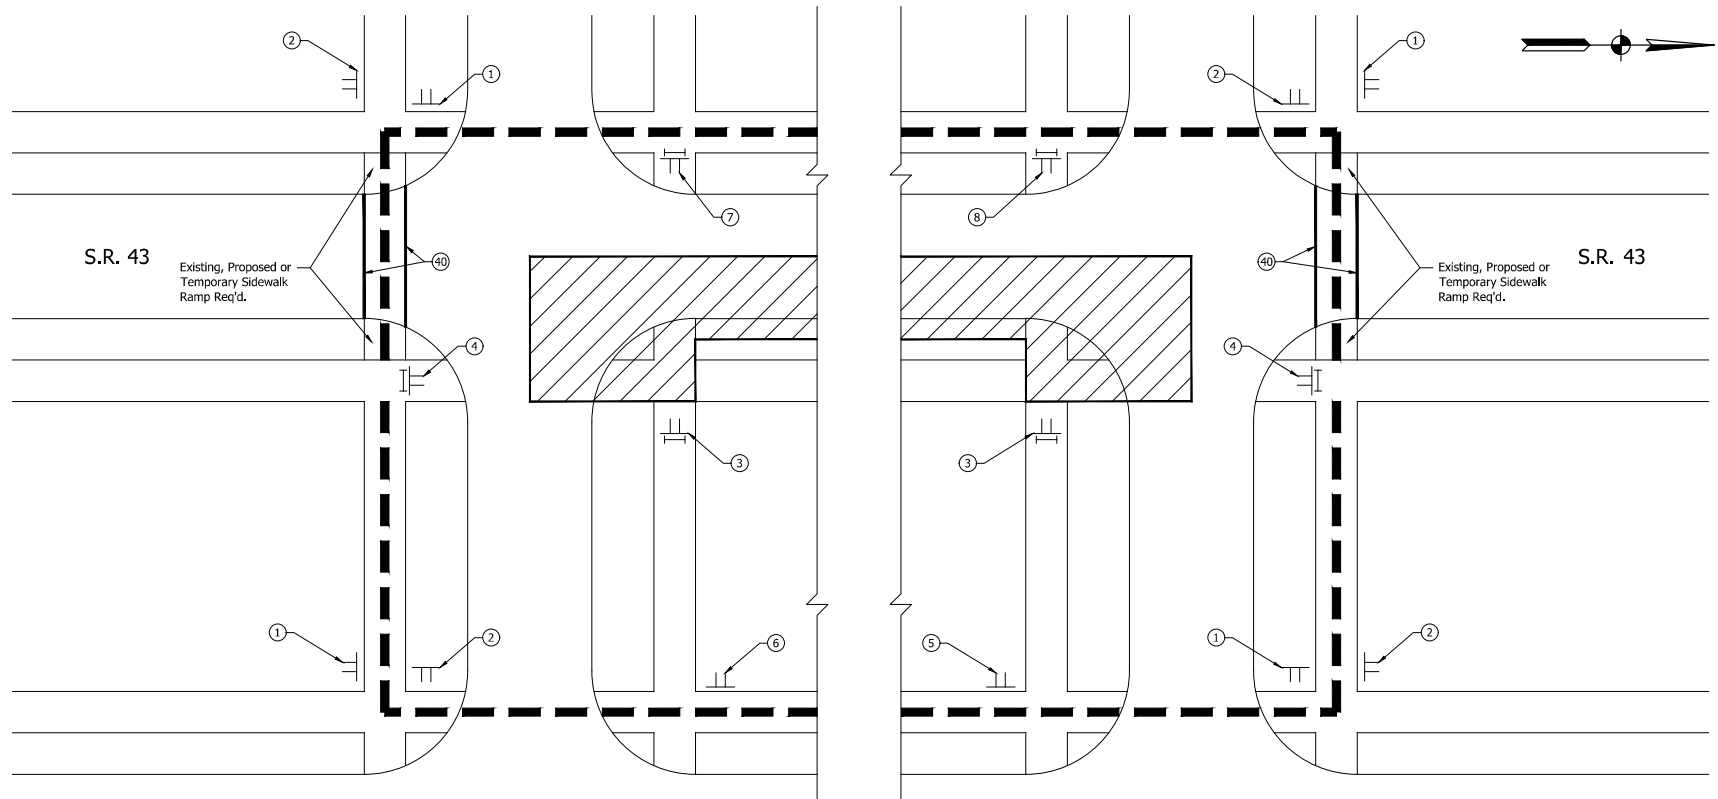

EAST SIDE CONSTRUCTION WITH PARALLEL & PERPENDICULAR SIDEWALKS



M4-9b (R)  
30" x 24"

1



M4-9b (L)  
30" x 24"

2



R9-9  
24" x 12"

3




R9-10  
24" x 12"

4



R9-11 (R)  
24" x 12"

5

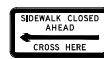

R9-11 (L)  
24" x 12"

6



R9-11a (R)  
24" x 12"

7



R9-11a (L)  
24" x 12"

8

- LEGEND**
- AREA OF CONSTRUCTION
  - TEMPORARY CURB RAMP
  - PEDESTRIAN DETOUR ROUTE
  - TYPE III-B BARRICADE (6')
  - CONSTRUCTION SIGN
  - TEMPORARY PAVEMENT MARKING, REMOVABLE 6" (WHITE)



- NOTES:**
1. ONLY ONE RAMP PER BLOCK SHALL BE CLOSED AT ANY GIVEN TIME.
  2. THIS TYPICAL APPLIES TO THE ENTIRE CORRIDOR WHERE APPLICABLE.

PRINT DATE: 4/9/23  
PLOT SCALE: 1" = 40'-0" DATE: 8/22/23 10:55 AM DESIGNED BY: RWL/SLW DRAWING FILE: P:\2018\2018-11-MAINTENANCE IMPROVEMENTS\DRAWINGS\TYPICAL\TYPICAL\_PED\_PDETOUR.AWG


		RECOMMENDED FOR APPROVAL _____ DESIGN ENGINEER DATE	<b>INDIANA DEPARTMENT OF TRANSPORTATION</b>  <b>MAINTENANCE OF TRAFFIC TYPICAL PEDESTRIAN DETOUR</b>	HORIZONTAL SCALE: NONE BRIDGE FILE: N/A
		DESIGNED: <u>BLW</u> DRAWN: <u>BEW</u> CHECKED: <u>DCX</u> CHECKED: <u>DCX</u>		VERTICAL SCALE: N/A DESIGNATION: 2001828
				SURVEY BOOK: _____ SHEET: _____ 15 of 117
				CONTRACT: R-43449 PROJECT: 2001828





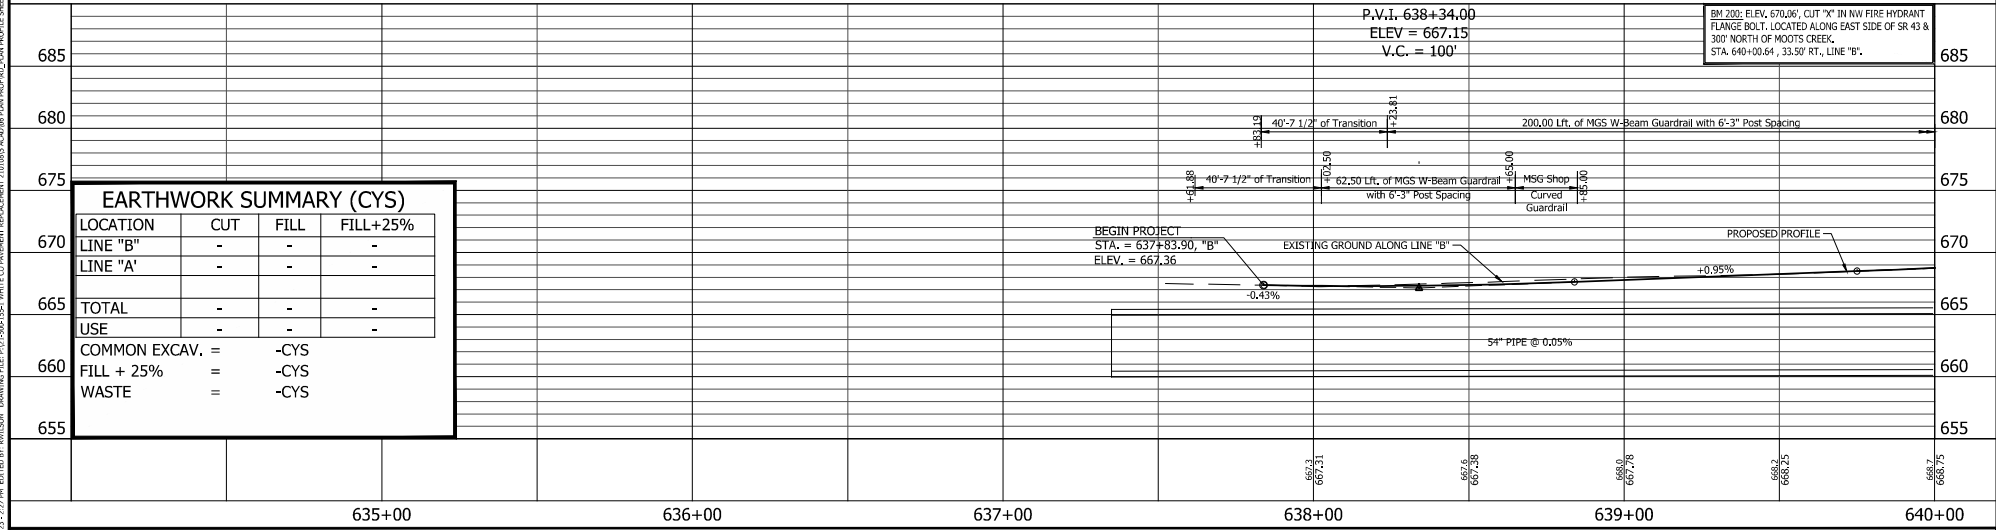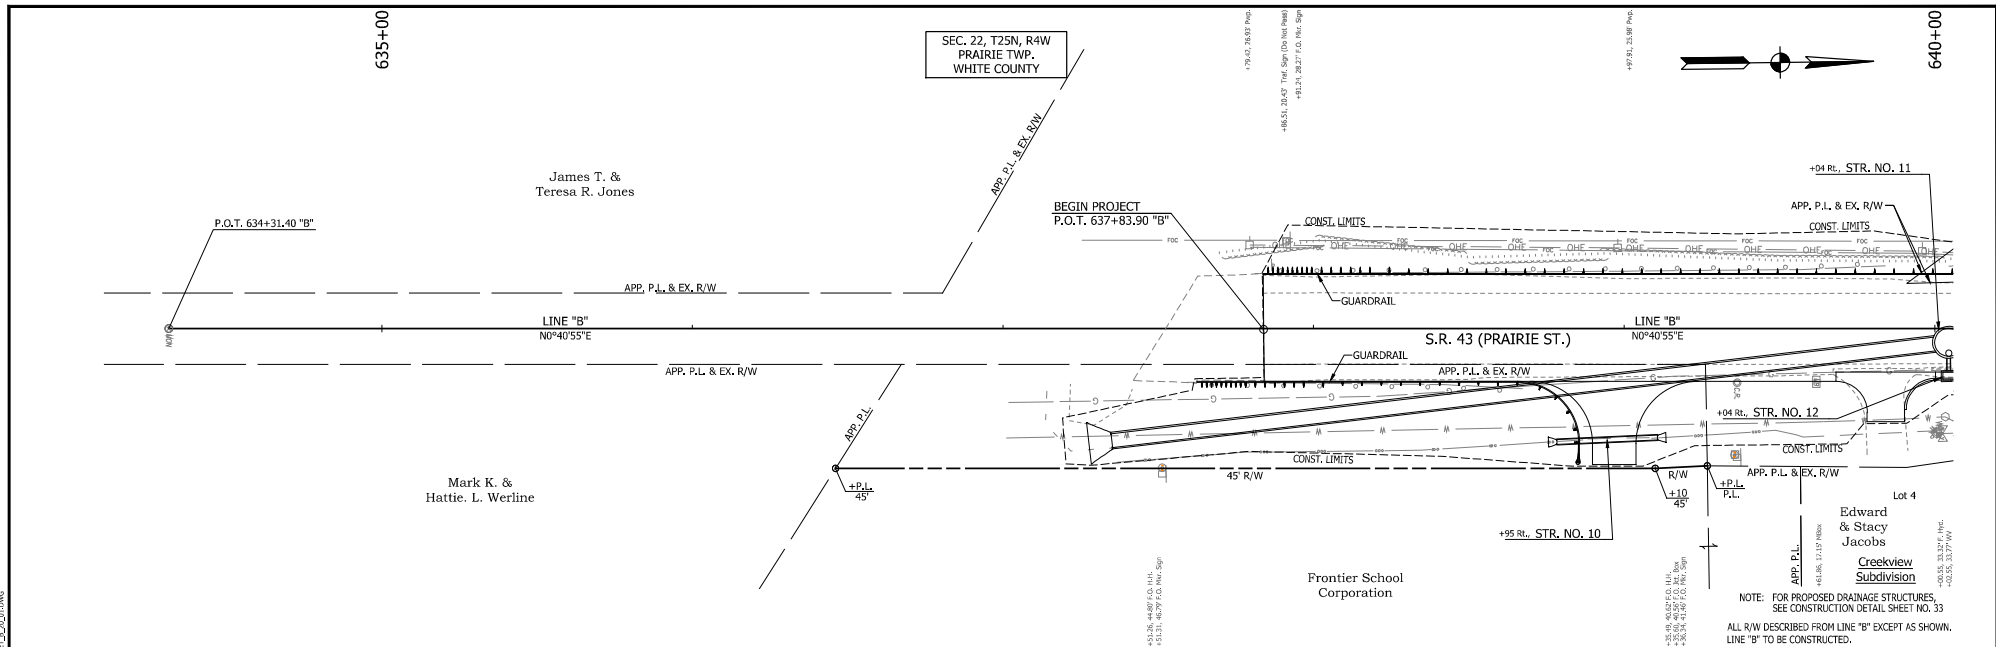

EARTHWORK SUMMARY (CYS)			
LOCATION	CUT	FILL	FILL+25%
LINE "B"	-	-	-
LINE "A"	-	-	-
TOTAL	-	-	-
USE	-	-	-
COMMON EXCAV.	=	-CYS	
FILL + 25%	=	-CYS	
WASTE	=	-CYS	

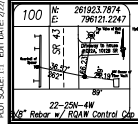


DESIGNED: <u>BLW</u>	DRAWN: <u>BEW</u>
CHECKED: <u>DCK</u>	CHECKED: <u>DCK</u>


RECOMMENDED FOR APPROVAL	DESIGN ENGINEER	DATE
INDIANA DEPARTMENT OF TRANSPORTATION PLAN AND PROFILE STA. 634+31.40 TO 640+00.00 LINE "B"		

HORIZONTAL SCALE	BRIDGE FILE
1" = 20'	N/A
VERTICAL SCALE	DESIGNATION
1" = 5'	2001828
SURVEY BOOK	SHEET
	17 of 117
CONTRACT	PROJECT
R-43449	2001828

PRINT DATE: 9/23/23 2:27 PM; DRAWING FILE: P:\2001828\WHITE CO\INVENTORY\REPLACEMENT\ST01828\42001828\PLAN\PROFILES\PLAN\_PROFILE\_SHEET\_01.DWG  
 22-25N-4W  
 80' Right of Way Control Cap

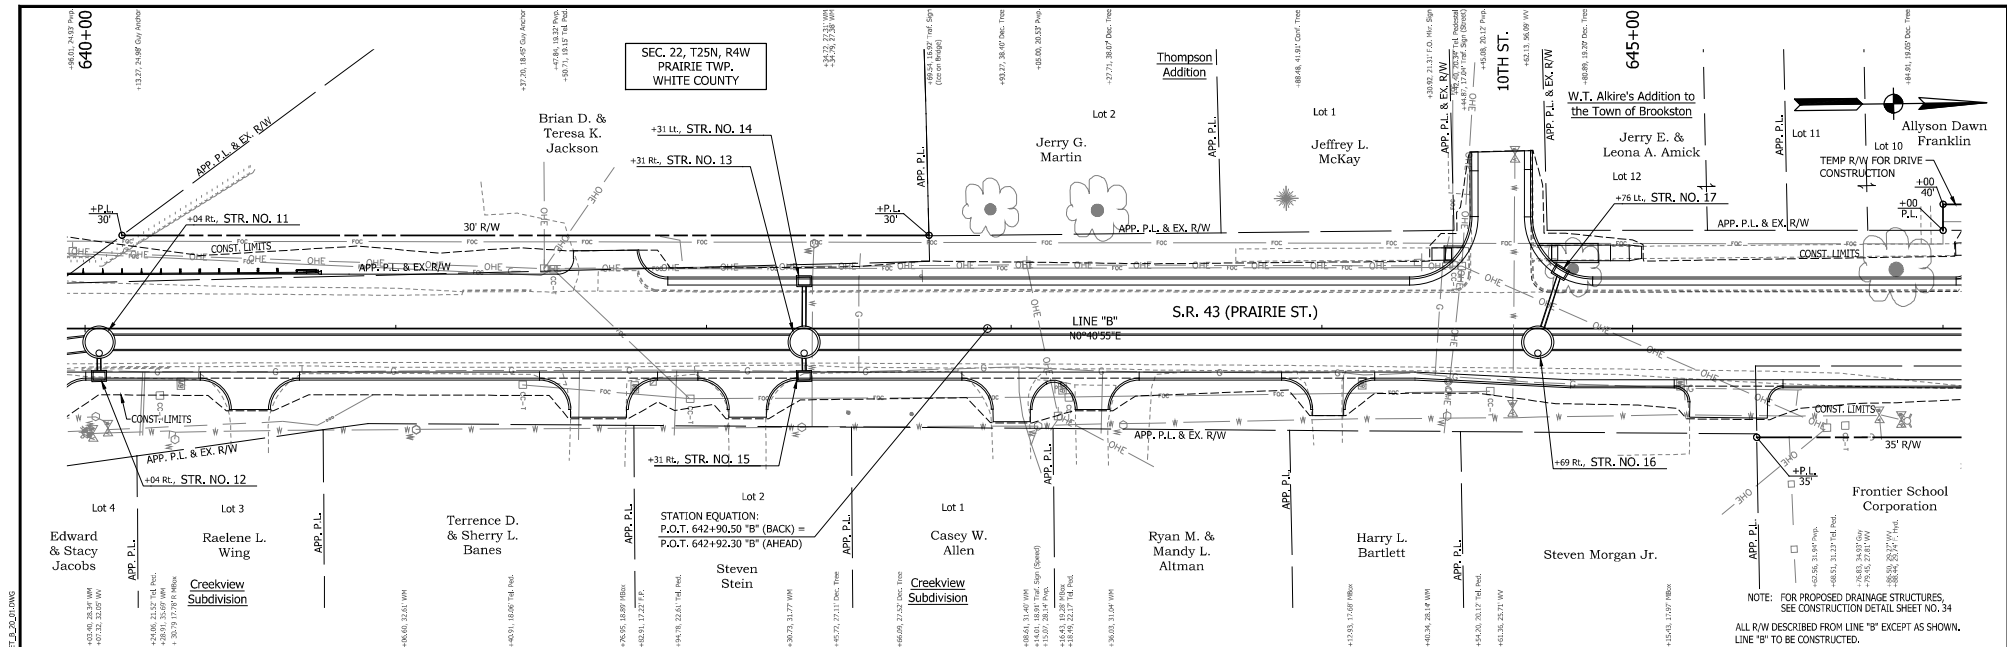

NOTE: FOR PROPOSED DRAINAGE STRUCTURES, SEE CONSTRUCTION DETAIL SHEET NO. 34  
ALL R/W DESCRIBED FROM LINE "B" EXCEPT AS SHOWN. LINE "B" TO BE CONSTRUCTED.

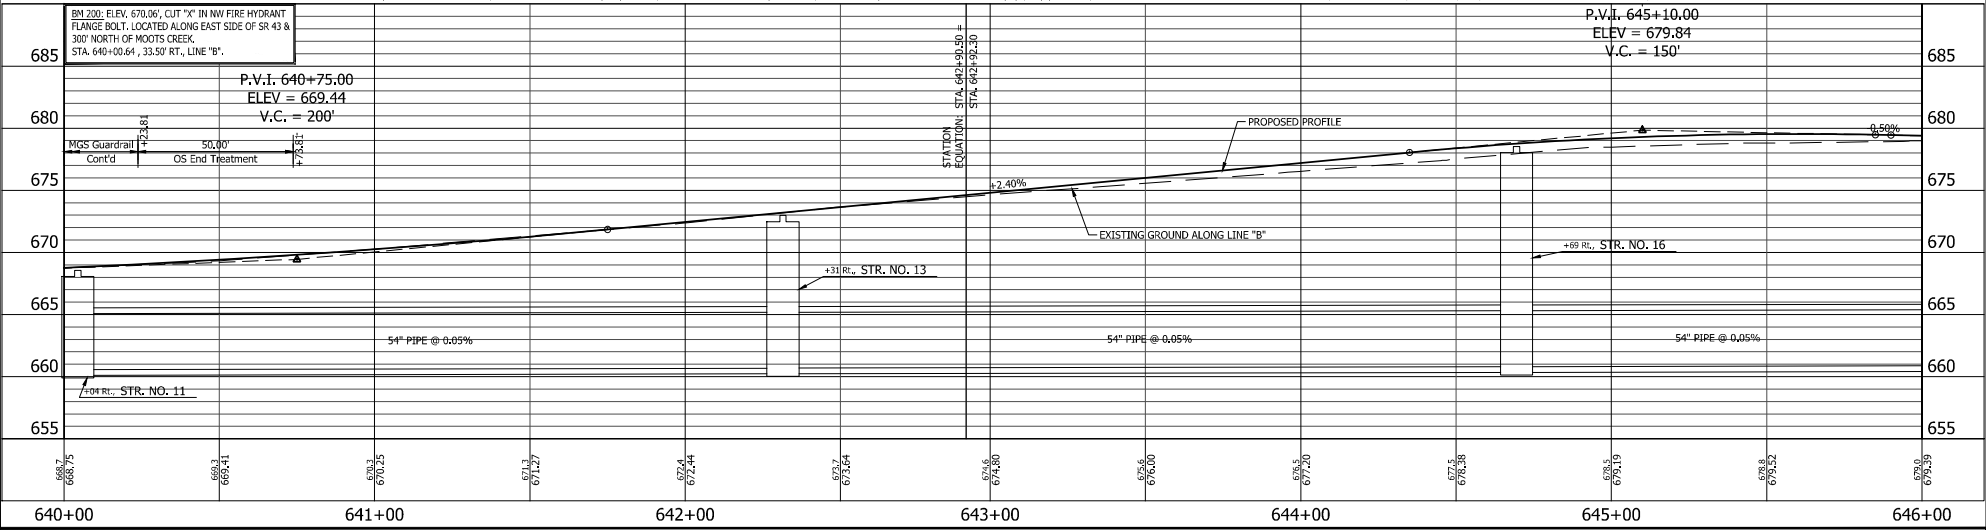



101	202426.2089	796126.7475
22-254-4W	Rebar w/ ROW Control Cap	

RECOMMENDED FOR APPROVAL	DESIGN ENGINEER	DATE
DESIGNED: <u>BLW</u>	DRAWN: <u>BEW</u>	
CHECKED: <u>DCK</u>	CHECKED: <u>DCK</u>	




INDIANA DEPARTMENT OF TRANSPORTATION  
PLAN AND PROFILE  
STA. 640+00.00 TO 646+00.00 LINE "B"

HORIZONTAL SCALE	BRIDGE FILE
1" = 20'	N/A
VERTICAL SCALE	DESIGNATION
1" = 5'	2001828
SURVEY BOOK	SHEET
	18 of 117
CONTRACT	PROJECT
R-43449	2001828

PRINT DATE: 9/23/23 2:27 PM; DRAWING FILE: P:\2024\2001828\WHITE CO\PROJECT\REPLACEMENT\T01828\43449\PLAN\PROFILES\PLAN\_PROFILE\_SHEET\_101.DWG

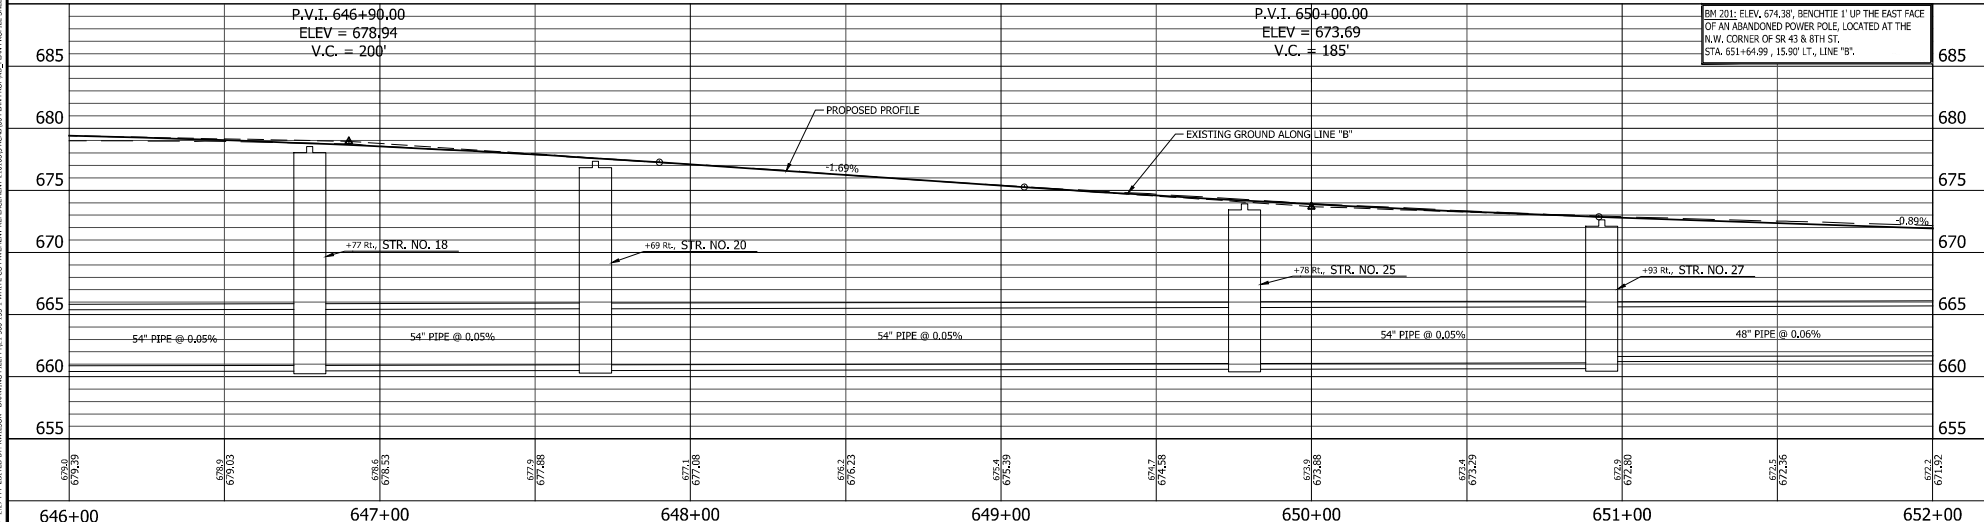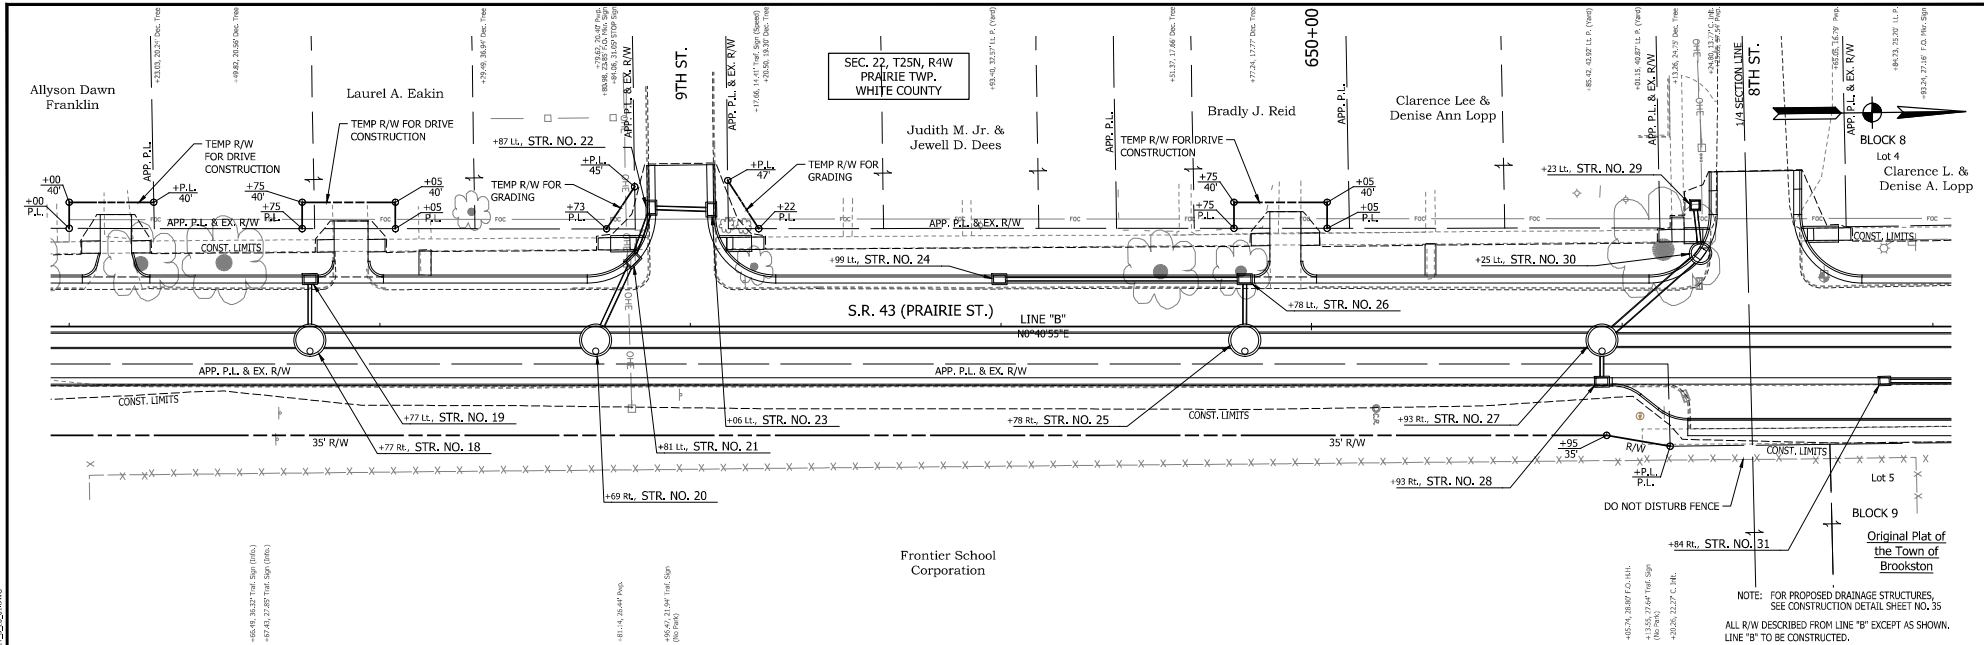

	102 26,300x2187 796143.0880	RECOMMENDED FOR APPROVAL _____ DESIGN ENGINEER _____ DATE _____		INDIANA DEPARTMENT OF TRANSPORTATION PLAN AND PROFILE STA. 646+00.00 TO 652+00.00 LINE "B"		HORIZONTAL SCALE 1" = 20'	BRIDGE FILE N/A
	22-25H-4W 22-25H-4W 22-25H-4W	DESIGNED: <u>BLW</u> DRAWN: <u>BEW</u>	VERTICAL SCALE 1" = 5'			DESIGNATION 2001828	
	CHECKED: <u>DCK</u> CHECKED: <u>DCK</u>	SURVEY BOOK _____ SHEET _____ of _____		PROJECT 2001828			
	22-25H-4W 22-25H-4W 22-25H-4W	CONTRACT R-43449		PROJECT 2001828			

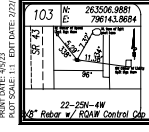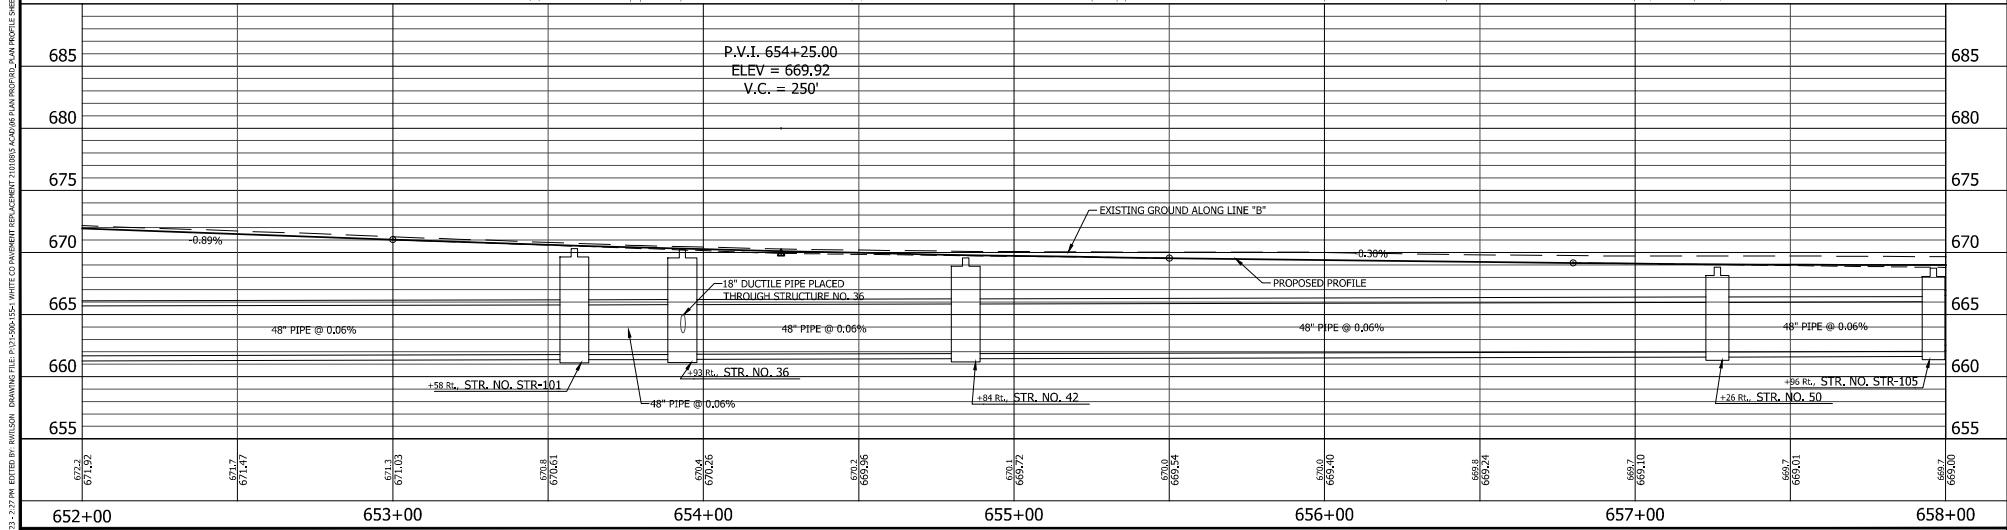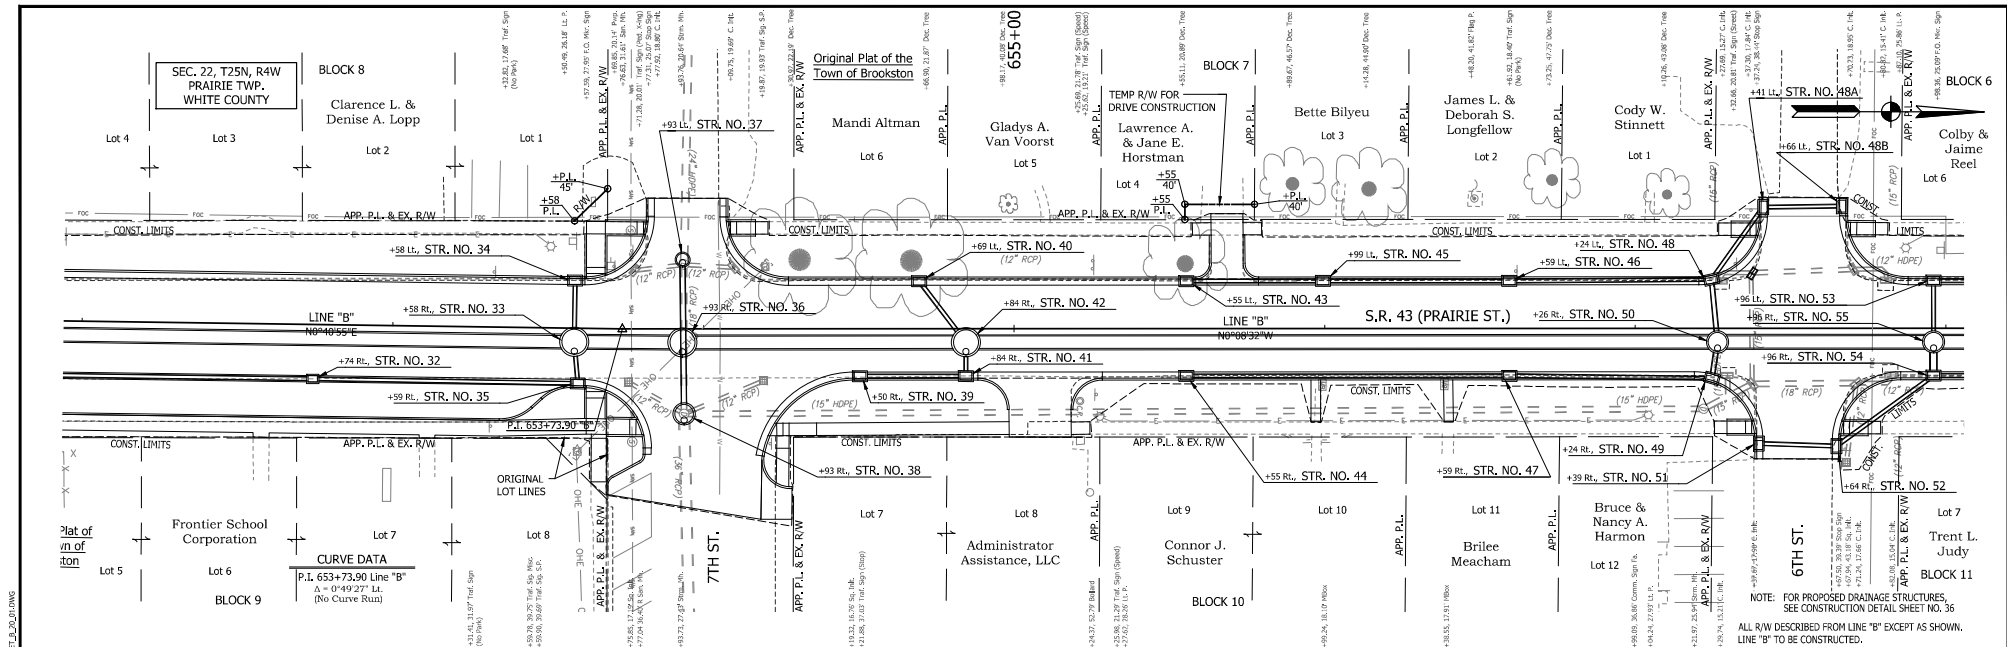



103	263506.9881
IN	796743.9684
EP	132324.0000
22-25H-4W	
Reber w/ ROW Control Cap	

RECOMMENDED FOR APPROVAL	DESIGN ENGINEER	DATE
DESIGNED: <u>BLW</u>	DRAWN: <u>BEW</u>	
CHECKED: <u>DCK</u>	CHECKED: <u>DCK</u>	

INDIANA  
DEPARTMENT OF TRANSPORTATION

PLAN AND PROFILE  
STA. 652+00.00 TO 658+00.00 LINE "B"

HORIZONTAL SCALE	BRIDGE FILE
1" = 20'	N/A
VERTICAL SCALE	DESIGNATION
1" = 5'	2001828
SURVEY BOOK	SHEET
	20 of 117
CONTRACT	PROJECT
R-43449	2001828

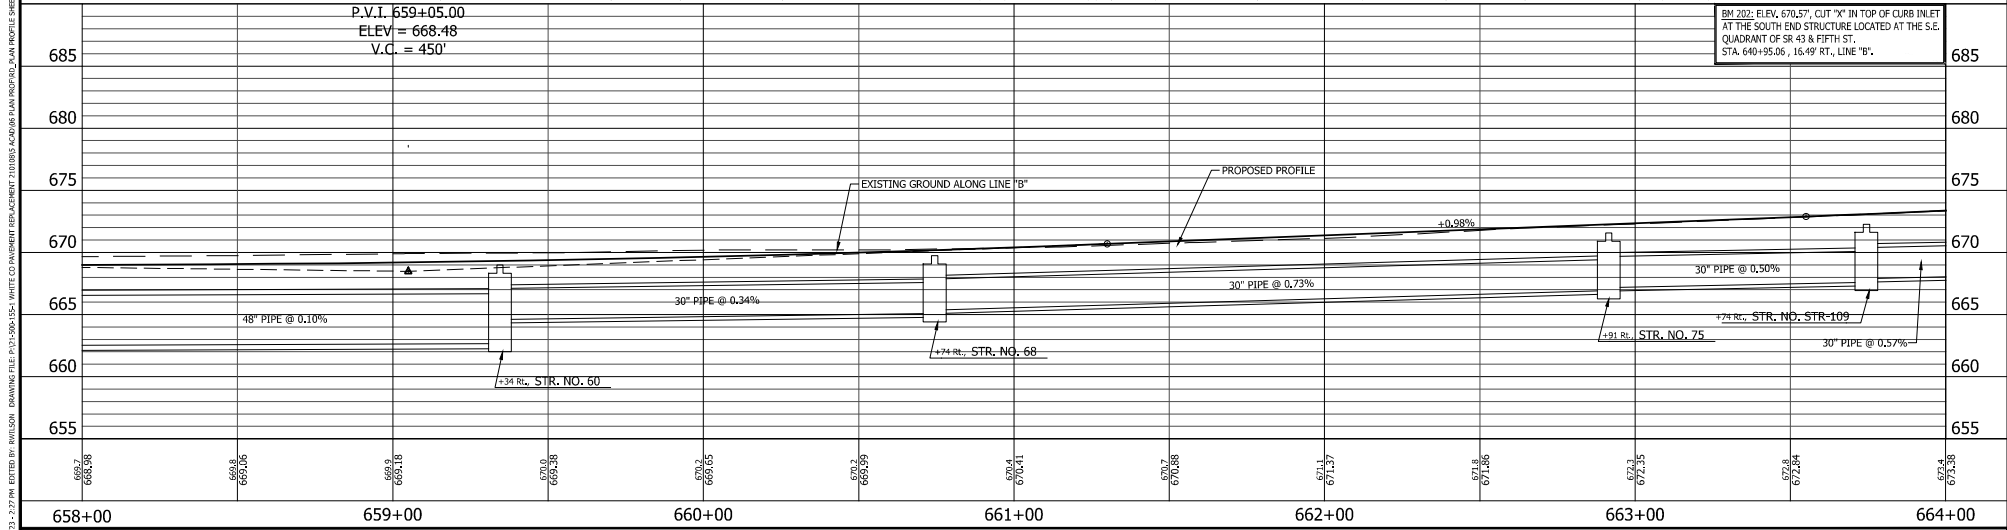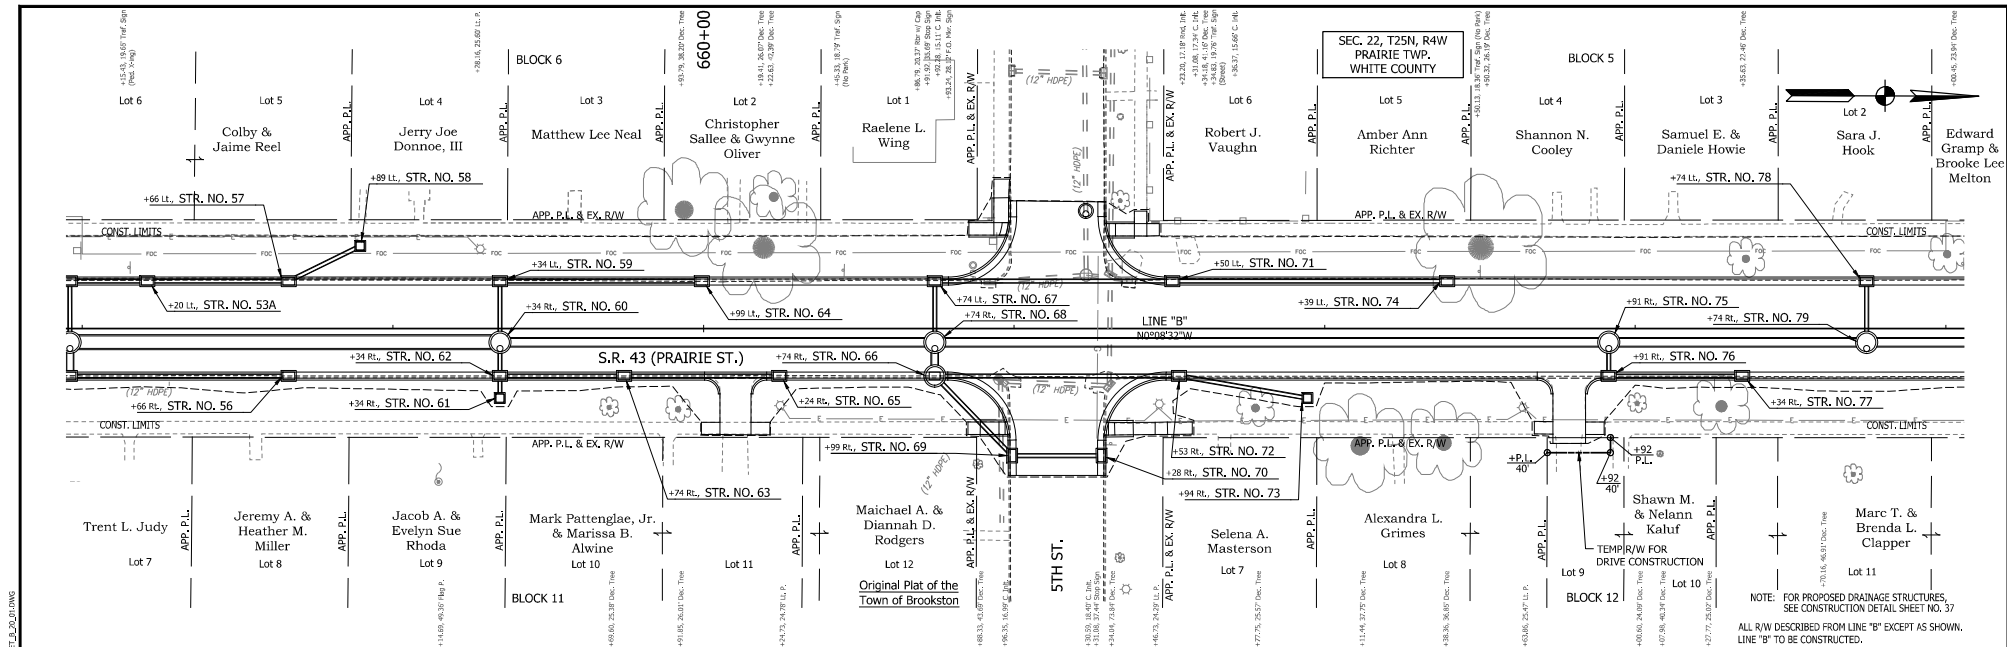




NOTE: FOR PROPOSED DRAINAGE STRUCTURES, SEE CONSTRUCTION DETAIL SHEET NO. 37. ALL R/W DESCRIBED FROM LINE "B" EXCEPT AS SHOWN. LINE "B" TO BE CONSTRUCTED.

104  
 264072.4650  
 7960098.7353  
 22-25H-4W  
 1\"/>

RECOMMENDED FOR APPROVAL	DESIGN ENGINEER	DATE
DESIGNED: BLW	DRAWN: BEW	
CHECKED: DCK	CHECKED: DCK	

INDIANA DEPARTMENT OF TRANSPORTATION  
 PLAN AND PROFILE  
 STA. 658+00.00 TO 664+00.00 LINE "B"

HORIZONTAL SCALE	BRIDGE FILE
1" = 20'	N/A
VERTICAL SCALE	DESIGNATION
1" = 5'	2001828
SURVEY BOOK	SHEET
	21 of 117
CONTRACT	PROJECT
R-43449	2001828

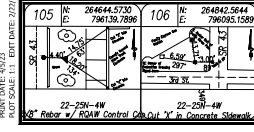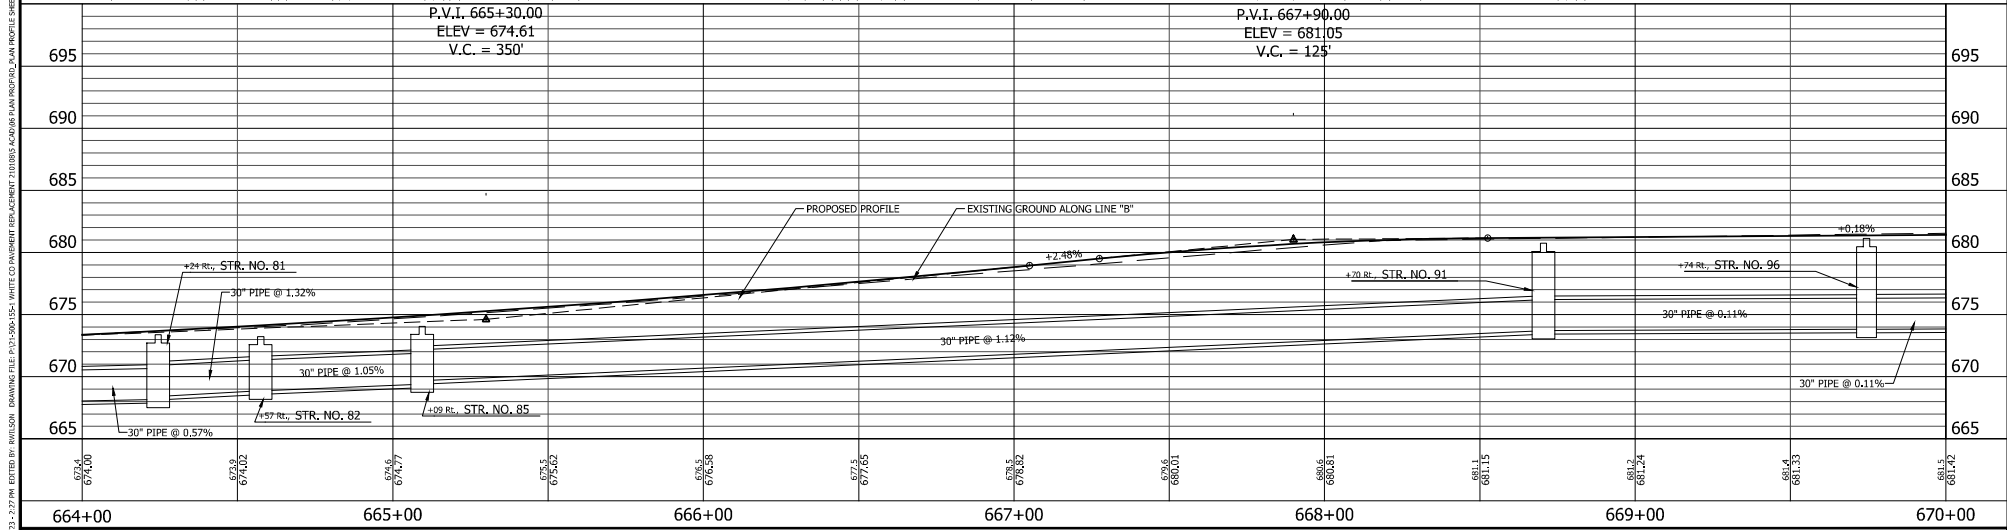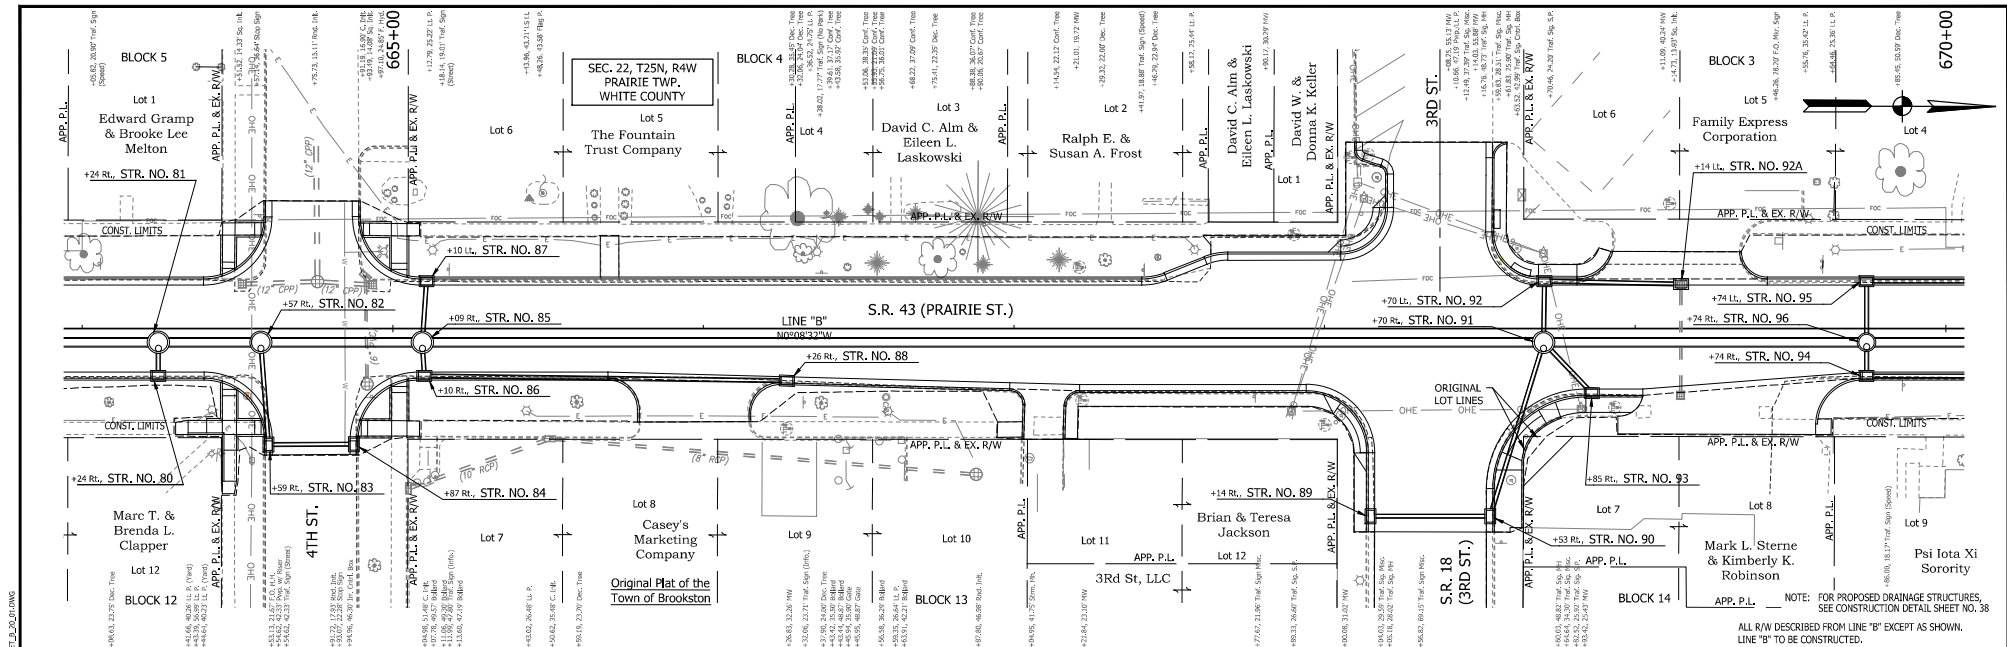



105 264644.5730 796139.7896	106 264842.5644 796025.1589
22-251-4W	22-251-4W

RECOMMENDED FOR APPROVAL	DESIGN ENGINEER	DATE
DESIGNED: <u>BLW</u>	DRAWN: <u>BEW</u>	
CHECKED: <u>DCK</u>	CHECKED: <u>DCK</u>	

INDIANA  
DEPARTMENT OF TRANSPORTATION

PLAN AND PROFILE  
STA. 664+00.00 TO 670+00.00 LINE "B"

HORIZONTAL SCALE 1" = 20'	BRIDGE FILE N/A
VERTICAL SCALE 1" = 5'	DESIGNATION 2001828
SURVEY BOOK	SHEET 22 of 117
CONTRACT R-43449	PROJECT 2001828

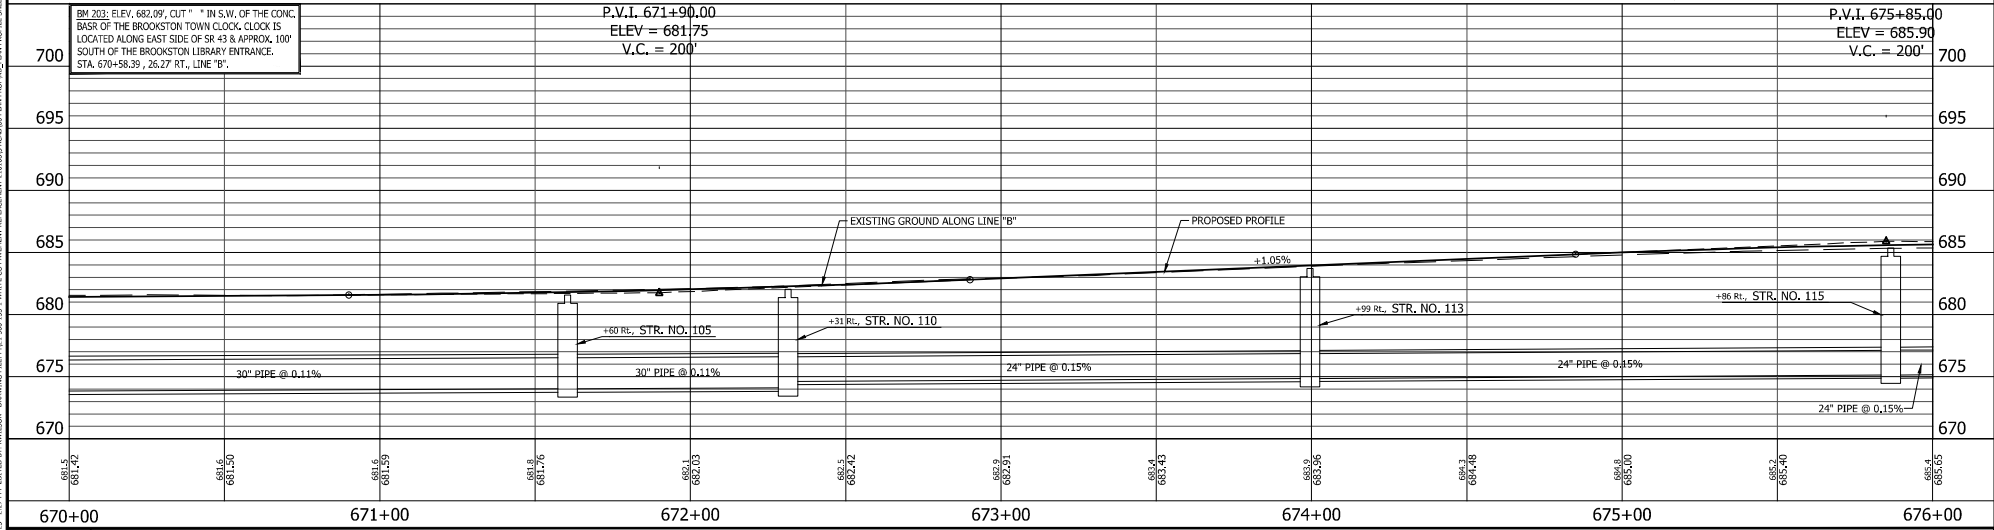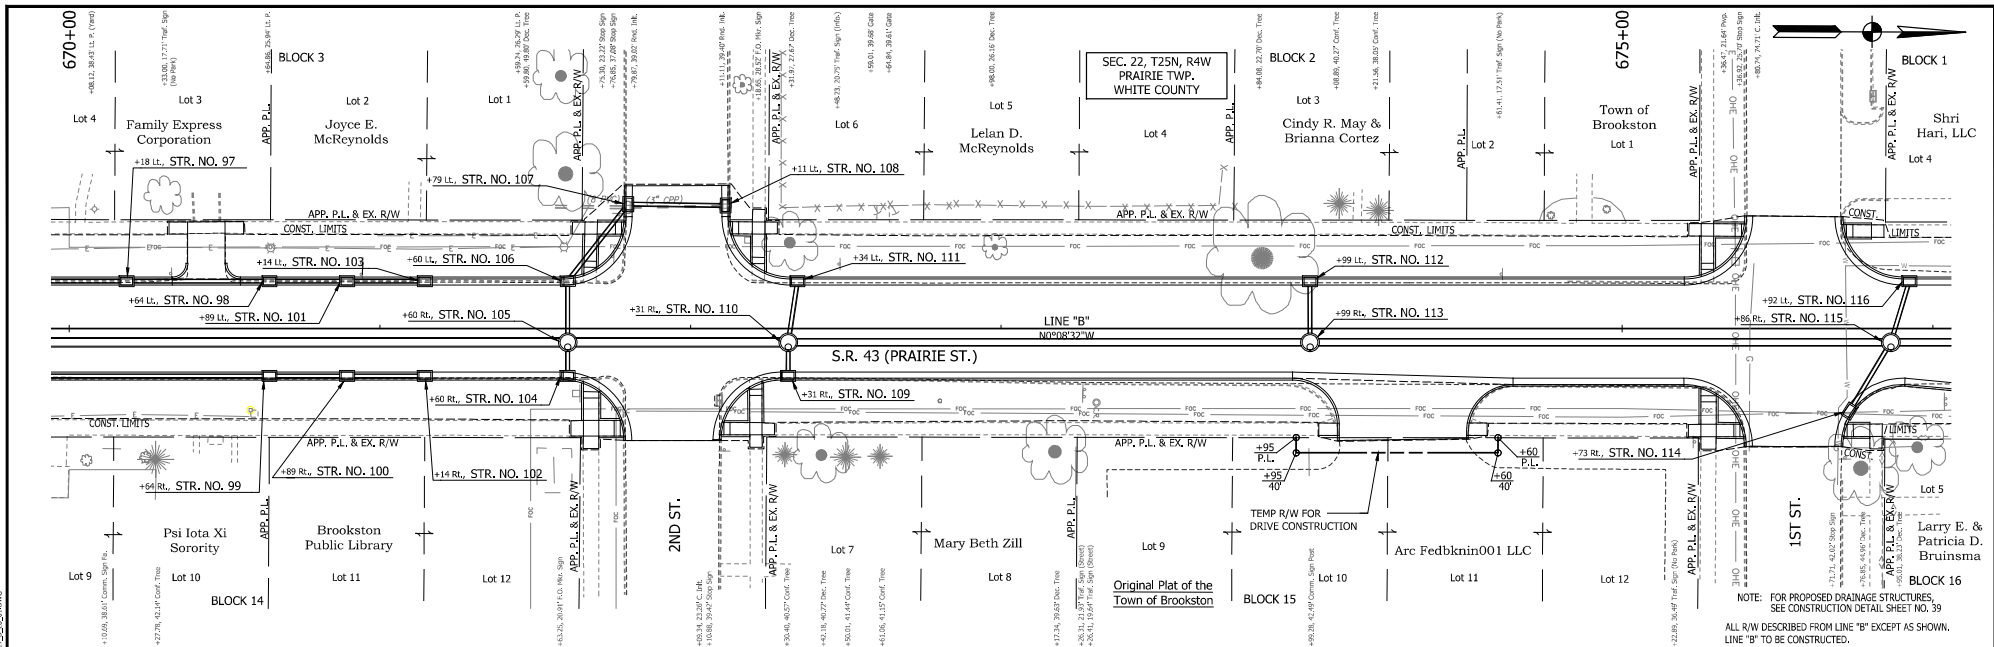


107  
 22-251-4W  
 2001828  
 746139.8299

DESIGNED: <u>BLW</u>	DRAWN: <u>BEW</u>
CHECKED: <u>DCK</u>	CHECKED: <u>DCK</u>


RECOMMENDED FOR APPROVAL _____	DESIGN ENGINEER _____	DATE _____
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INDIANA DEPARTMENT OF TRANSPORTATION  
 PLAN AND PROFILE  
 STA. 670+00.00 TO 676+00.00 LINE "B"

HORIZONTAL SCALE 1" = 20'	BRIDGE FILE N/A
VERTICAL SCALE 1" = 5'	DESIGNATION 2001828
SURVEY BOOK	SHEET 23 of 117
CONTRACT R-43449	PROJECT 2001828

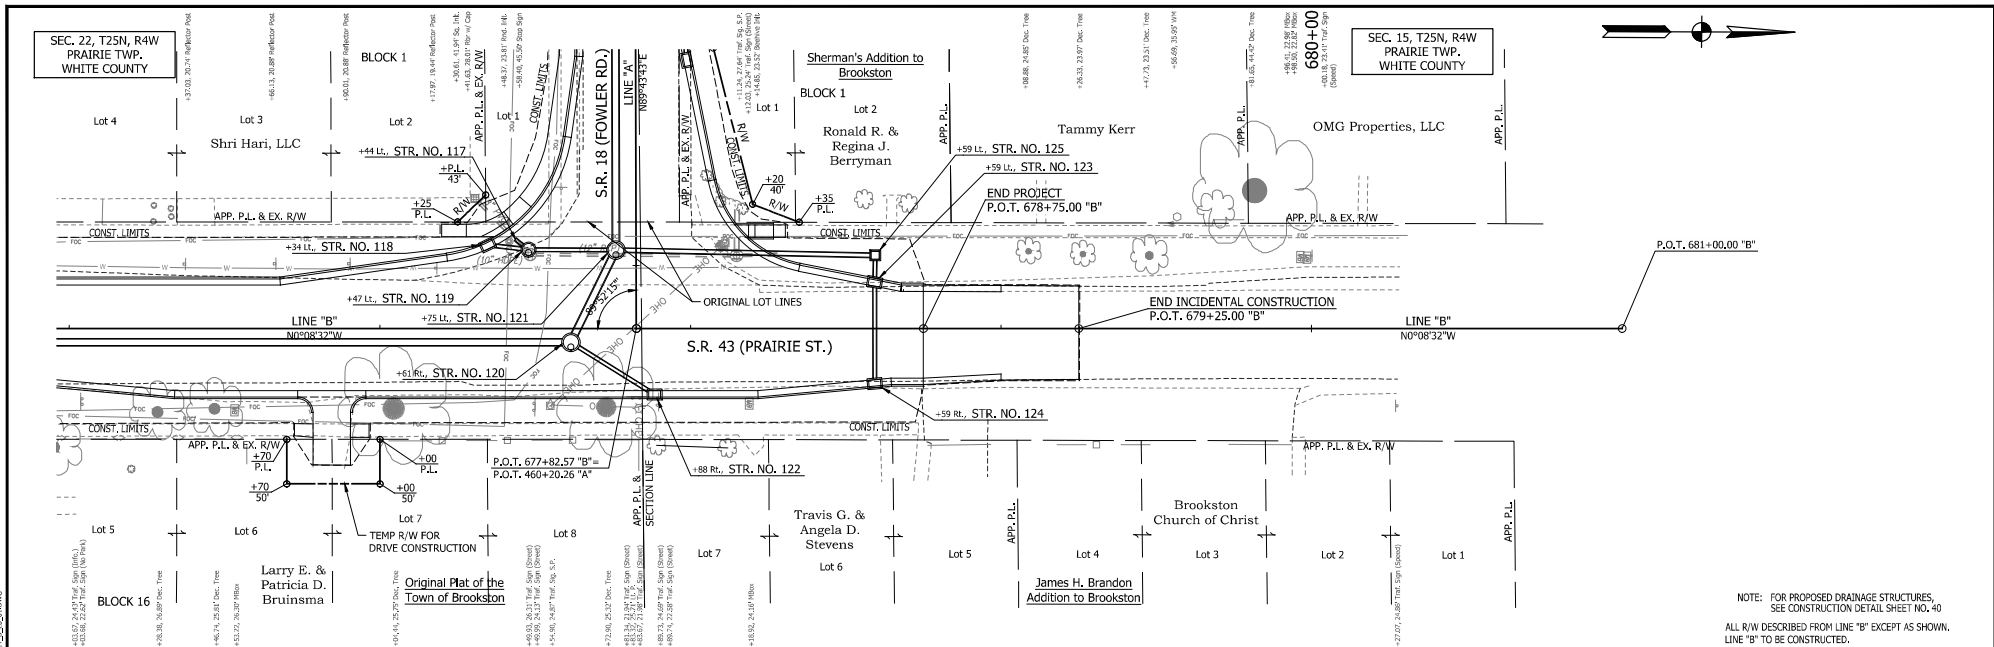

NOTE: FOR PROPOSED DRAINAGE STRUCTURES, SEE CONSTRUCTION DETAIL SHEET NO. 40  
ALL R/W DESCRIBED FROM LINE "B" EXCEPT AS SHOWN.  
LINE "B" TO BE CONSTRUCTED.

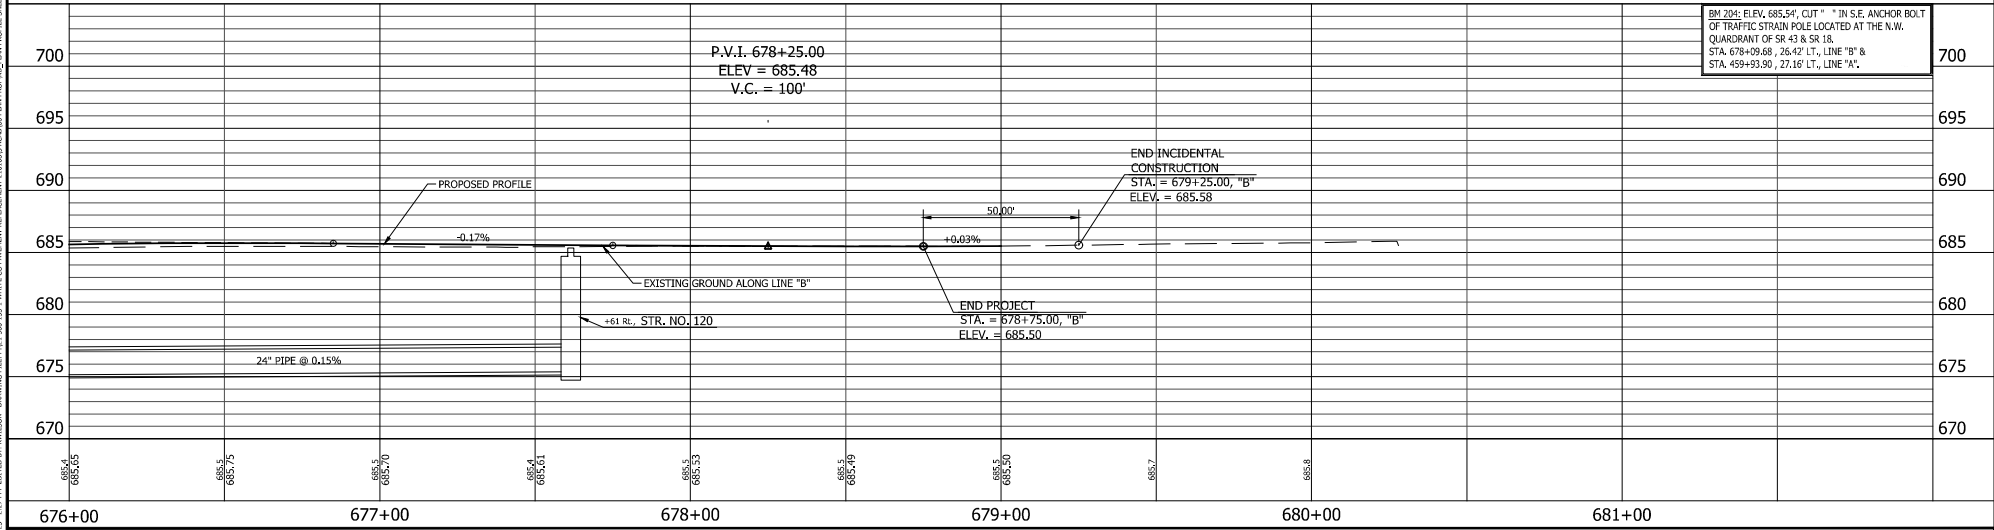

BM 204: ELEV. 685.54' CUT " " IN S.E. ANCHOR BOLT OF TRAFFIC STRAIN POLE LOCATED AT THE N.W. QUADRANT OF SR 43 & SR 18. STA. 678+09.68, 26.42' LT., LINE "B" & STA. 459+93.90, 27.16' LT., LINE "A".

108 IN 265727.2883  
P. 796086.9823  
SEC 22, T25N, R4W  
PRAIRIE TWP.,  
WHITE COUNTY,  
INDIANA  
22-25N-4W  
R-43449



RECOMMENDED FOR APPROVAL	DESIGN ENGINEER	DATE
DESIGNED: <u>BLW</u>	DRAWN: <u>BEW</u>	
CHECKED: <u>DCK</u>	CHECKED: <u>DCK</u>	

INDIANA  
DEPARTMENT OF TRANSPORTATION

PLAN AND PROFILE  
STA. 676+00.00 TO 681+00.00 LINE "B"

HORIZONTAL SCALE 1" = 20'	BRIDGE FILE N/A
VERTICAL SCALE 1" = 5'	DESIGNATION 2001828
SURVEY BOOK	SHEET 24 of 117
CONTRACT R-43449	PROJECT 2001828



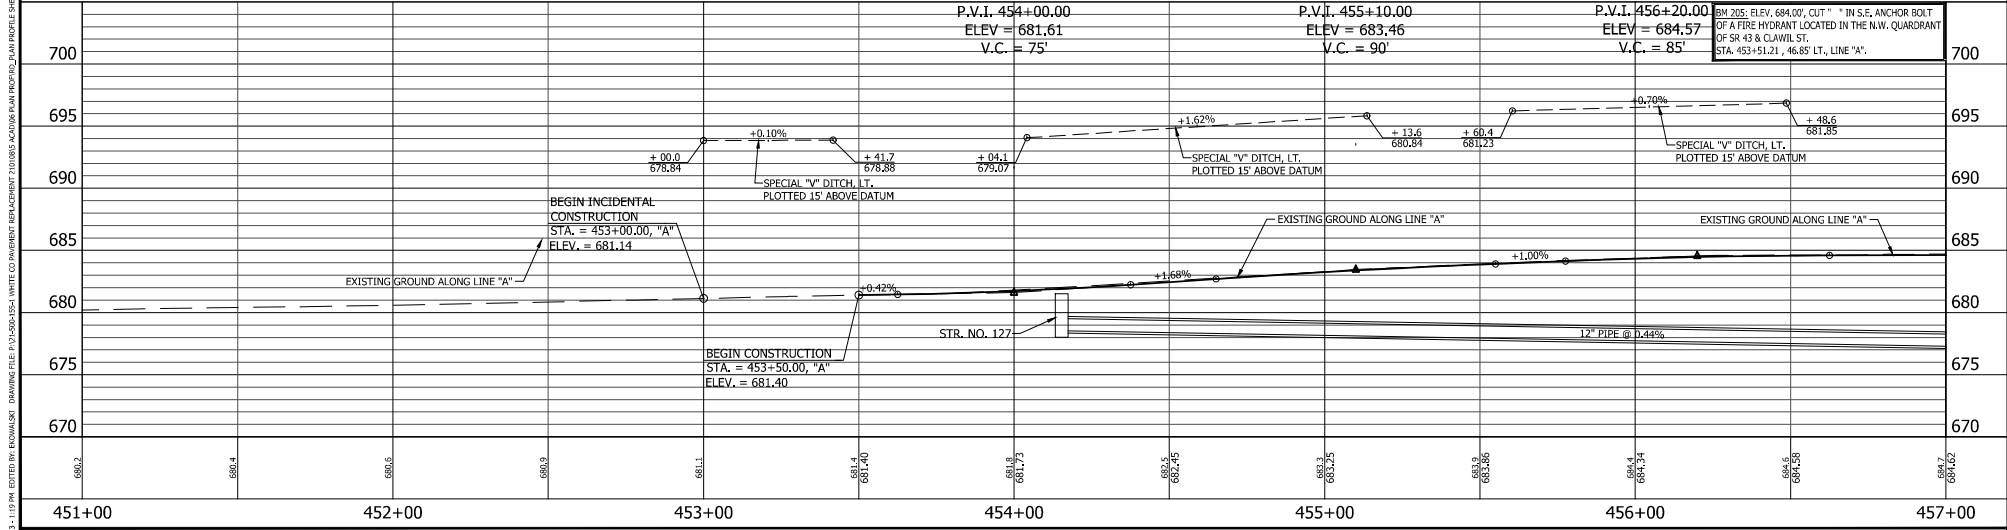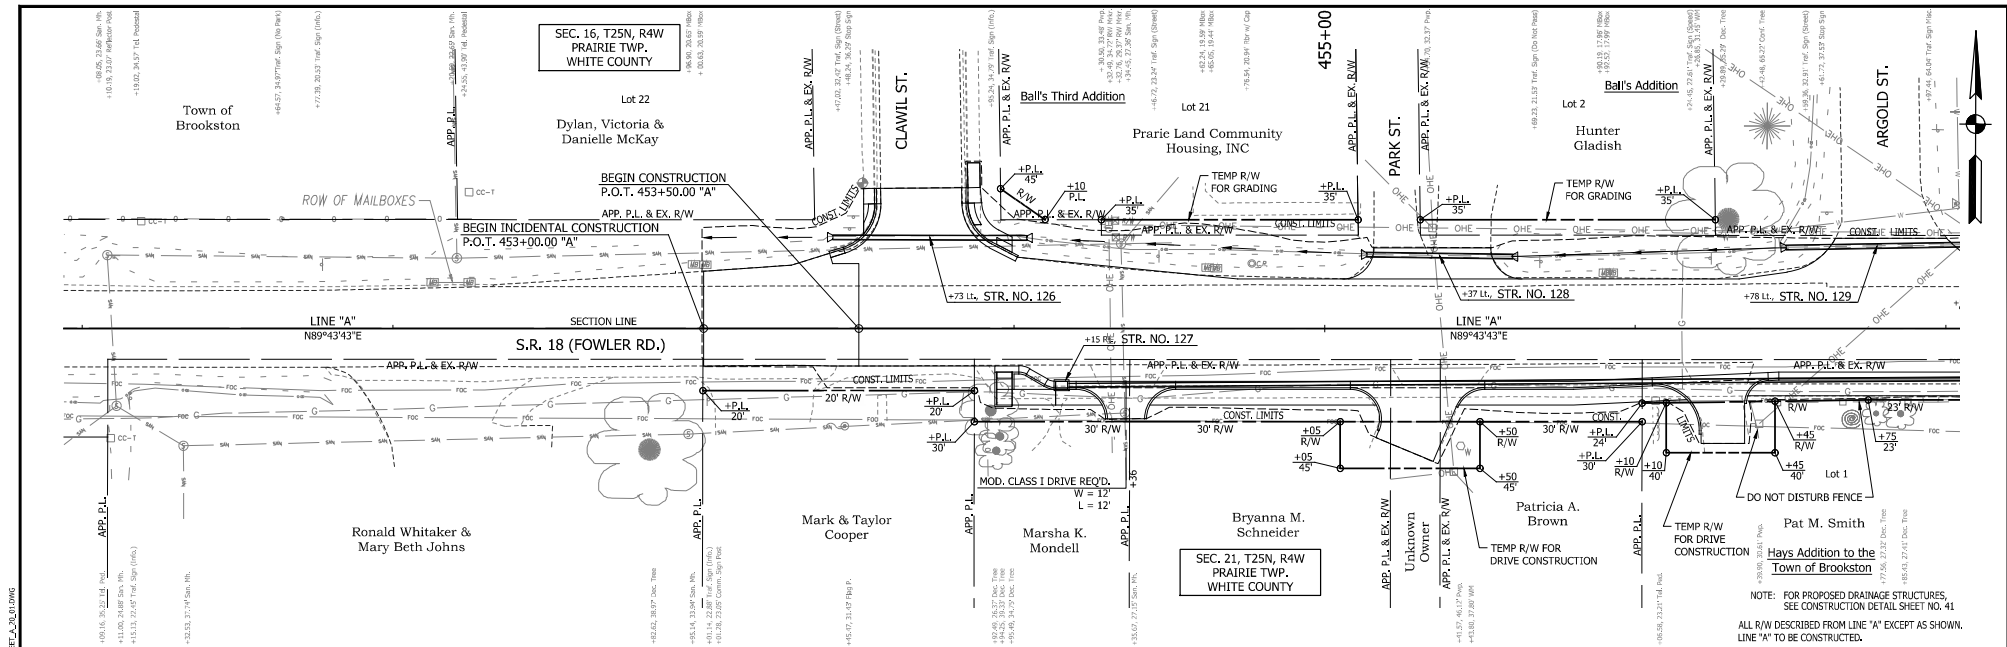


	<p>NOTE: FOR PROPOSED DRAINAGE STRUCTURES, SEE CONSTRUCTION DETAIL SHEET NO. 41 ALL R/W DESCRIBED FROM LINE "A" EXCEPT AS SHOWN. LINE "A" TO BE CONSTRUCTED.</p>	<p>INDIANA DEPARTMENT OF TRANSPORTATION</p>		<p>HORIZONTAL SCALE 1" = 20'</p>		<p>BRIDGE FILE N/A</p>	
		<p>PLAN AND PROFILE STA. 451+00.00 TO 457+00.00 LINE "A"</p>		<p>VERTICAL SCALE 1" = 5'</p>		<p>DESIGNATION 2001828</p>	
<p>DESIGNED: <b>BLW</b>      DRAWN: <b>BEW</b></p>				<p>SURVEY BOOK</p>		<p>SHEET 25 of 117</p>	
<p>CHECKED: <b>DCK</b>      CHECKED: <b>DCK</b></p>				<p>CONTRACT R-43449</p>		<p>PROJECT 2001828</p>	


109  
N.P. 265786.6585  
795571.0767  
16-25N-4W  
S/8' Refers to ROWW Cap

- LEGEND**
- (F) Concrete Sidewalk, 4"
  - (X) Full Depth Asphalt Pavement (See Typical Sections)
  - (N) Full Depth Asphalt Pavement (See Typical Sections)
  - (R) Milling, Asphalt 1.5" (See Typical Sections)
  - (W) Widening with HMA, Type C
  - (14) Mod. Concrete Rolled Curb (Sloping)
  - (15) Combined Concrete Curb & Gutter
  - (16) Curb, Concrete (Vertical)
  - (X) Sidewalk Curb Ramp

PRINT DATE: 4/23/23 1:18 PM EST BY: KOWALSKI DRAWING FILE: P:\30000\556\WHITE\CD\DWG\BENCHMKT 2101828\4001828\PLAN\PROF\23\_PAN\PROF12\_SHEET\_041.DWG

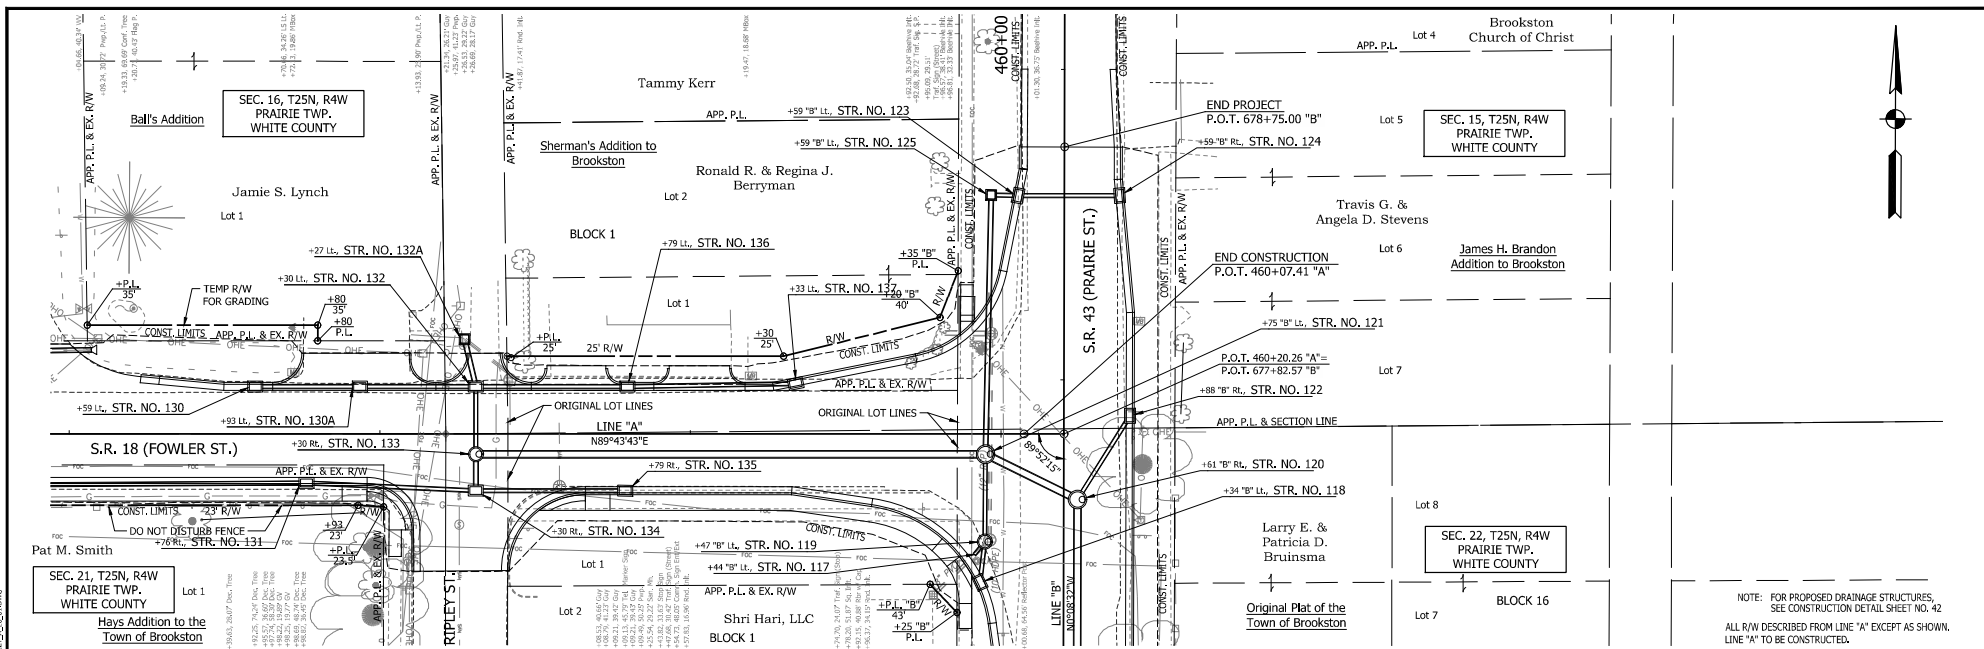

NOTE: FOR PROPOSED DRAINAGE STRUCTURES, SEE CONSTRUCTION DETAIL SHEET NO. 42  
 ALL R/W DESCRIBED FROM LINE "A" EXCEPT AS SHOWN.  
 LINE "A" TO BE CONSTRUCTED.

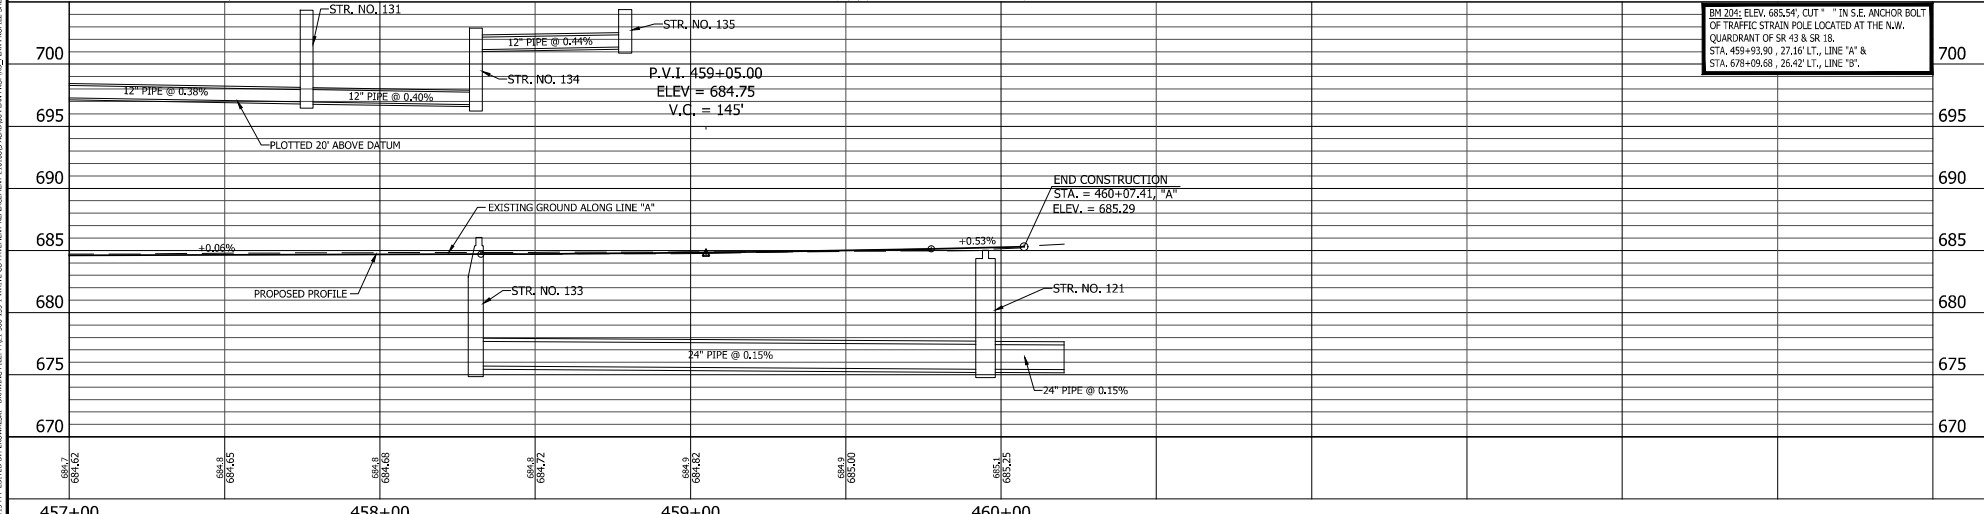


BM 205: ELEV. 685.54; CUT " " IN S.E. ANCHOR BOLT OF TRAFFIC STRAIN POLE LOCATED AT THE N.W. QUADRANT OF SR 43 & SR 18. STA. 459+93.90, 27.16' LT., LINE "A" & STA. 678+09.69, 25.42' LT., LINE "B".


<table border="1" style="width: 100%; border-collapse: collapse;"> <tr> <td style="font-size: 8px;">108</td> <td style="font-size: 8px;">IN</td> <td style="font-size: 8px;">265727.2883</td> </tr> <tr> <td style="font-size: 8px;">SEC 18</td> <td style="font-size: 8px;">P</td> <td style="font-size: 8px;">796086.8823</td> </tr> <tr> <td style="font-size: 8px;">22-25N-4W</td> <td style="font-size: 8px;">R-43</td> <td style="font-size: 8px;">R-43449</td> </tr> <tr> <td style="font-size: 8px;">S.78'</td> <td style="font-size: 8px;">R/W</td> <td style="font-size: 8px;">/ Comp</td> </tr> </table>	108	IN	265727.2883	SEC 18	P	796086.8823	22-25N-4W	R-43	R-43449	S.78'	R/W	/ Comp	<p>             (F) Concrete Sidewalk, 4"              (X) Full Depth Asphalt Pavement (See Typical Sections)              (N) Full Depth Asphalt Pavement (See Typical Sections)              (R) Milling, Asphalt 1.5" (See Typical Sections)           </p> <p style="text-align: center;"><b>LEGEND</b></p> <p>             (W) Widening with HMA, Type C              (14) Mod. Concrete Rolled Curb (Sloping)              (15) Combined Concrete Curb &amp; Gutter              (16) Curb, Concrete (Vertical)              (X) Sidewalk Curb Ramp           </p>	<p>             RECOMMENDED FOR APPROVAL _____ DESIGN ENGINEER _____ DATE _____              DESIGNED: <u>BLW</u> DRAWN: <u>BEW</u>              CHECKED: <u>DCK</u> CHECKED: <u>DCK</u> </p>	<p>             INDIANA              DEPARTMENT OF TRANSPORTATION              PLAN AND PROFILE              STA. 457+00.00 TO 460+20.26 LINE "A"           </p>	<table border="1" style="width: 100%; border-collapse: collapse;"> <tr> <td>HORIZONTAL SCALE</td> <td>BRIDGE FILE</td> </tr> <tr> <td>1" = 20'</td> <td>N/A</td> </tr> <tr> <td>VERTICAL SCALE</td> <td>DESIGNATION</td> </tr> <tr> <td>1" = 5'</td> <td>2001828</td> </tr> <tr> <td>SURVEY BOOK</td> <td>SHEET</td> </tr> <tr> <td></td> <td>26 of 117</td> </tr> <tr> <td>CONTRACT</td> <td>PROJECT</td> </tr> <tr> <td>R-43449</td> <td>2001828</td> </tr> </table>	HORIZONTAL SCALE	BRIDGE FILE	1" = 20'	N/A	VERTICAL SCALE	DESIGNATION	1" = 5'	2001828	SURVEY BOOK	SHEET		26 of 117	CONTRACT	PROJECT	R-43449	2001828
108	IN	265727.2883																														
SEC 18	P	796086.8823																														
22-25N-4W	R-43	R-43449																														
S.78'	R/W	/ Comp																														
HORIZONTAL SCALE	BRIDGE FILE																															
1" = 20'	N/A																															
VERTICAL SCALE	DESIGNATION																															
1" = 5'	2001828																															
SURVEY BOOK	SHEET																															
	26 of 117																															
CONTRACT	PROJECT																															
R-43449	2001828																															

PRINT DATE: 4/23/11 1:38 PM EST BY: KOWALSKI DRAWING FILE: P:\30664\554\UNITS\OD IMPROVEMENT\BRANCHMENT\200805\AC0709\PLAN\PROFILES\STORM\PROFILE SHEET\_A\_A\_2011.DWG  
 PLOT SCALE: 1:1


LINE "A" STR. 127 - STR. 135

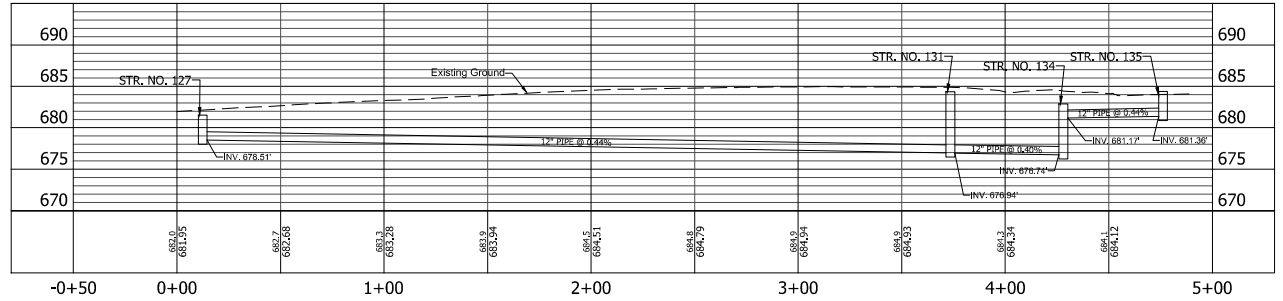

LINE "A" STR. 134 - STR. 132

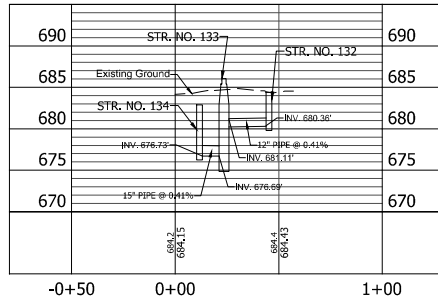

LINE "A" STR. 130 - STR. 137

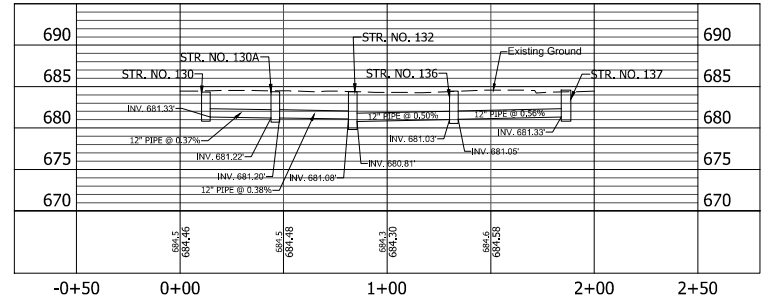

		RECOMMENDED FOR APPROVAL _____ DESIGN ENGINEER DATE	INDIANA DEPARTMENT OF TRANSPORTATION  STORM SEWER LINE "A" STORM PROFILES	HORIZONTAL SCALE 1" = 20' VERTICAL SCALE 1" = 5'	BRIDGE FILE N/A DESIGNATION 2001828
		DESIGNED: <u>BLW</u> DRAWN: <u>EJK</u> CHECKED: <u>DCX</u> CHECKED: <u>DCX</u>		SURVEY BOOK _____ SHEET _____ 32 of 117	CONTRACT R-43449 PROJECT 2001828

635+00

640+00



SEC. 22, T25N, R4W  
PRAIRIE TWP.  
WHITE COUNTY

James T. &  
Teresa R. Jones

Mark K. &  
Hattie. L. Werline

Frontier School  
Corporation

Lot 4  
Edward  
& Stacy  
Jacobs  
Creekview  
Subdivision

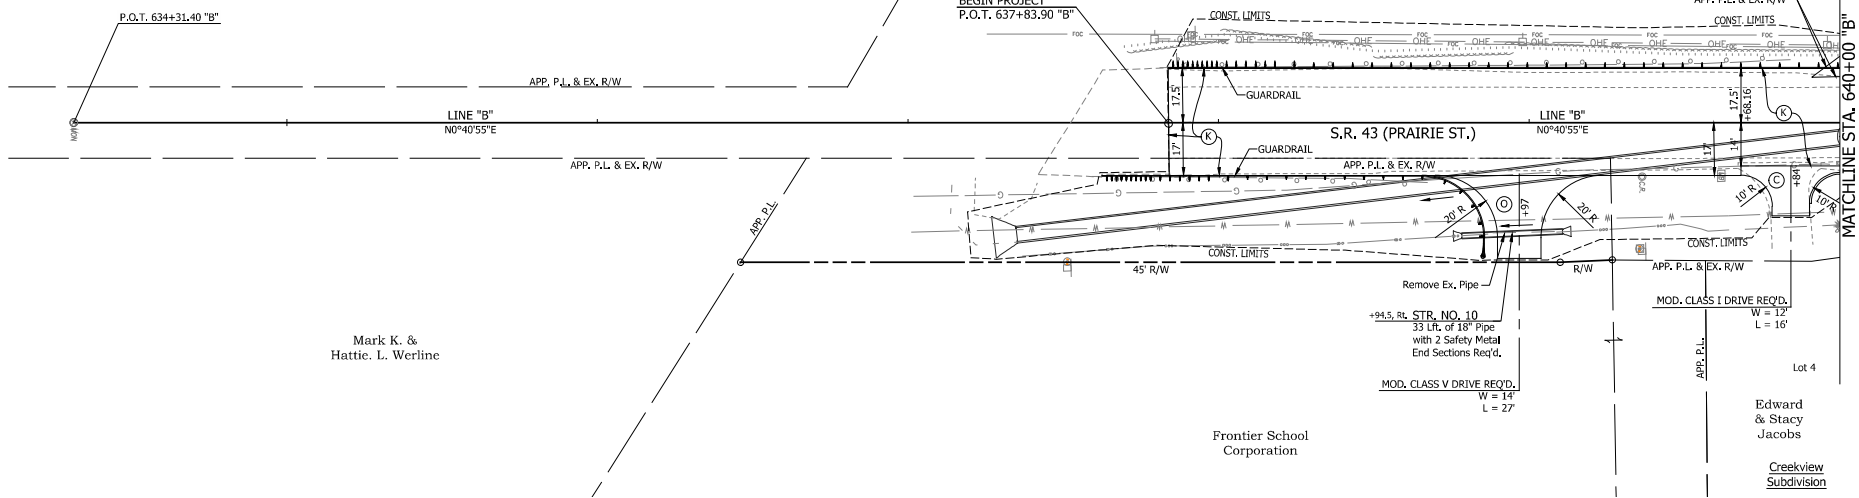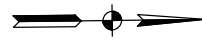

PRINT DATE: 9/23/23 11:20 AM EDITED BY: DMRTZ DRAWING FILE: I:\210801828\WHITE CO\INVENTORY\REPLACEMENT\210801828\CONSTR\210801828\CONSTR\210801828\CONSTR.DWG

LEGEND			
⊙	Compacted Aggregate No. 73	Ⓜ	Widening with HMA, Type C
⊕	Concrete Sidewalk, 4"	Ⓛ	Mod. Concrete Rolled Curb (Sloping)
⊗	Full Depth Asphalt Pavement (See Typical Sections)	Ⓜ	Combined Concrete Curb & Gutter
⊕	PCCP for Approaches, 6"	Ⓛ	Curb, Concrete (Vertical)
⊕	PCCP for Approaches, 9"	Ⓧ	Sidewalk Curb Ramp
⊕	Full Depth Asphalt Pavement (See Typical Sections)		
Ⓜ	HMA for Approaches, Type B		
Ⓜ	Milling, Asphalt 1.5" (See Typical Sections)		

RECOMMENDED FOR APPROVAL	DESIGN ENGINEER	DATE
DESIGNED: <u>BLW</u>	DRAWN: <u>BEW</u>	
CHECKED: <u>DCK</u>	CHECKED: <u>DCK</u>	

INDIANA  
DEPARTMENT OF TRANSPORTATION


CONSTRUCTION DETAILS  
STA. 634+31.40 TO 640+00.00 LINE "B"

HORIZONTAL SCALE	BRIDGE FILE
1" = 20'	N/A
VERTICAL SCALE	DESIGNATION
N/A	2001828
SURVEY BOOK	SHEET
	33 of 117
CONTRACT	PROJECT
R-43449	2001828

640+00

645+00

SEC. 22, T25N, R4W  
PRAIRIE TWP.  
WHITE COUNTY

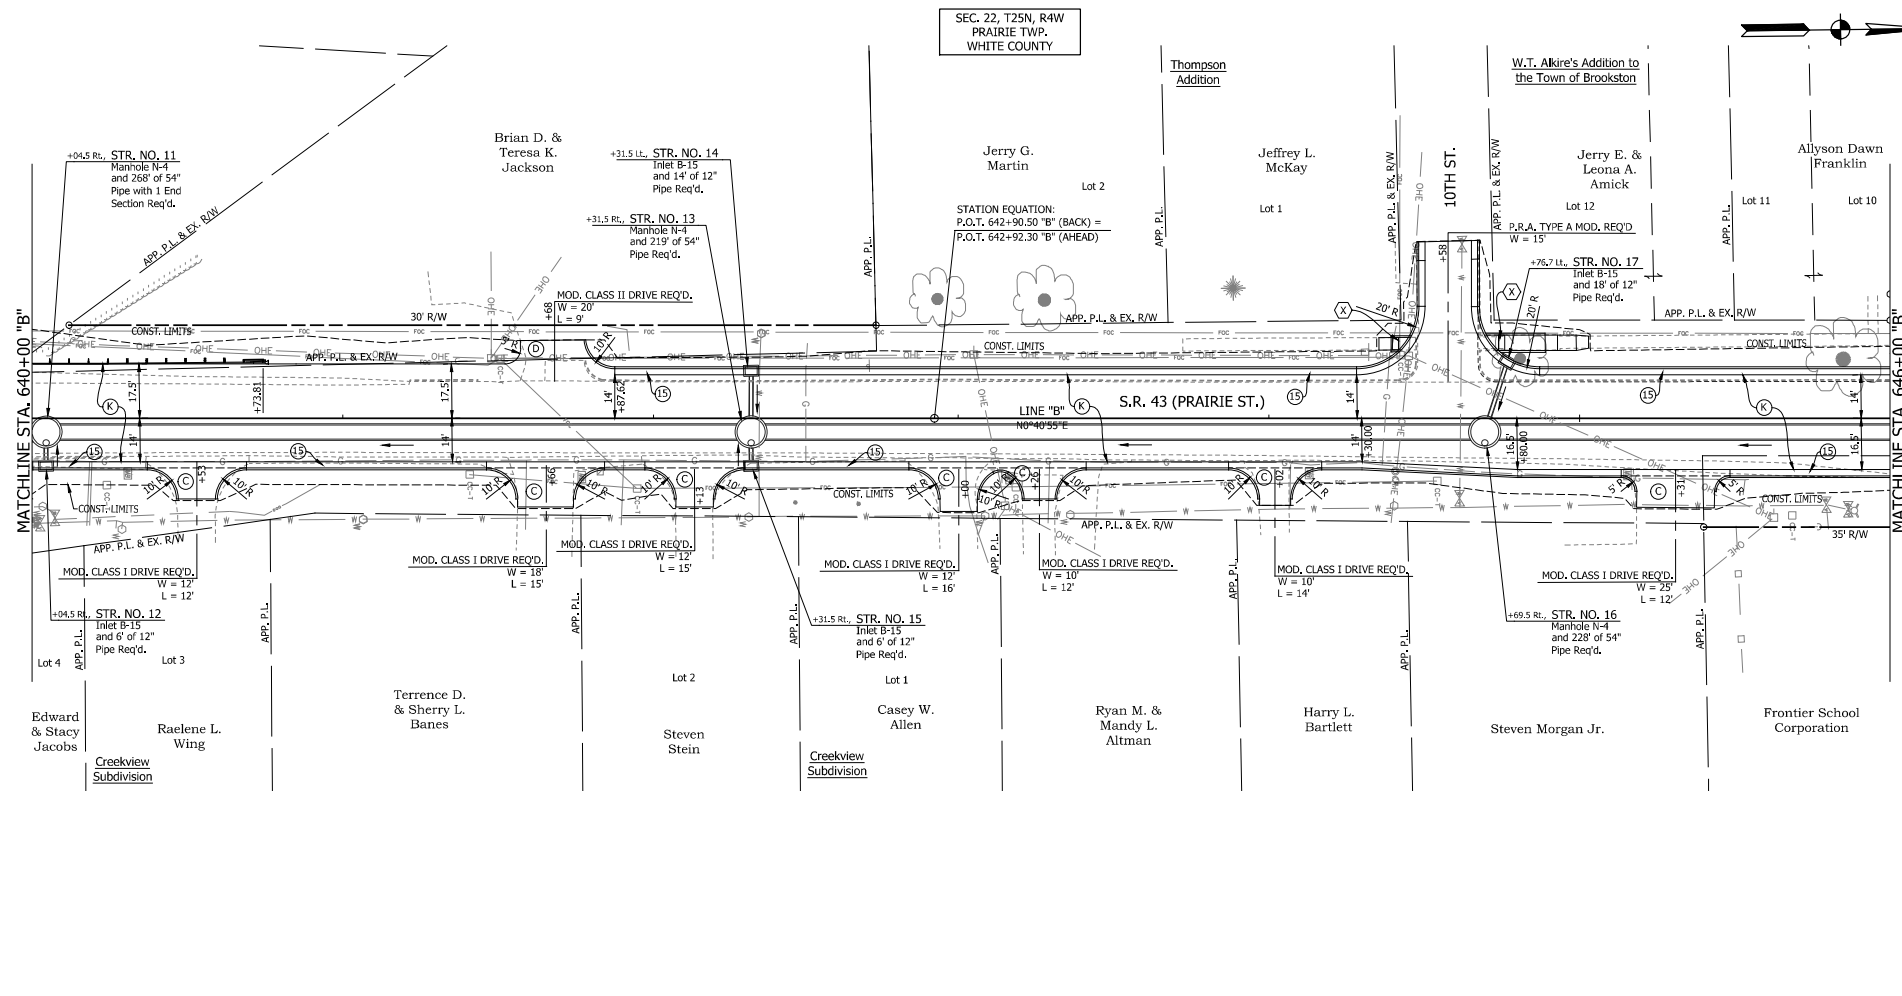

PRINT DATE: 9/23/23 11:20 AM EDITOR: DWMTY DRAWING FILE: F:\13\08\15\1 WHITE CO\PROJECT\REDUCED\2001828\ASB\DWG\LOWER\DETAILS\B.DWG  
 PLOT SCALE: 1:1


LEGEND	
(C) Compacted Aggregate No. 73	(F) Concrete Sidewalk, 4"
(E) PCP for Approaches, 6"	(X) Full Depth Asphalt Pavement (See Typical Sections)
(D) PCP for Approaches, 9"	(14) Mod. Concrete Rolled Curb (Sloping)
(G) HMA for Approaches, Type B	(15) Combined Concrete Curb & Gutter
	(16) Curb, Concrete (Vertical)
	(X) Sidewalk Curb Ramp

RECOMMENDED FOR APPROVAL	DESIGN ENGINEER	DATE
DESIGNED: <u>BLW</u>	DRAWN: <u>BEW</u>	
CHECKED: <u>DCK</u>	CHECKED: <u>DCK</u>	

**INDIANA DEPARTMENT OF TRANSPORTATION**  
**CONSTRUCTION DETAILS**  
**STA. 640+00.00 TO 646+00.00 LINE "B"**


HORIZONTAL SCALE	BRIDGE FILE
1" = 20'	N/A
VERTICAL SCALE	DESIGNATION
N/A	2001828
SURVEY BOOK	SHEET
	34 of 117
CONTRACT	PROJECT
R-43449	2001828

PRINT DATE: 4/23/23 11:30 AM EDIT DATE: 2/23/23 11:30 AM EDITED BY: DMWY DRAWING FILE: I:\14\08\0151\WHITE CO\INVENTORY\REPLACEMENT\2001828\ASPHALT\CONSTR\DETAILS\B.DWG

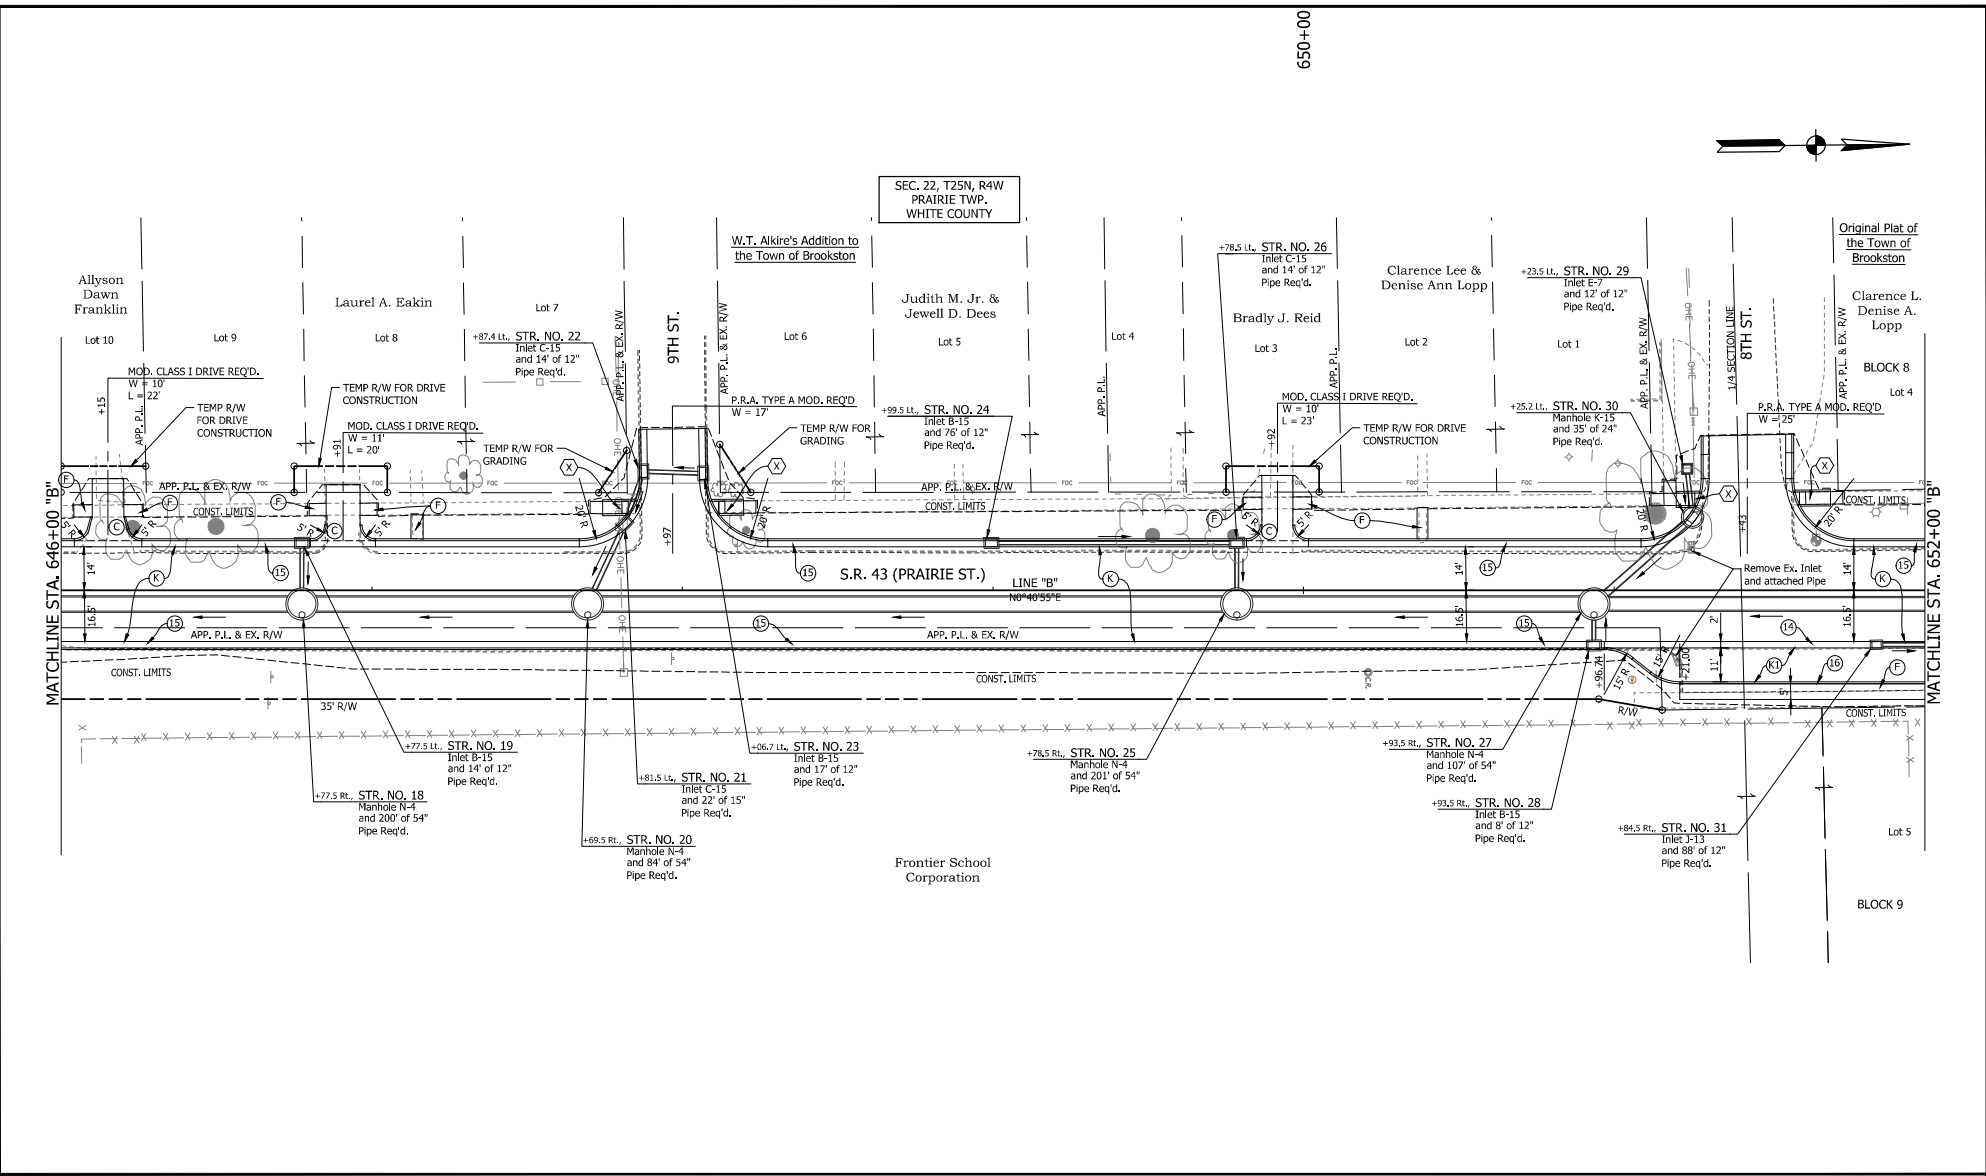

<p><b>LEGEND</b></p> <p>(C) Compacted Aggregate No. 73</p> <p>(P) Concrete Sidewalk, 4"</p> <p>(C) PCCP for Approaches, 6"</p> <p>(E) PCCP for Approaches, 9"</p> <p>(H) HMA for Approaches, Type B</p> <p>(F) Concrete Sidewalk, 4"</p> <p>(X) Full Depth Asphalt Pavement (See Typical Sections)</p> <p>(H) Full Depth Asphalt Pavement (See Typical Sections)</p> <p>(R) Milling, Asphalt 1.5" (See Typical Sections)</p> <p>(W) Widening with HMA, Type C</p> <p>(14) Mod. Concrete Rolled Curb (Sloping)</p> <p>(15) Combined Concrete Curb &amp; Gutter</p> <p>(16) Curb, Concrete (Vertical)</p> <p>(X) Sidewalk Curb Ramp</p>	<p>RECOMMENDED FOR APPROVAL _____</p> <p>DESIGN ENGINEER _____ DATE _____</p>	<p>INDIANA DEPARTMENT OF TRANSPORTATION</p> <p>CONSTRUCTION DETAILS</p> <p>STA. 646+00.00 TO 652+00.00 LINE "B"</p>	<p>HORIZONTAL SCALE 1" = 20'</p> <p>VERTICAL SCALE N/A</p> <p>SURVEY BOOK _____</p> <p>SHEET 35 of 117</p> <p>CONTRACT R-43449</p> <p>BRIDGE FILE N/A</p> <p>DESIGNATION 2001828</p> <p>PROJECT 2001828</p>
	<p>DESIGNED: <u>BLW</u></p> <p>CHECKED: <u>DCK</u></p>		<p>DRAWN: <u>BEW</u></p> <p>CHECKED: <u>DCK</u></p>

655+00

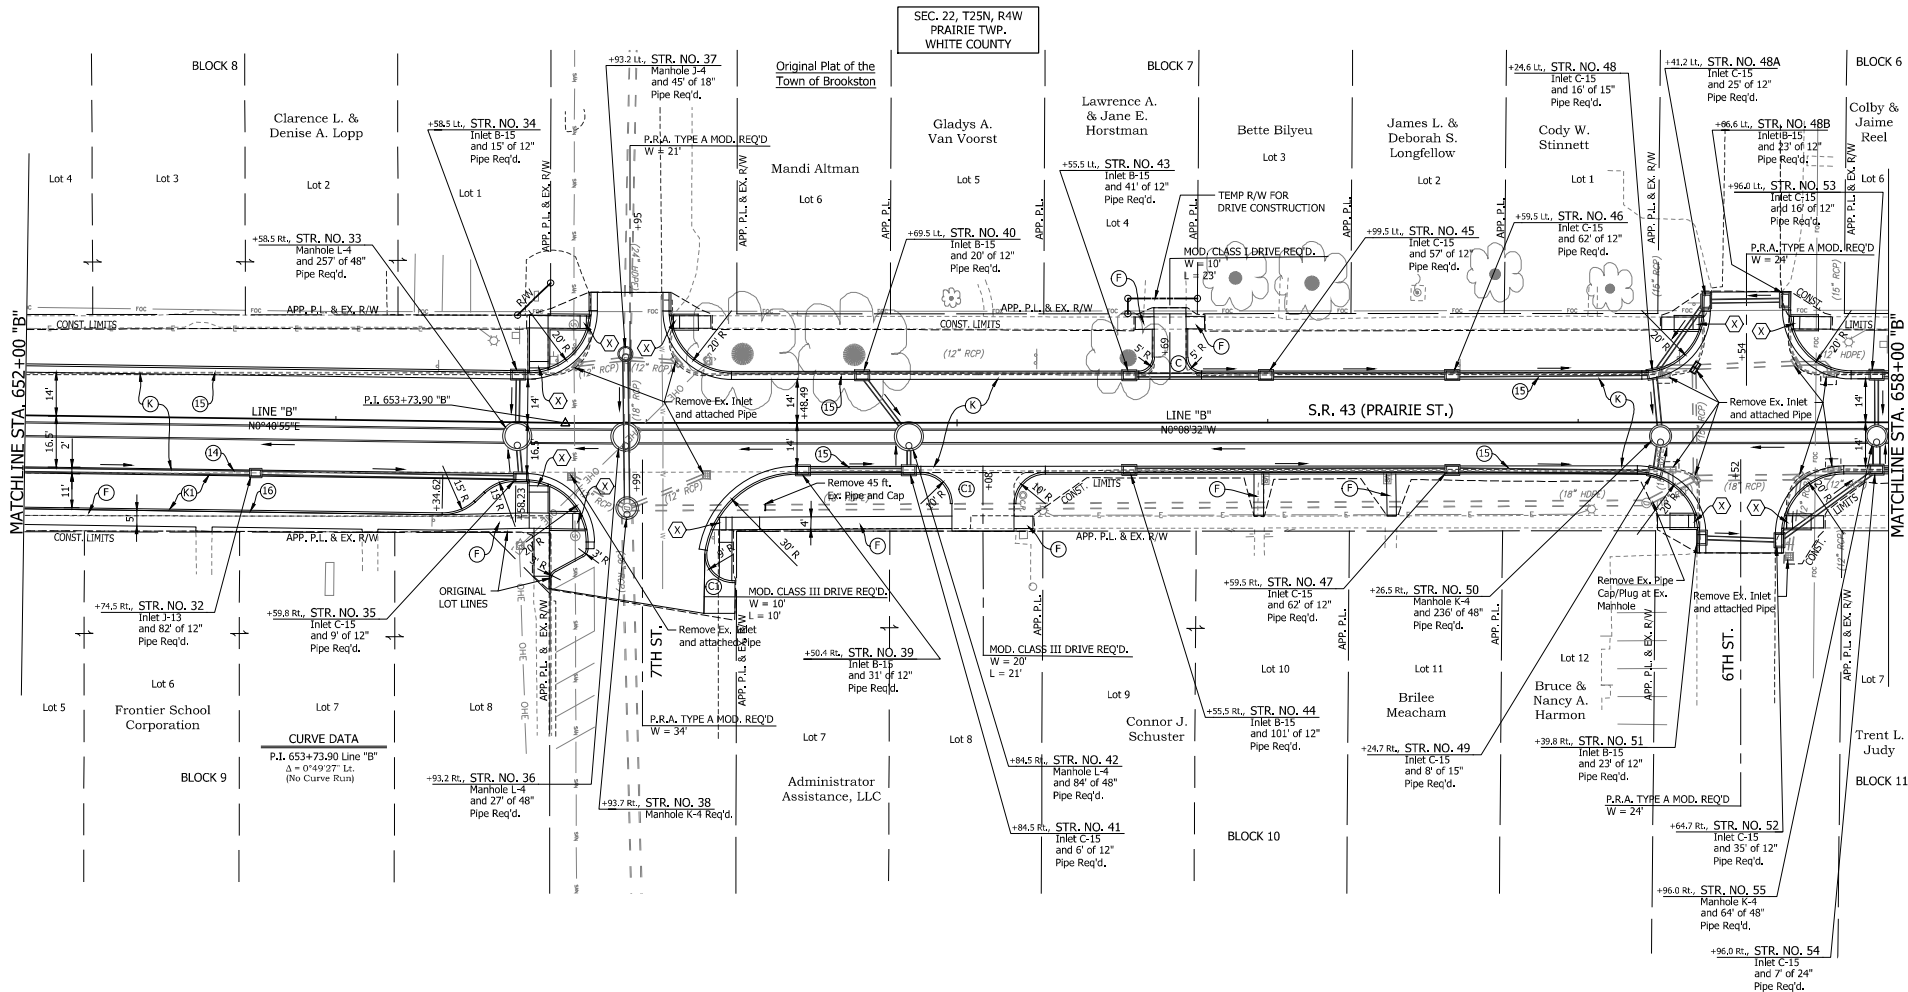

MATCHLINE STA. 652+00 "B"

MATCHLINE STA. 658+00 "B"

LEGEND	
(C)	Compacted Aggregate No. 73
(P)	Concrete Sidewalk, 4"
(X)	Full Depth Asphalt Pavement (See Typical Sections)
(M)	PCCP for Approaches, 9"
(N)	Full Depth Asphalt Pavement (See Typical Sections)
(R)	Milling, Asphalt 1.5" (See Typical Sections)
(W)	Widening with HMA, Type C
(14)	Mod. Concrete Rolled Curb (Sloping)
(15)	Combined Concrete Curb & Gutter
(16)	Curb, Concrete (Vertical)
(X)	Sidewalk Curb Ramp

RECOMMENDED FOR APPROVAL	DESIGN ENGINEER	DATE
DESIGNED: <u>BLW</u>	DRAWN: <u>BEW</u>	
CHECKED: <u>DCK</u>	CHECKED: <u>DCK</u>	


INDIANA  
DEPARTMENT OF TRANSPORTATION

CONSTRUCTION DETAILS  
STA. 652+00.00 TO 658+00.00 LINE "B"

HORIZONTAL SCALE	BRIDGE FILE
1" = 20'	N/A
VERTICAL SCALE	DESIGNATION
N/A	2001828
SURVEY BOOK	SHEET
	36 of 117
CONTRACT	PROJECT
R-43449	2001828

PRINT DATE: 9/23/2013 11:20 AM EDITOR: DWMTT DRAWING FILE: F:\210801551\WHITE CO\INVENTORY\REPLACEMENT\2001828\ASPHALT\DETAILS\3.DWG

660+00

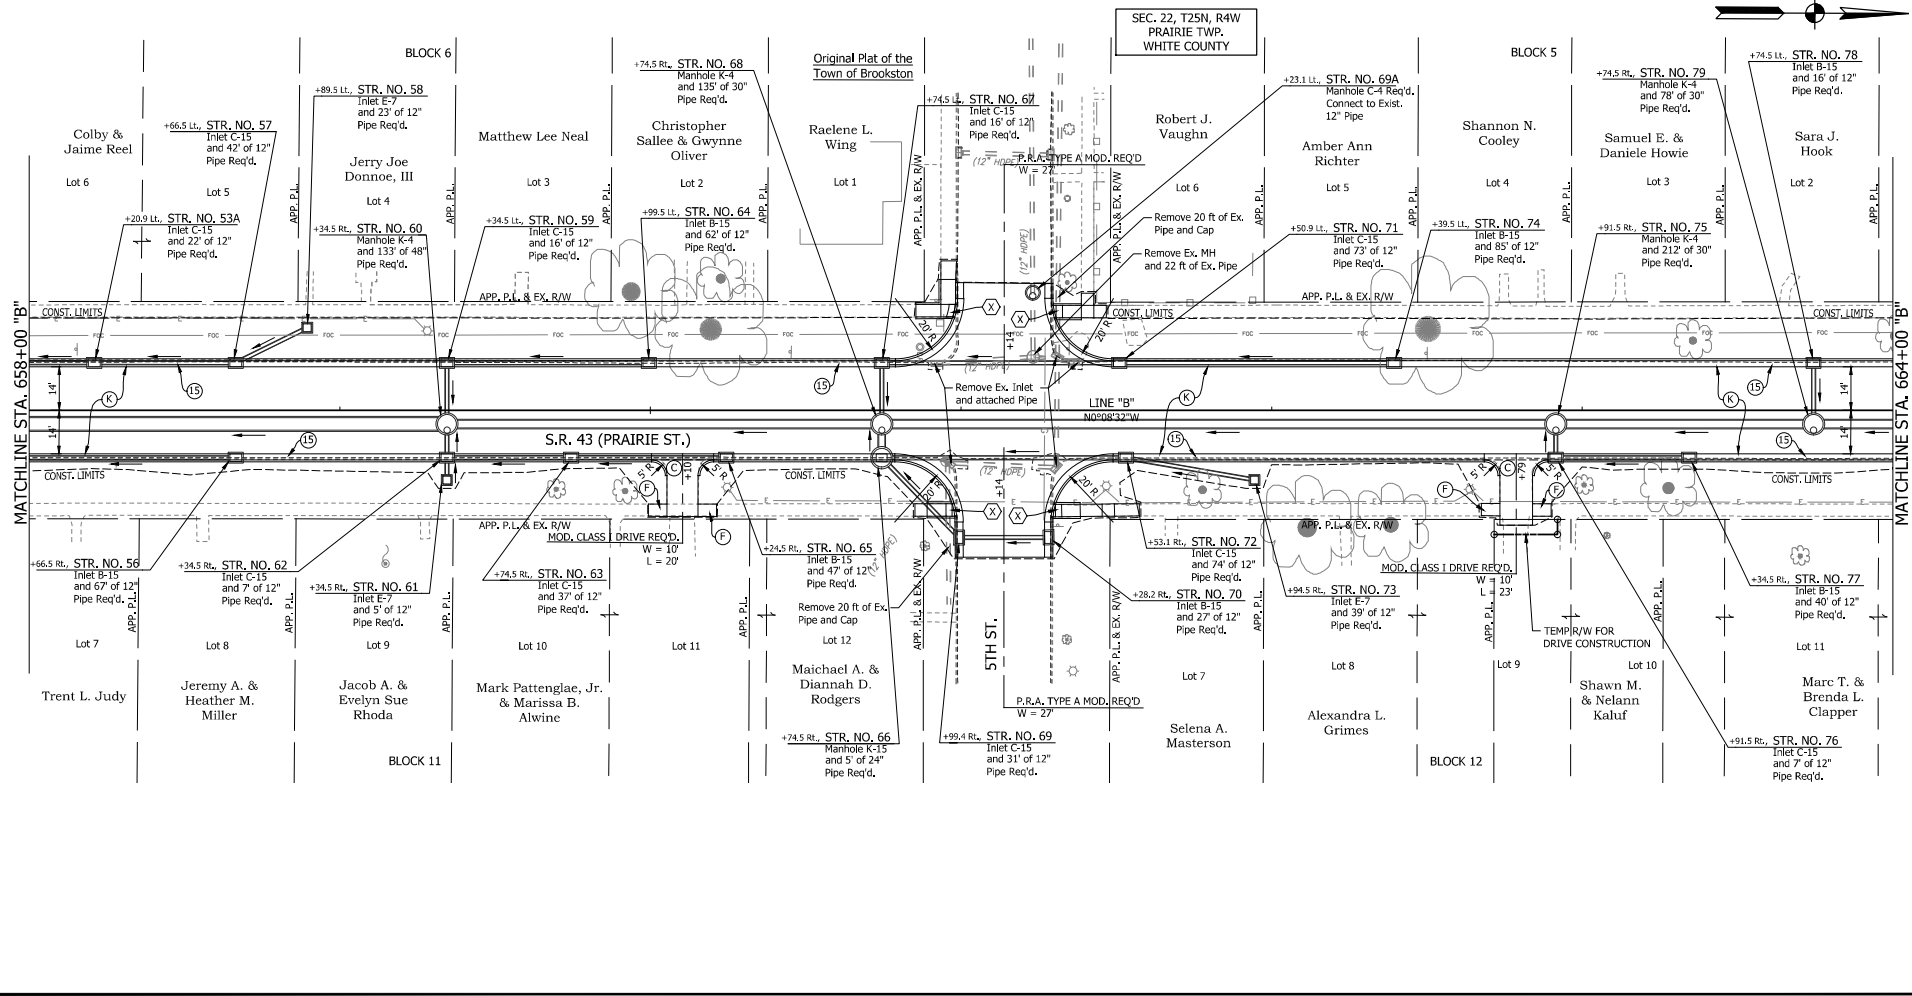

MATCHLINE STA. 658+00 "B"

MATCHLINE STA. 664+00 "B"

S.R. 43 (PRAIRIE ST.)

5TH ST.

SEC. 22, T25N, R4W  
PRAIRIE TWP.  
WHITE COUNTY

BLOCK 6

BLOCK 5

BLOCK 11

BLOCK 12

LEGEND			
(C)	Compacted Aggregate No. 73	(W)	Widening with HMA, Type C
(C)	PCCP for Approaches, 4"	(14)	Mod. Concrete Rolled Curb (Sloping)
(C)	PCCP for Approaches, 6"	(15)	Combined Concrete Curb & Gutter
(C)	PCCP for Approaches, 9"	(16)	Curb, Concrete (Vertical)
(C)	HMA for Approaches, Type B	(X)	Sidewalk Curb Ramp
(F)	Concrete Sidewalk, 4"		
(X)	Full Depth Asphalt Pavement (See Typical Sections)		
(14)	Full Depth Asphalt Pavement (See Typical Sections)		
(R)	Milling, Asphalt 1.5" (See Typical Sections)		


RECOMMENDED FOR APPROVAL	DESIGN ENGINEER	DATE
DESIGNED: <u>BLW</u>	DRAWN: <u>BEW</u>	
CHECKED: <u>DCK</u>	CHECKED: <u>DCK</u>	

INDIANA DEPARTMENT OF TRANSPORTATION	
CONSTRUCTION DETAILS	
STA. 658+00.00 TO 664+00.00 LINE "B"	

HORIZONTAL SCALE	BRIDGE FILE
1" = 20'	N/A
VERTICAL SCALE	DESIGNATION
N/A	2001828
SURVEY BOOK	SHEET
	37 of 117
CONTRACT	PROJECT
R-43449	2001828

PRINT DATE: 4/23/20  
 PLOT SCALE: 1" = 20'  
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 EDITED BY: DMRTY



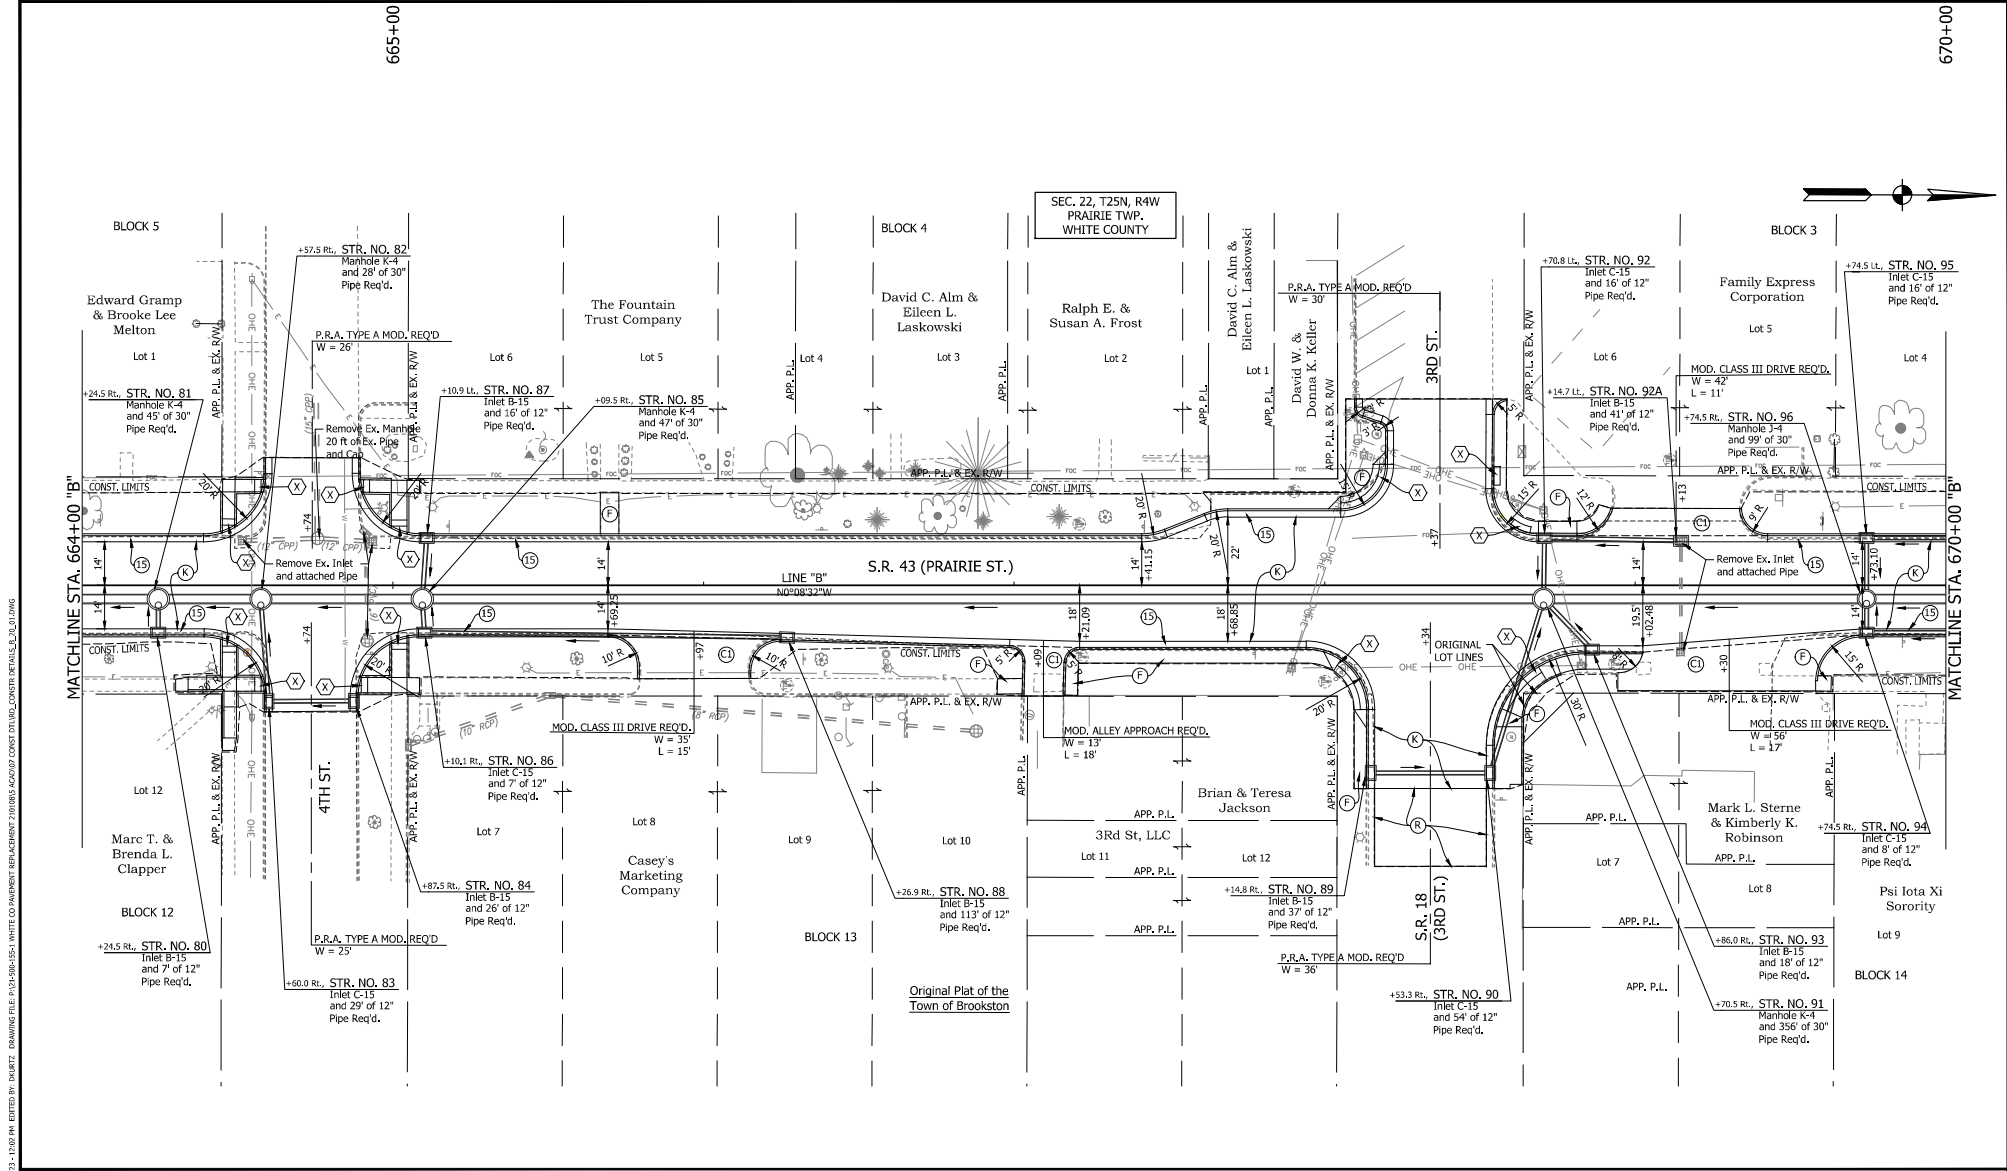


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 PLOT SCALE: 1:1

LEGEND			
⊙	Compacted Aggregate No. 73	Ⓜ	Widening with HMA, Type C
⊕	PCCP for Approaches, 6"	Ⓝ	Mod. Concrete Rolled Curb (Sloping)
⊖	PCCP for Approaches, 9"	Ⓞ	Combined Concrete Curb & Gutter
⊗	HMA for Approaches, Type B	Ⓟ	Curb, Concrete (Vertical)
Ⓛ	Concrete Sidewalk, 4"	Ⓡ	Milling, Asphalt 1.5" (See Typical Sections)
Ⓧ	Full Depth Asphalt Pavement (See Typical Sections)	Ⓢ	Sidewalk Curb Ramp
Ⓨ	Full Depth Asphalt Pavement (See Typical Sections)		

RECOMMENDED FOR APPROVAL	DESIGN ENGINEER	DATE
DESIGNED: <u>BLW</u>	DRAWN: <u>BEW</u>	
CHECKED: <u>DCK</u>	CHECKED: <u>DCK</u>	

**INDIANA DEPARTMENT OF TRANSPORTATION**  
**CONSTRUCTION DETAILS**  
**STA. 664+00.00 TO 670+00.00 LINE "B"**

HORIZONTAL SCALE	BRIDGE FILE
1" = 20'	N/A
VERTICAL SCALE	DESIGNATION
N/A	2001828
SURVEY BOOK	SHEET
	38 of 117
CONTRACT	PROJECT
R-43449	2001828

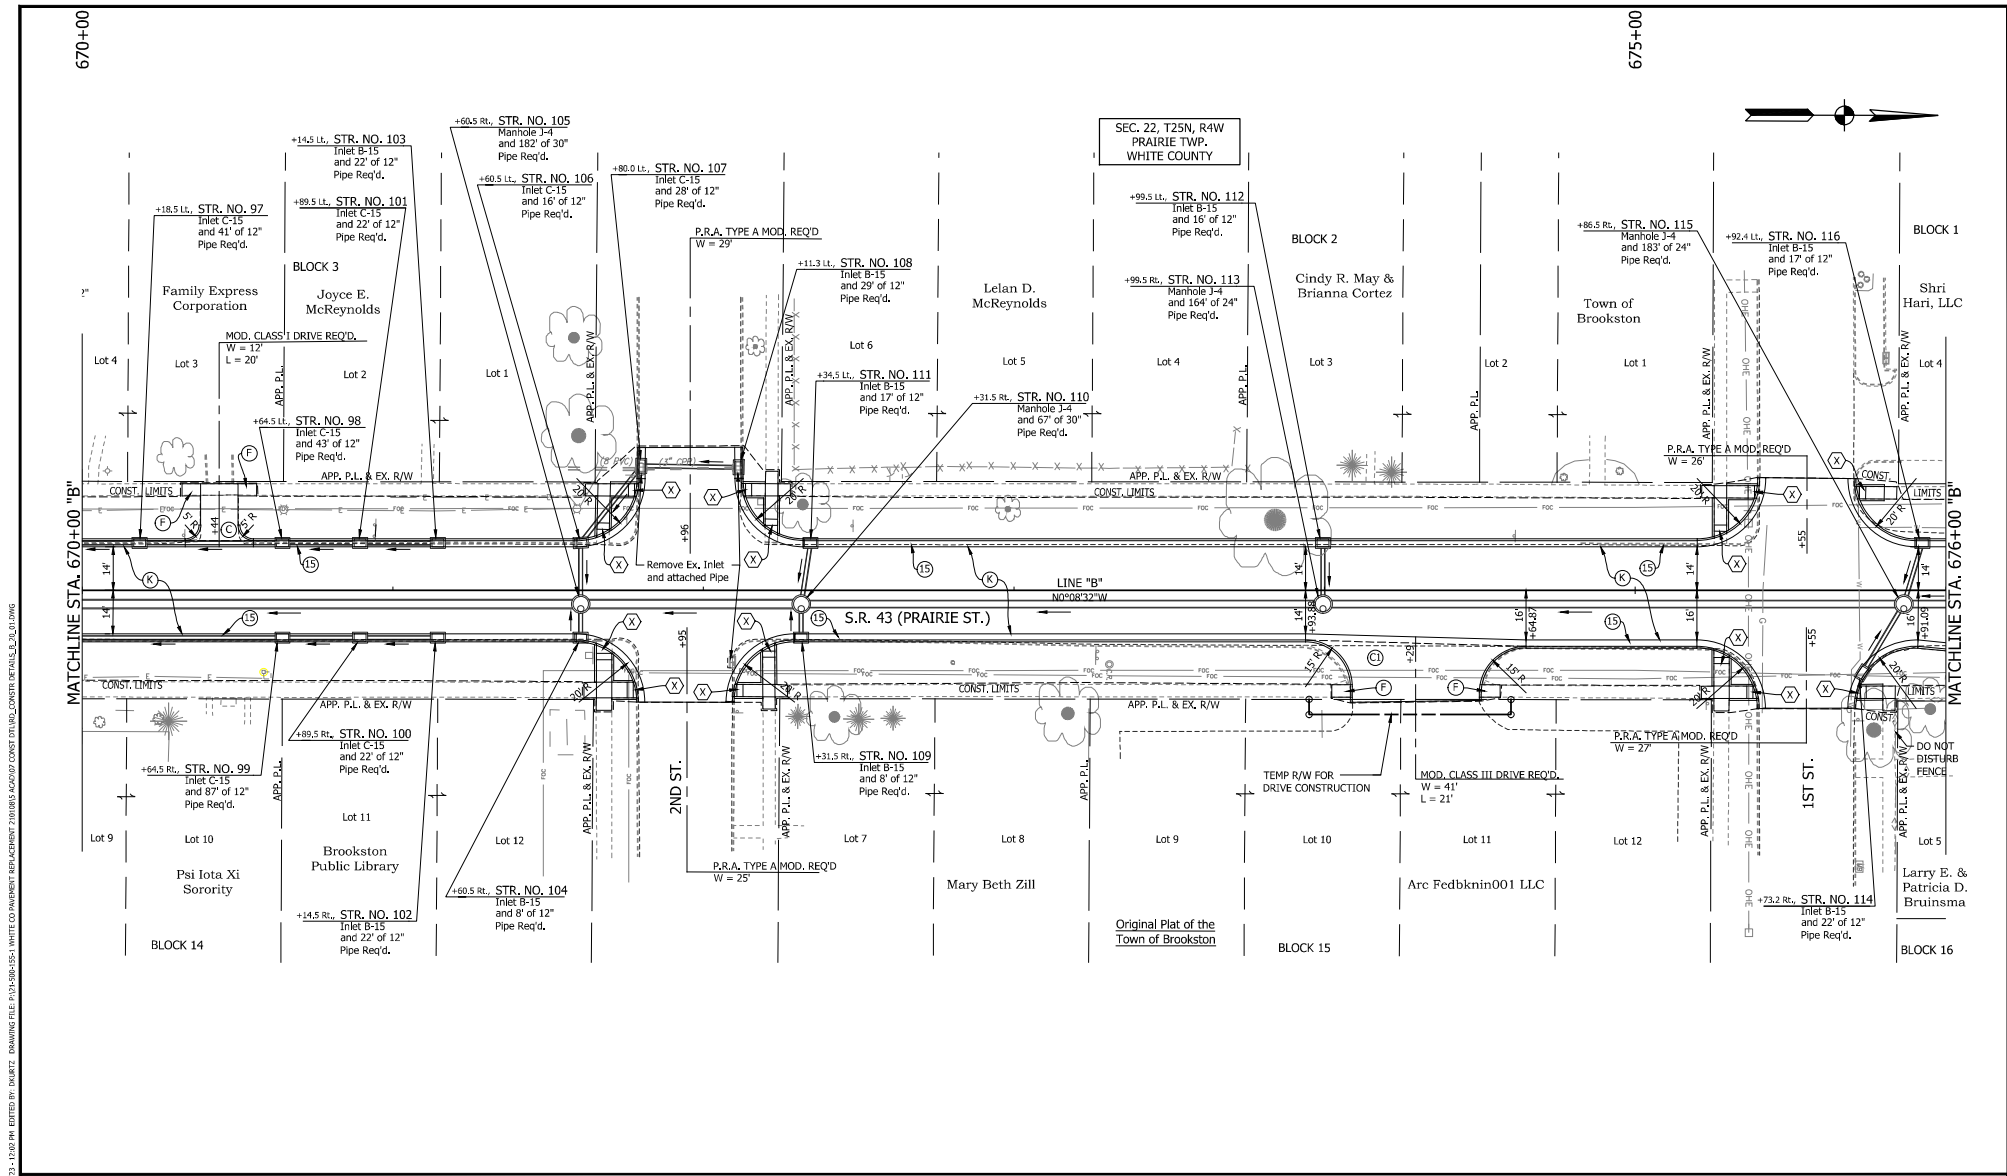

PRINT DATE: 4/23/23 11:20 AM EDITED BY: DMRTZ DRAWING FILE: F:\23\08\05\1 WHITE CO\INVENTORY\REPAIRMENT\2001828\ASPH\CONSTR\DETAILS\B.DWG  
 PLOT SCALE: 1:1


LEGEND	
(C)	Compacted Aggregate No. 73
(F)	Concrete Sidewalk, 4"
(P)	PCCP for Approaches, 6"
(C)	PCCP for Approaches, 9"
(H)	HMA for Approaches, Type B
(W)	Widening with HMA, Type C
(14)	Mod. Concrete Rolled Curb (Sloping)
(15)	Combined Concrete Curb & Gutter
(16)	Curb, Concrete (Vertical)
(X)	Sidewalk Curb Ramp
(X)	Remove Ex. Inlet and attached Pipe

RECOMMENDED FOR APPROVAL	DESIGN ENGINEER	DATE
DESIGNED: <u>BLW</u>	DRAWN: <u>BEW</u>	
CHECKED: <u>DCK</u>	CHECKED: <u>DCK</u>	

**INDIANA DEPARTMENT OF TRANSPORTATION**  
**CONSTRUCTION DETAILS**  
**STA. 670+00.00 TO 676+00.00 LINE "B"**

HORIZONTAL SCALE	1" = 20'	BRIDGE FILE	N/A
VERTICAL SCALE	N/A	DESIGNATION	2001828
SURVEY BOOK		SHEET	39 of 117
CONTRACT	R-43449	PROJECT	2001828

PRINT DATE: 9/23/23 11:20 AM EDITOR: DWMTY DRAWING FILE: I:\13080151\WHITE CO\INVENTORY\REPLACEMENT\2001828\DETAILS\DWG\_111.DWG  
 PLOT SCALE: 1.1

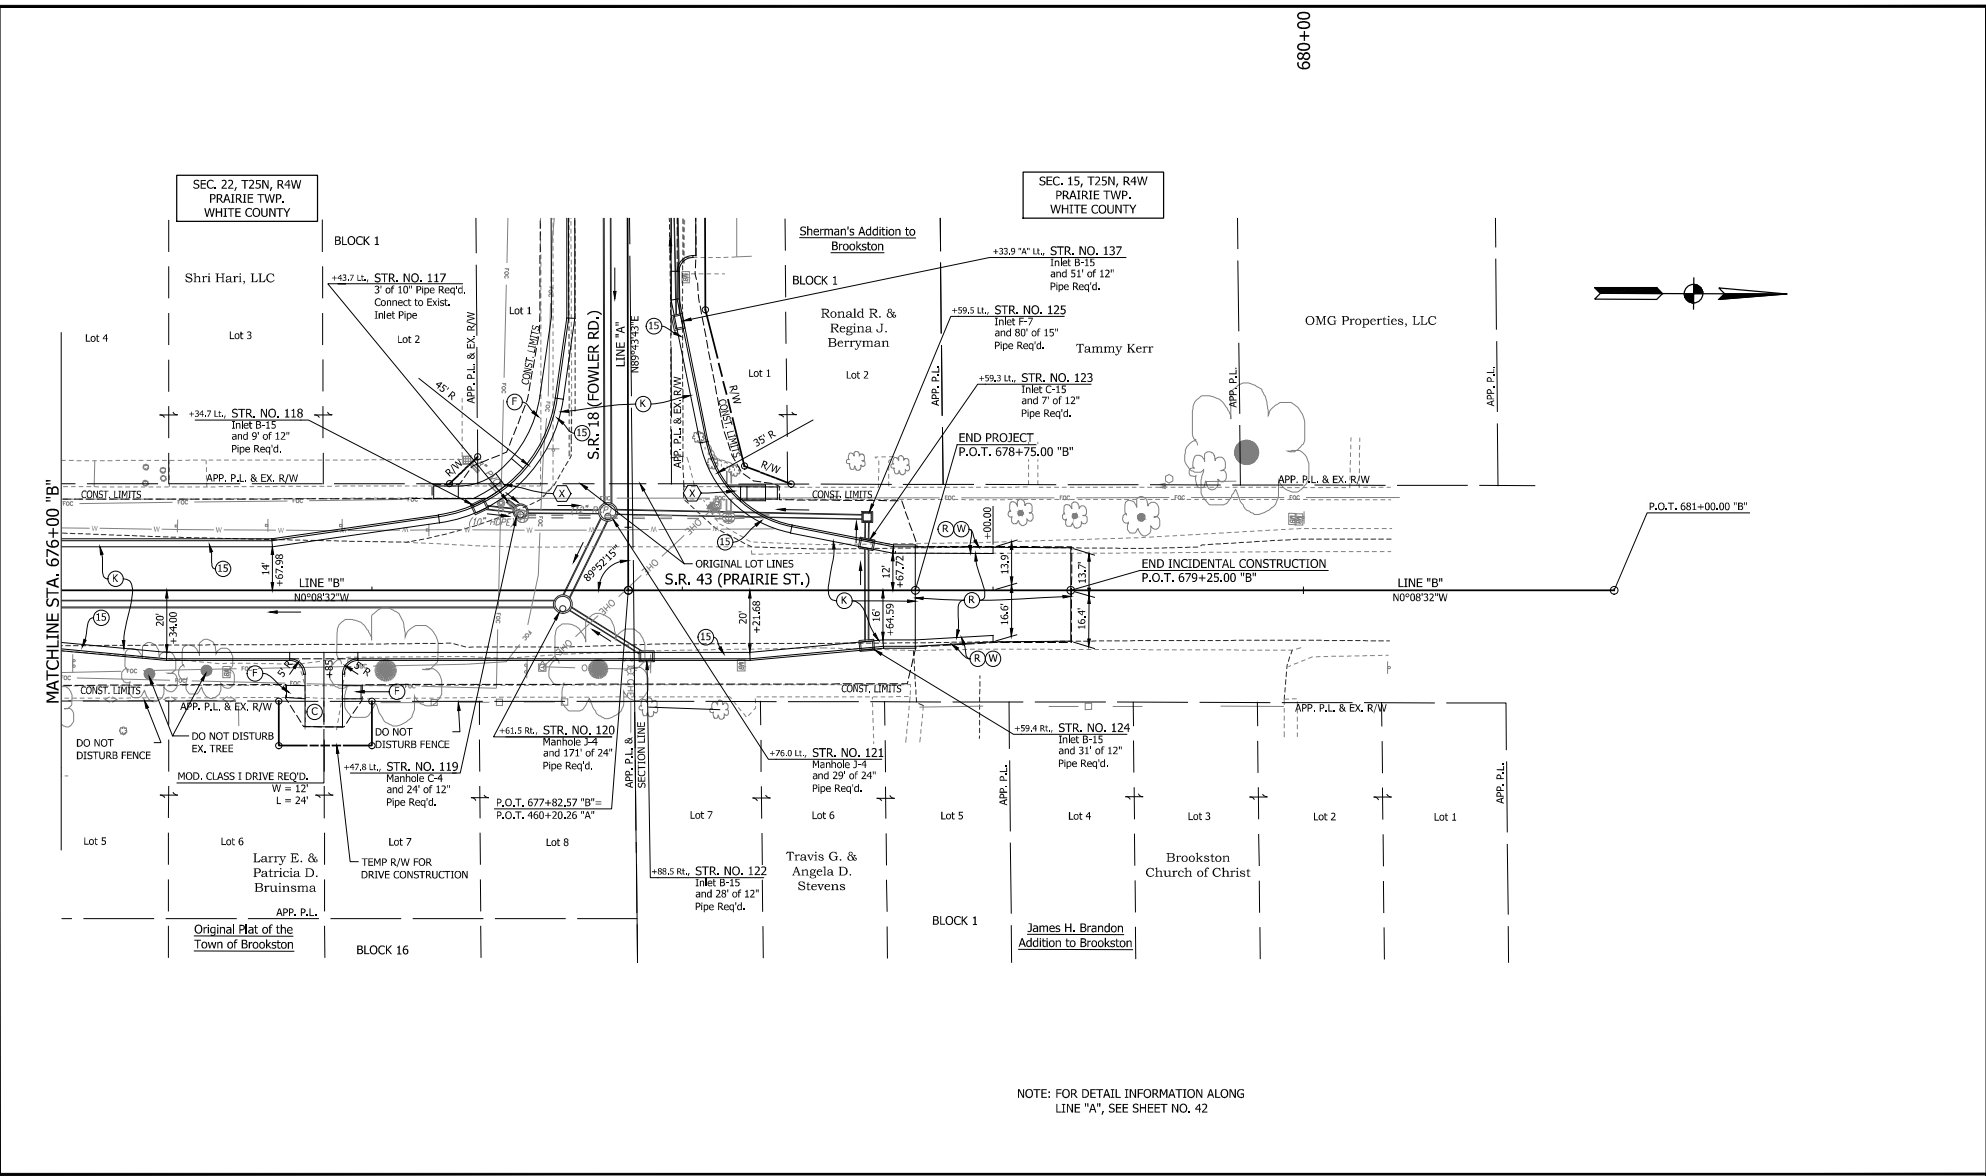


NOTE: FOR DETAIL INFORMATION ALONG LINE "A", SEE SHEET NO. 42

LEGEND	
(C)	Compacted Aggregate No. 73
(C)	PCCP for Approaches, 6"
(C)	PCCP for Approaches, 9"
(C)	HMA for Approaches, Type B
(F)	Concrete Sidewalk, 4"
(X)	Full Depth Asphalt Pavement (See Typical Sections)
(X)	Full Depth Asphalt Pavement (See Typical Sections)
(R)	Milling, Asphalt 1.5" (See Typical Sections)
(W)	Widening with HMA, Type C
(14)	Mod. Concrete Rolled Curb (Sloping)
(15)	Combined Concrete Curb & Gutter
(16)	Curb, Concrete (Vertical)
(X)	Sidewalk Curb Ramp

RECOMMENDED FOR APPROVAL	DESIGN ENGINEER	DATE
DESIGNED: <u>BLW</u>	DRAWN: <u>BEW</u>	
CHECKED: <u>DCK</u>	CHECKED: <u>DCK</u>	

INDIANA DEPARTMENT OF TRANSPORTATION	
CONSTRUCTION DETAILS STA. 676+00.00 TO 681+00.00 LINE "B"	

HORIZONTAL SCALE	BRIDGE FILE
1" = 20'	N/A
VERTICAL SCALE	DESIGNATION
N/A	2001828
SURVEY BOOK	SHEET
	40 of 117
CONTRACT	PROJECT
R-43449	2001828

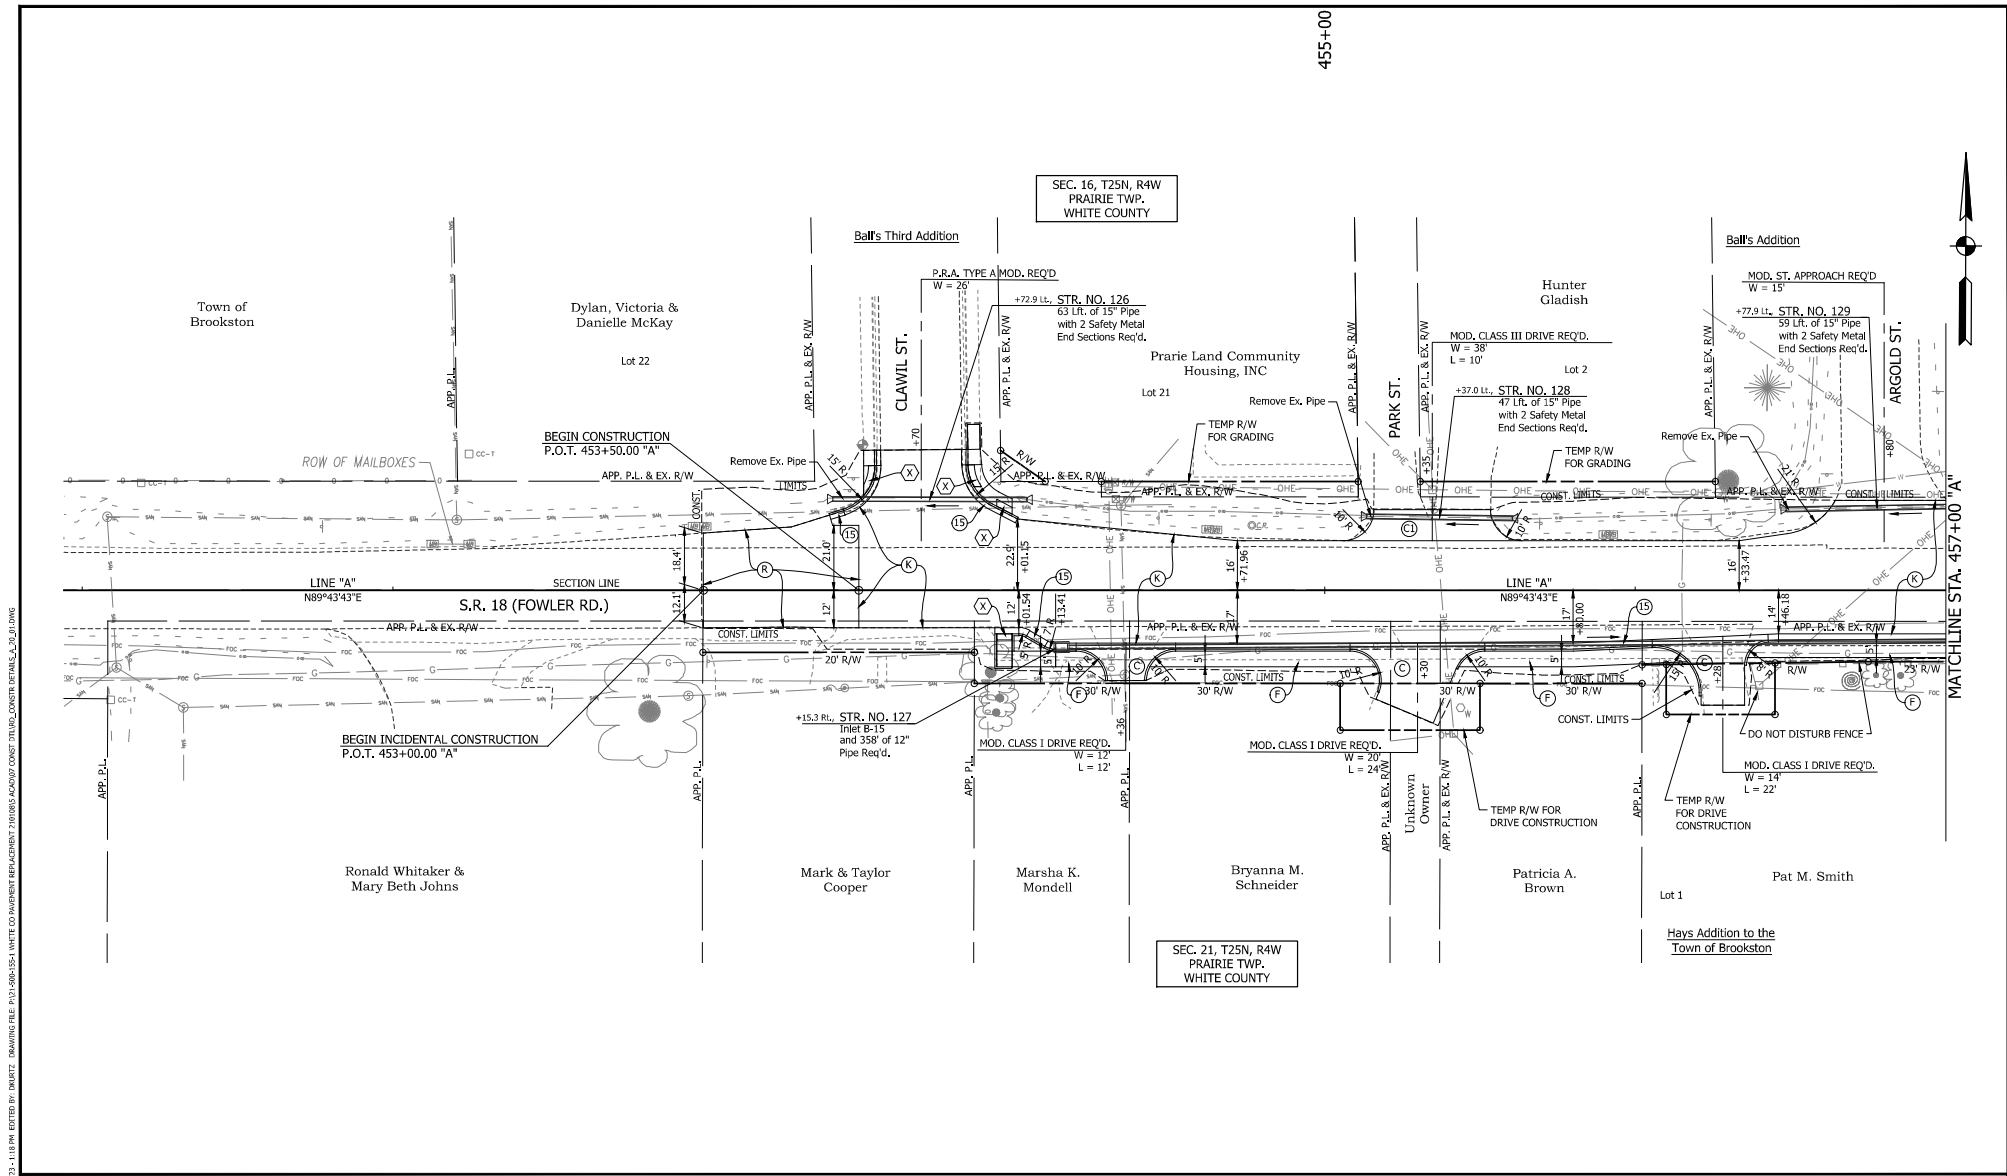

PRINT DATE: 9/23/23 11:18 AM; DRAWING FILE: P:\11000\1101\WHITE CO\ROADS\REPLACEMENT\210000\ASPHALT\CONST\211101\CONSTR\DETAILS\_A\_P01.DWG  
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 DATE: 9/23/23 11:18 AM; EDITED BY: DINKET; DRAWING FILE: P:\11000\1101\WHITE CO\ROADS\REPLACEMENT\210000\ASPHALT\CONST\211101\CONSTR\DETAILS\_A\_P01.DWG


LEGEND			
(C)	Compacted Aggregate No. 73	(W)	Widening with HMA, Type C
(C)	PCCP for Approaches, 6"	(14)	Mod. Concrete Rolled Curb (Sloping)
(C)	PCCP for Approaches, 9"	(15)	Combined Concrete Curb & Gutter
(C)	HMA for Approaches, Type B	(16)	Curb, Concrete (Vertical)
(X)	Concrete Sidewalk, 4"	(X)	Sidewalk Curb Ramp
(X)	Full Depth Asphalt Pavement (See Typical Sections)		
(X)	Full Depth Asphalt Pavement (See Typical Sections)		
(R)	Milling, Asphalt 1.5" (See Typical Sections)		

RECOMMENDED FOR APPROVAL	DESIGN ENGINEER	DATE
DESIGNED: <u>BLW</u>	DRAWN: <u>BEW</u>	
CHECKED: <u>DCK</u>	CHECKED: <u>DCK</u>	

INDIANA DEPARTMENT OF TRANSPORTATION	
CONSTRUCTION DETAILS	
STA. 451+00.00 TO 457+00.00 LINE "A"	

HORIZONTAL SCALE	BRIDGE FILE
1" = 20'	N/A
VERTICAL SCALE	DESIGNATION
N/A	2001828
SURVEY BOOK	SHEET
41	of 117
CONTRACT	PROJECT
R-43449	2001828

PRINT DATE: 4/23/23  
 PLOT SCALE: 1" = 118.8' (NOTED BY: DANKET) DRAWING FILE: P:\11000\151 WHITE CO RAMPARTS REPLACEMENT 2\100000\44000\CONSTR\211111\CONSTR\DETAILS\A\_PU-BUILDING

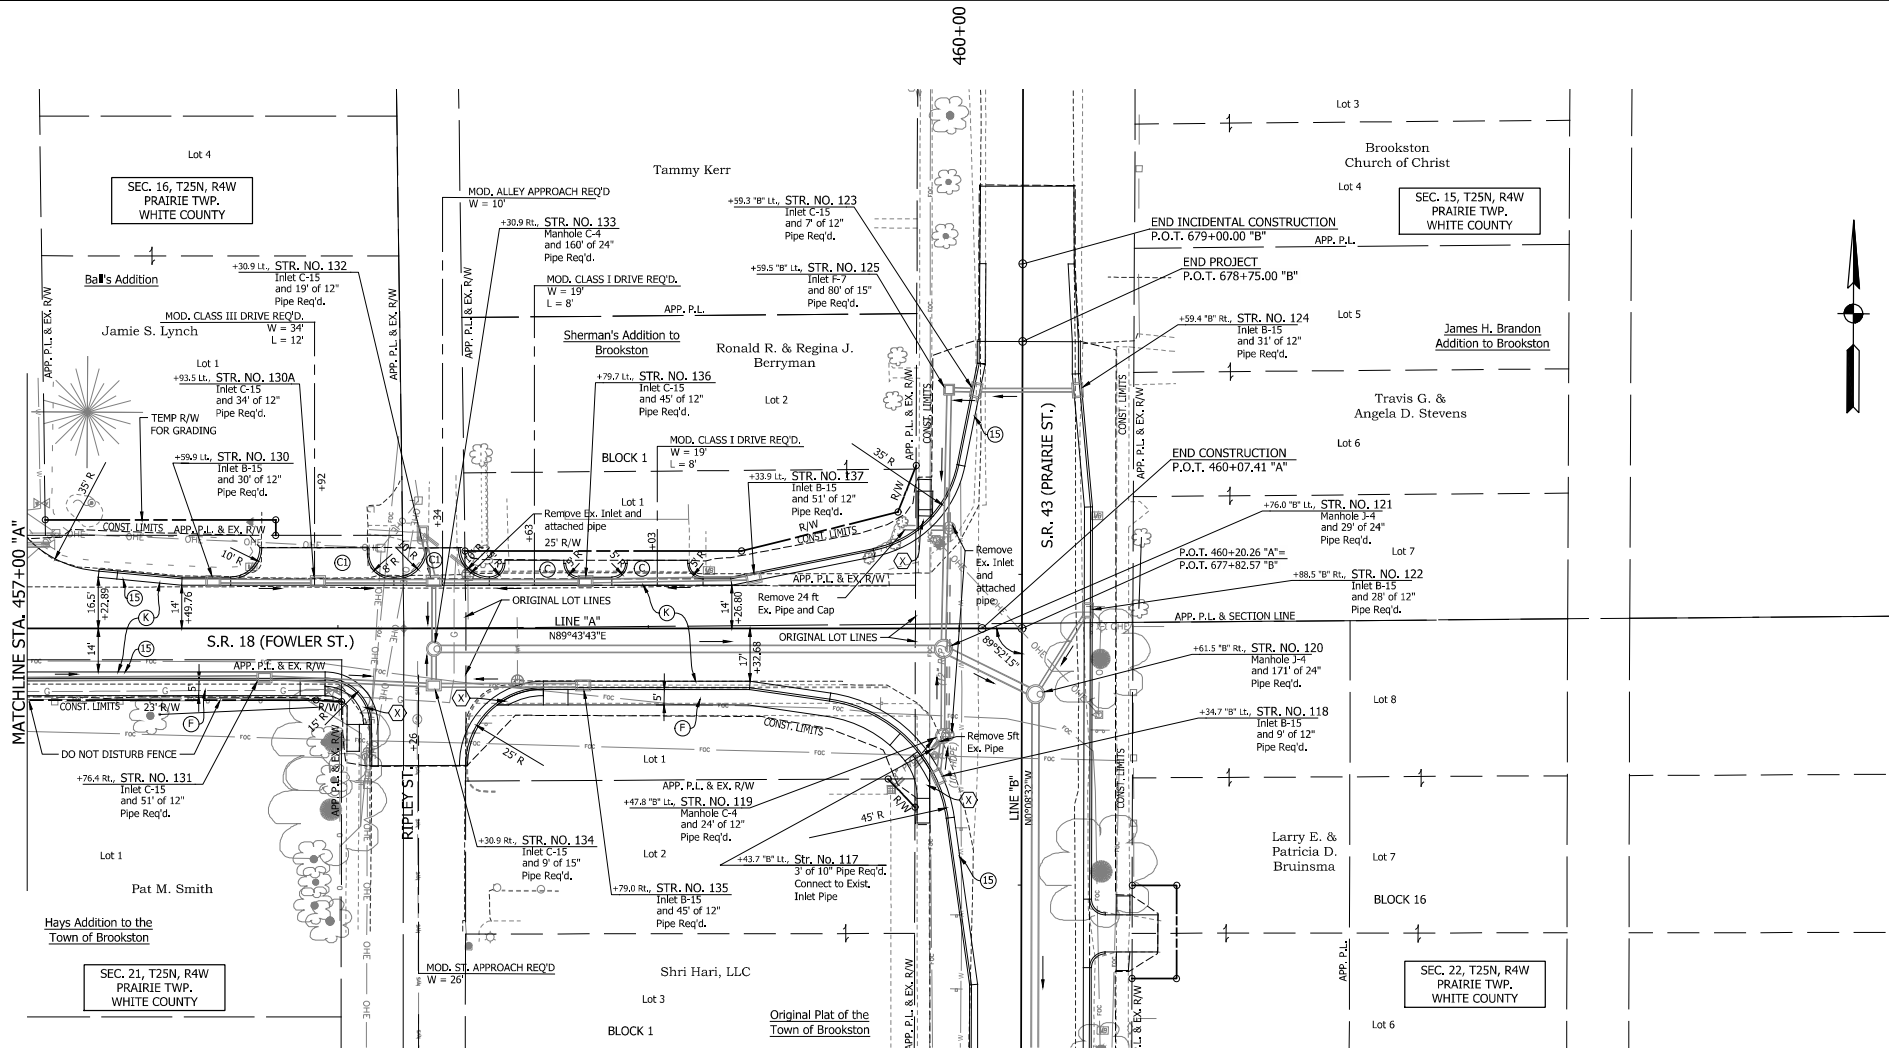

460+00



NOTE: FOR DETAIL INFORMATION ALONG LINE "B", SEE SHEET NO. 40

LEGEND	
(C) Compacted Aggregate No. 73	(F) Concrete Sidewalk, 4"
(P) PCCP for Approaches, 6"	(X) Full Depth Asphalt Pavement (See Typical Sections)
(E) PCCP for Approaches, 9"	(14) Mod. Concrete Rolled Curb (Sloping)
(D) HMA for Approaches, Type B	(15) Combined Concrete Curb & Gutter
	(16) Full Depth Asphalt Pavement (See Typical Sections)
	(17) Curb, Concrete (Vertical)
	(R) Milling, Asphalt 1.5" (See Typical Sections)
	(X) Sidewalk Curb Ramp

RECOMMENDED FOR APPROVAL	DESIGN ENGINEER	DATE
DESIGNED: <u>BLW</u>	DRAWN: <u>BEW</u>	
CHECKED: <u>DCK</u>	CHECKED: <u>DCK</u>	

**INDIANA DEPARTMENT OF TRANSPORTATION**  
**CONSTRUCTION DETAILS**  
 STA. 457+00.00 TO 460+20.26 LINE "A"

HORIZONTAL SCALE	BRIDGE FILE
1" = 20'	N/A
VERTICAL SCALE	DESIGNATION
N/A	2001828
SURVEY BOOK	SHEET
	42 of 117
CONTRACT	PROJECT
R-43449	2001828